


1 FRONT (SOUTH) ELEVATION

Scale 1:100

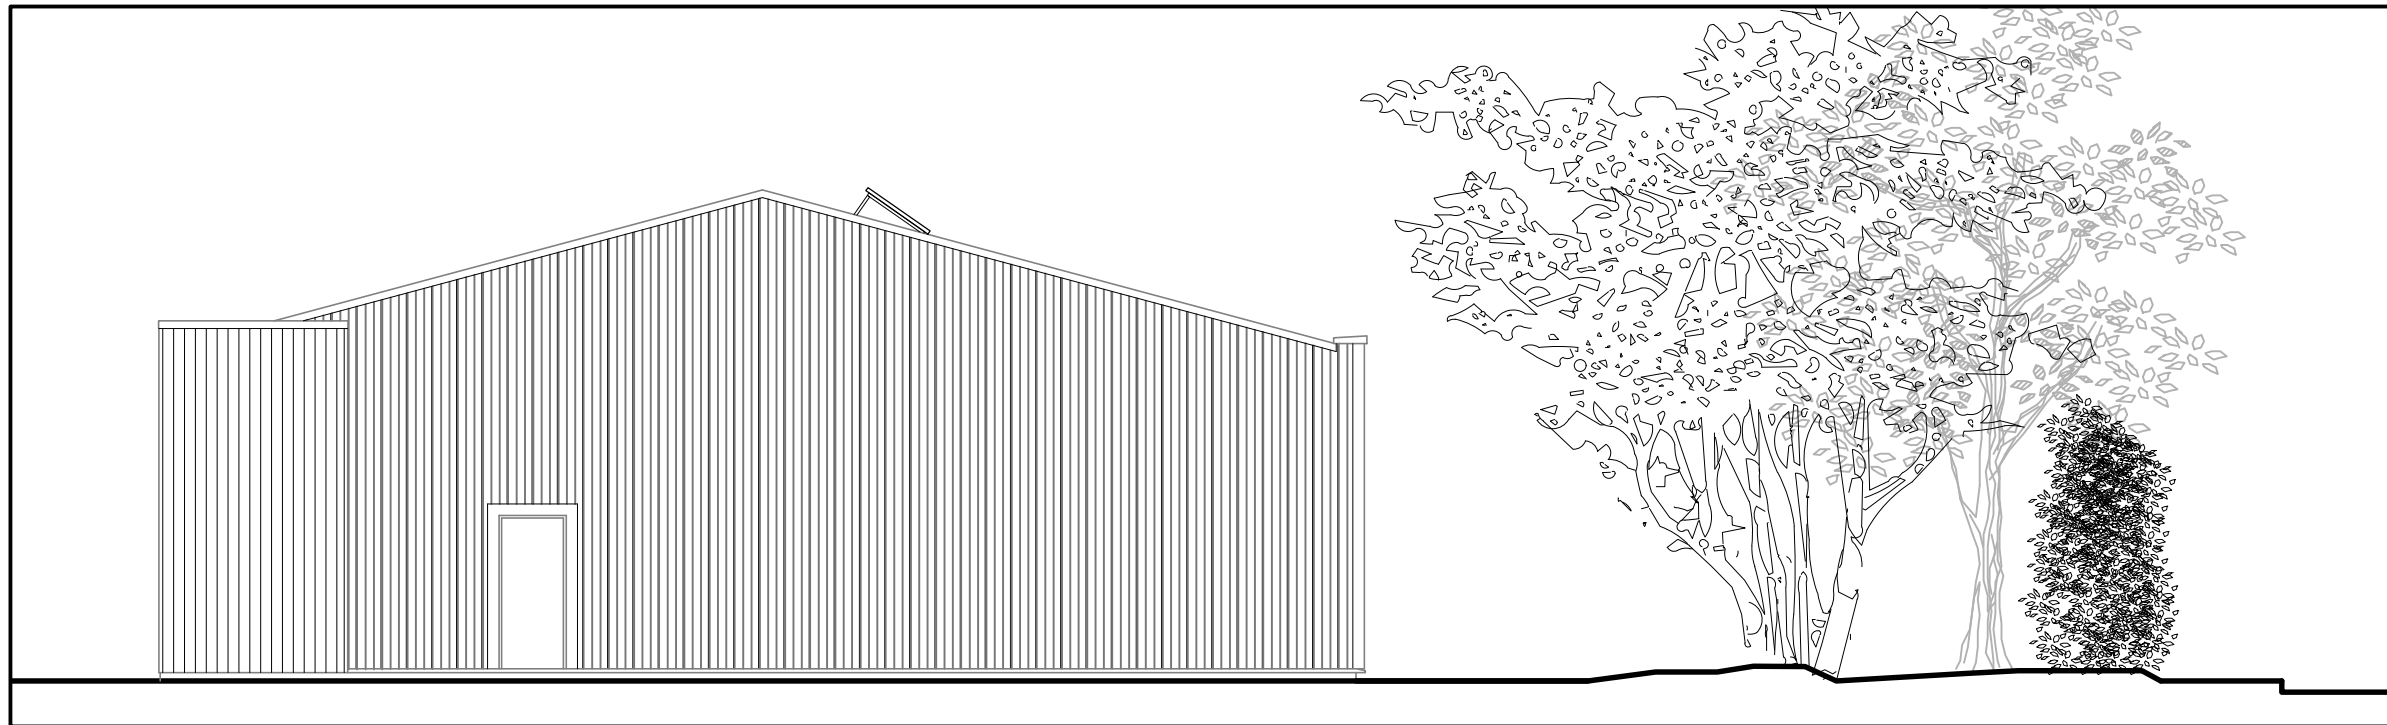

2 SIDE (WEST) ELEVATION

Scale 1:100

EXTERNAL MATERIALS NOTES:

PROFILED STEEL CLADDING (to south, west and east elevations and roof):
Insulated panel system, Kingspan Quadcore or similar; powder coated RAL 6013

TIMBER CLADDING (to north elevation):
Vertical pre-weathered Siberian larch boards, 20x120mm with t&g profile.

PLINTH (below DPC to all elevations):
Staffordshire blue engineering brick

WINDOWS:
Single glazed with colour coated aluminium frames, colour: RAL 7016

DOORS:
Vehicle door: insulated sectional overhead door with glazed panels and wicket door, powder coated, colour: RAL 7016
Personnel door: colour coated steel, colour: RAL 7016



SCALE 1:100

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REV.	DATE	DESCRIPTION	REV. BY
SR		DW	DW

PROJECT
PROPOSED GARAGE
BELMONT, LANGLEY

CLIENT
MR & MRS BRASS

DRAWING TITLE
PROPOSED
SOUTH AND WEST ELEVATIONS

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SCALES 1:100 @A3	DRAWING DATE 24/08/2023
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DRAWING No. 23002	Project No. P/004	Rev. P1
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DRAWING STATUS
PLANNING