





Existing Side (East) Elevation




Existing Side (West) Elevation

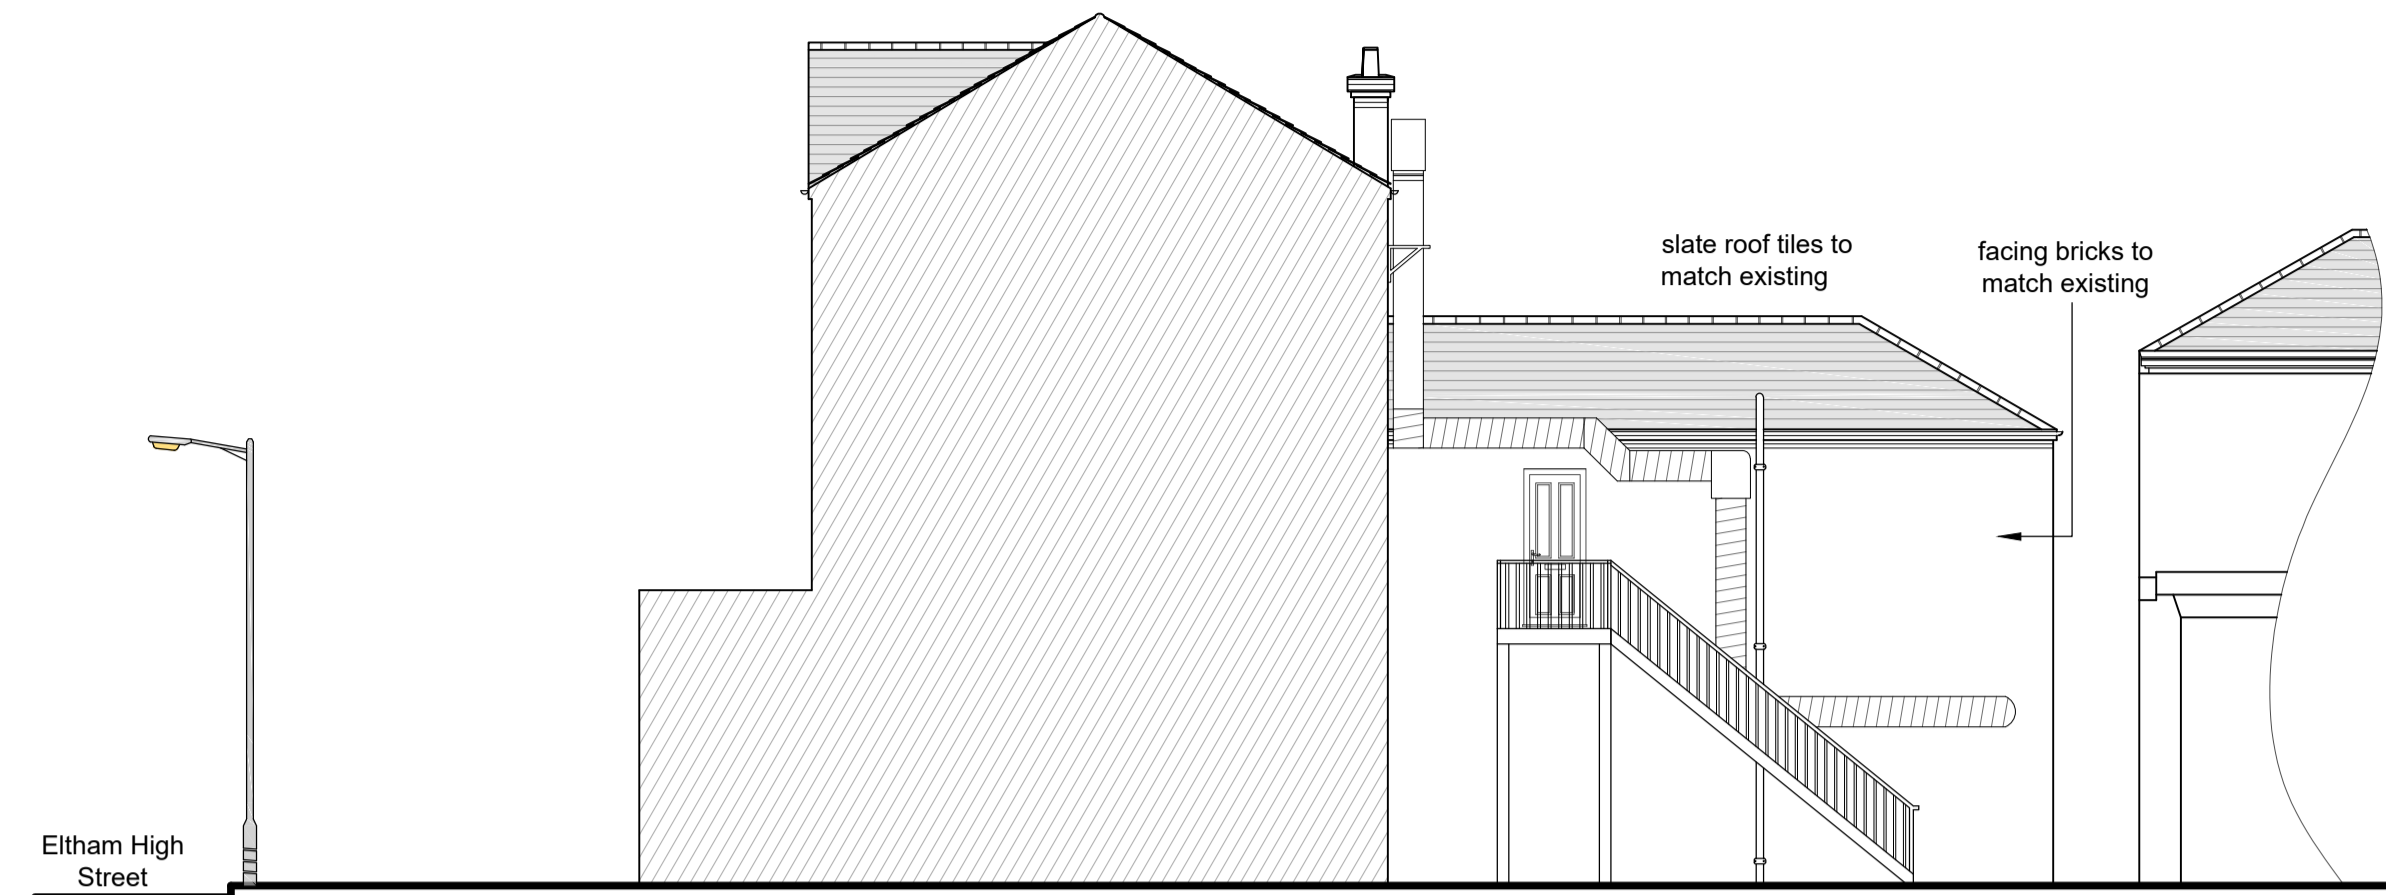


Proposed Side (East) Elevation

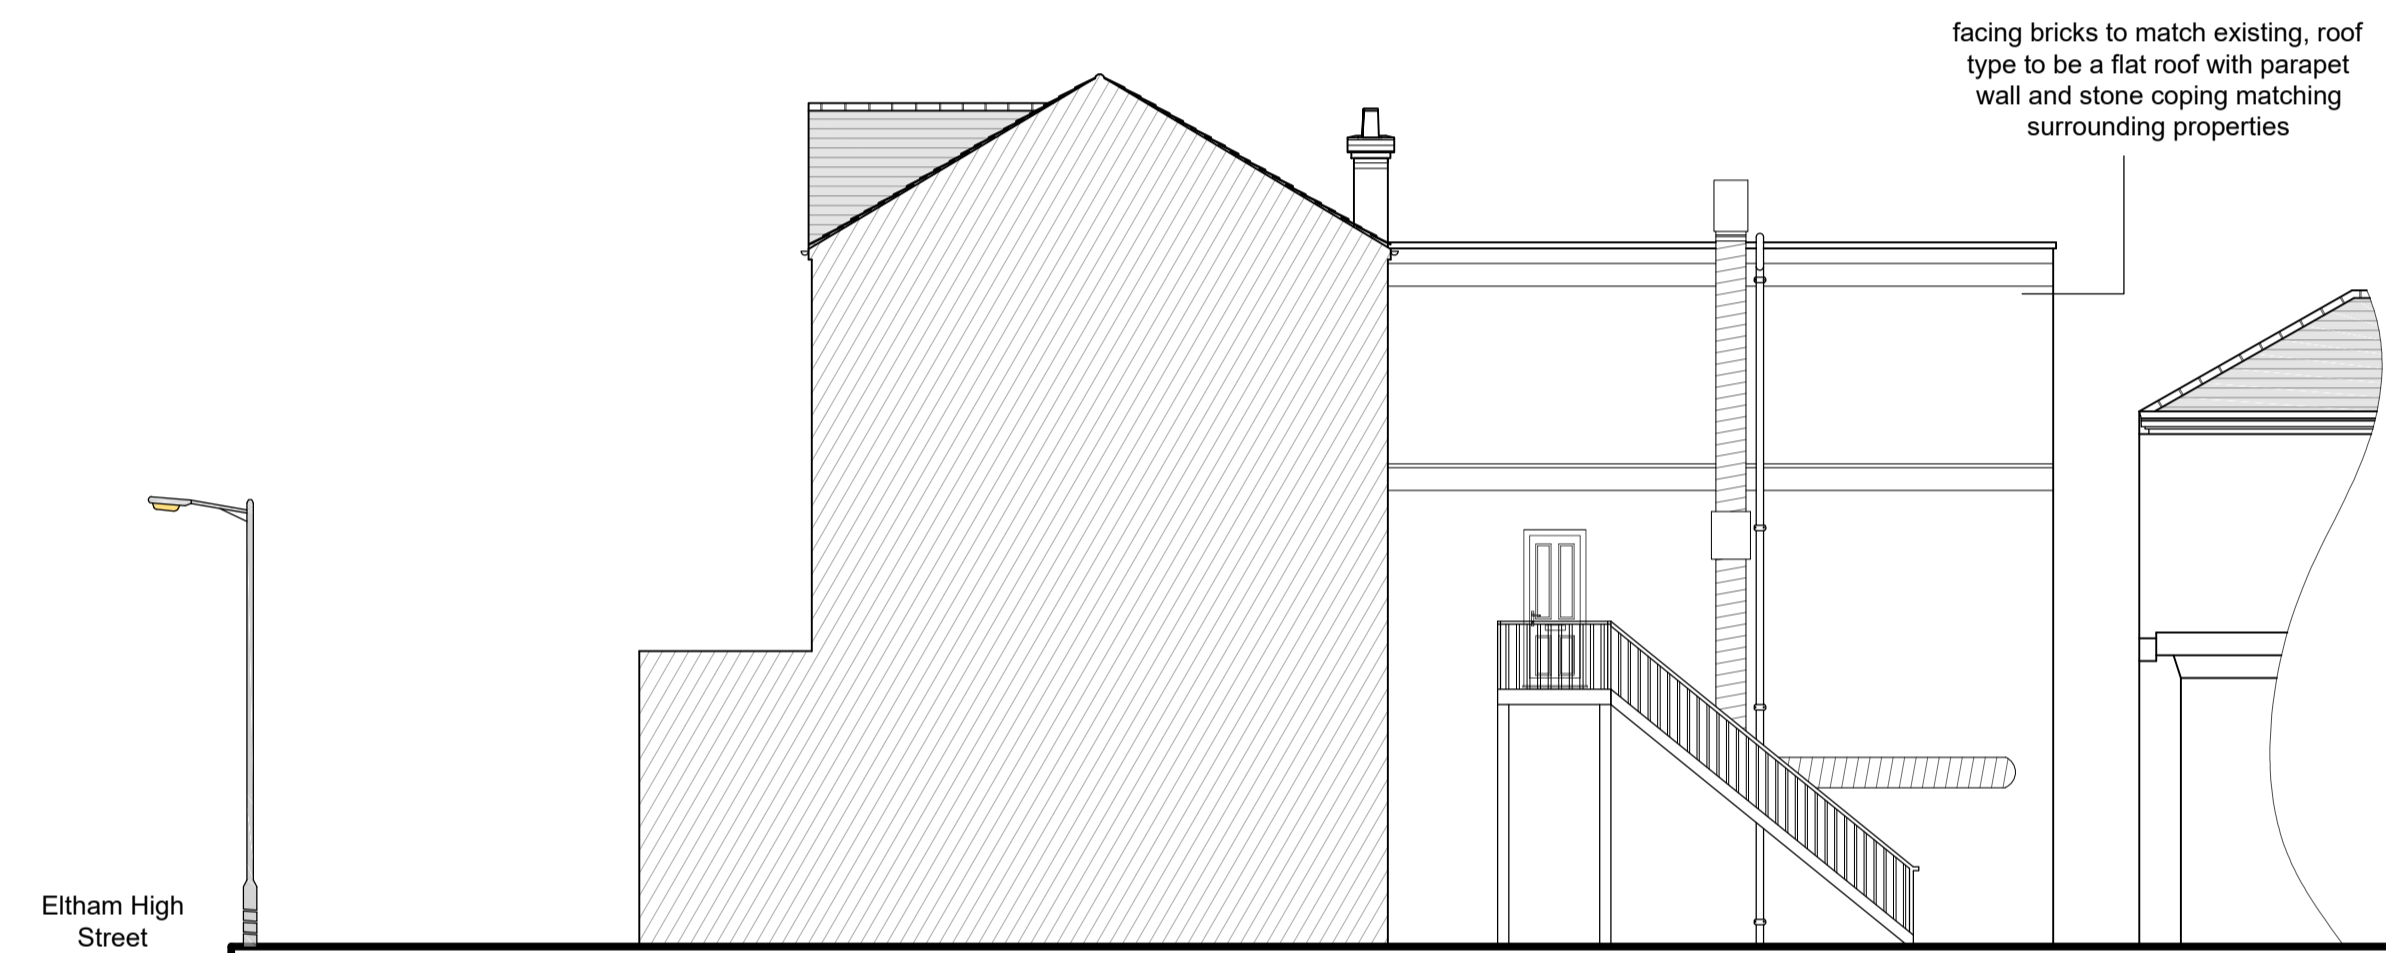


Proposed Side (West) Elevation

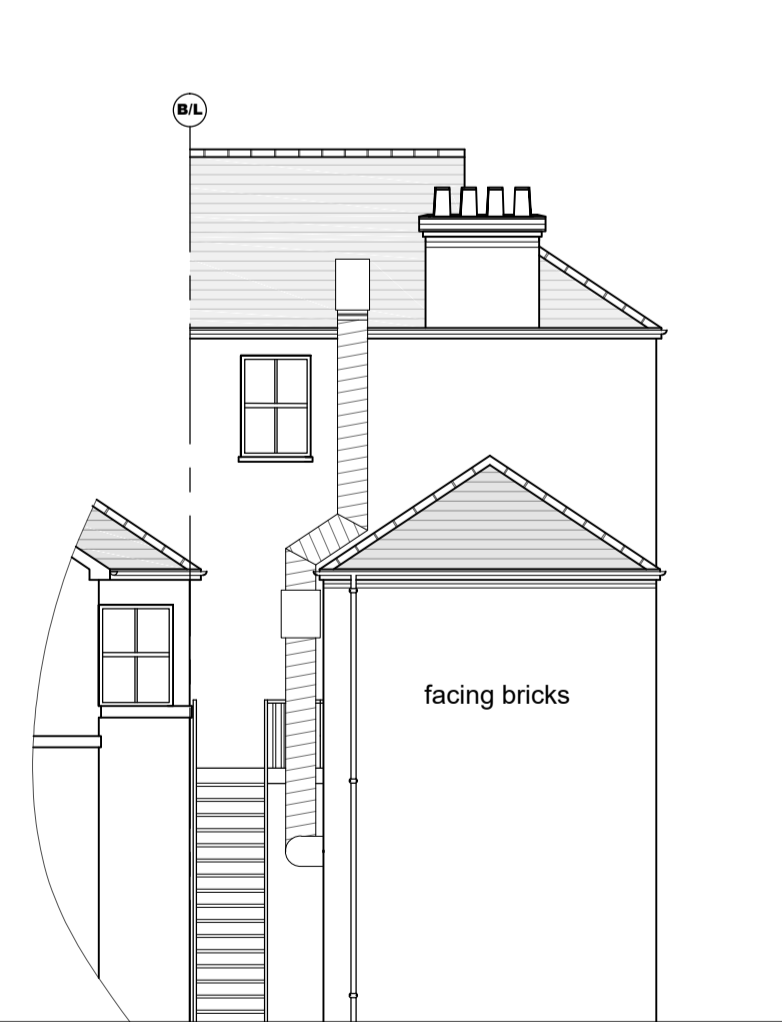


Existing Rear Elevation

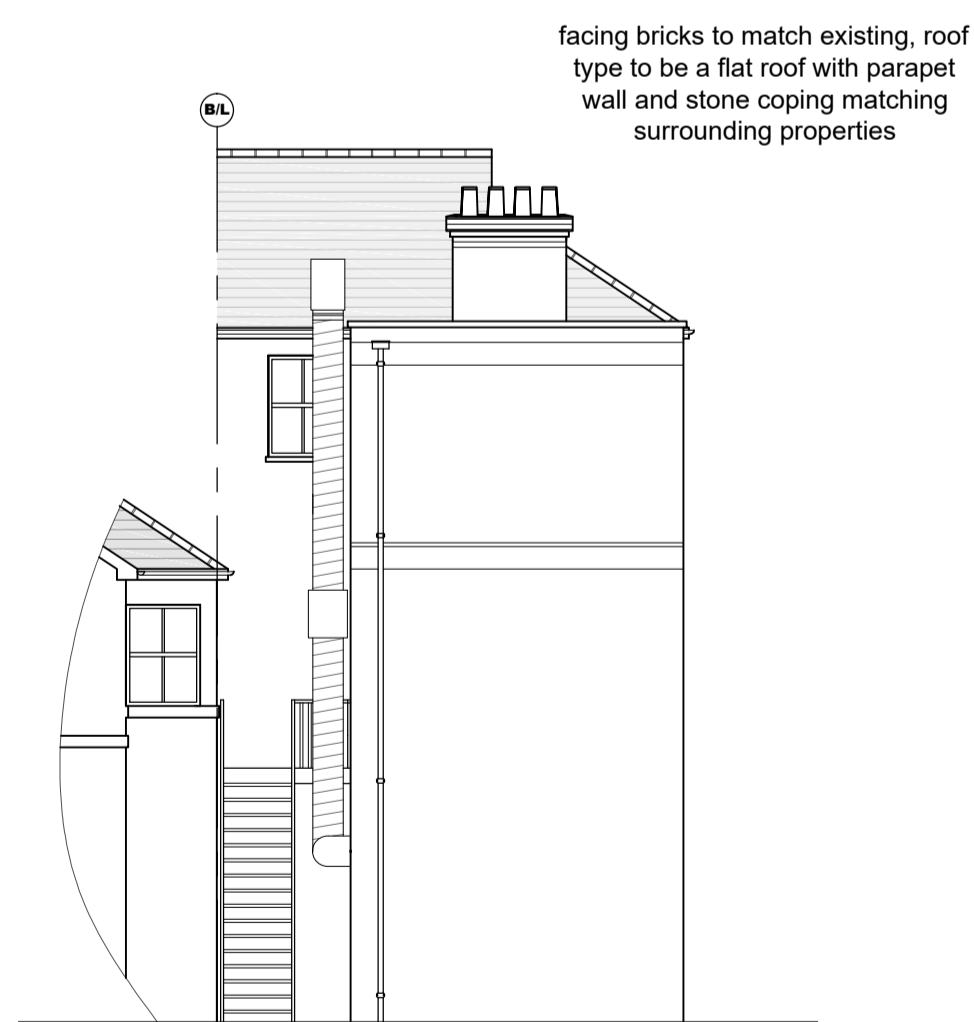


Proposed Rear Elevation

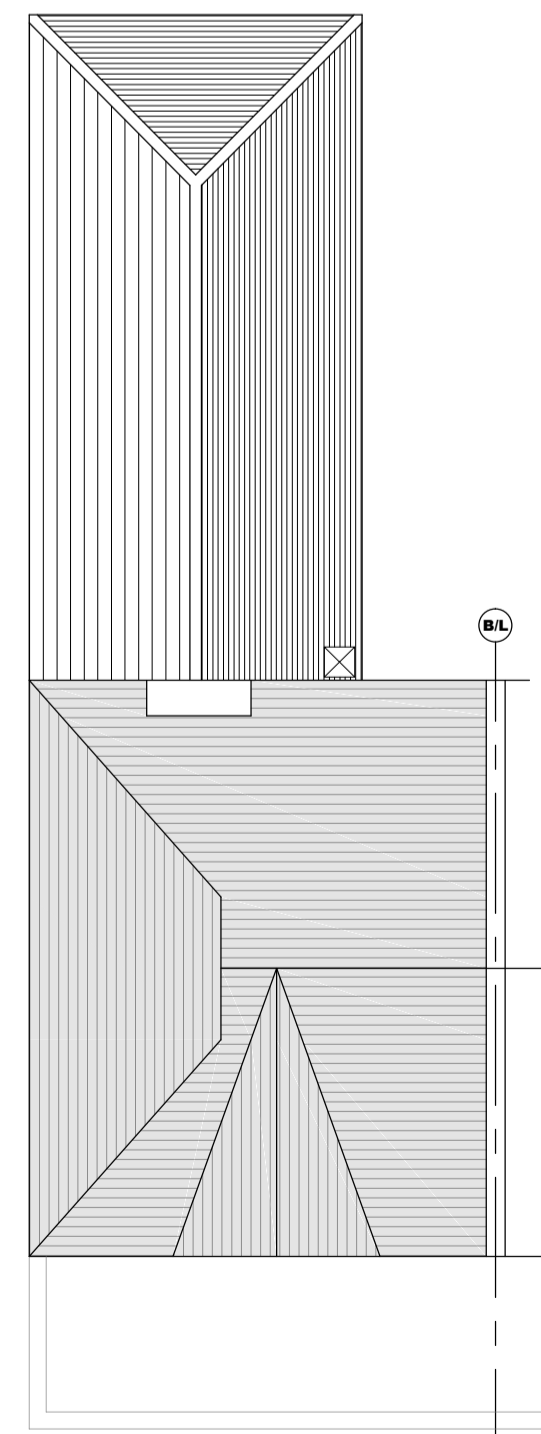

Existing Roof Plan

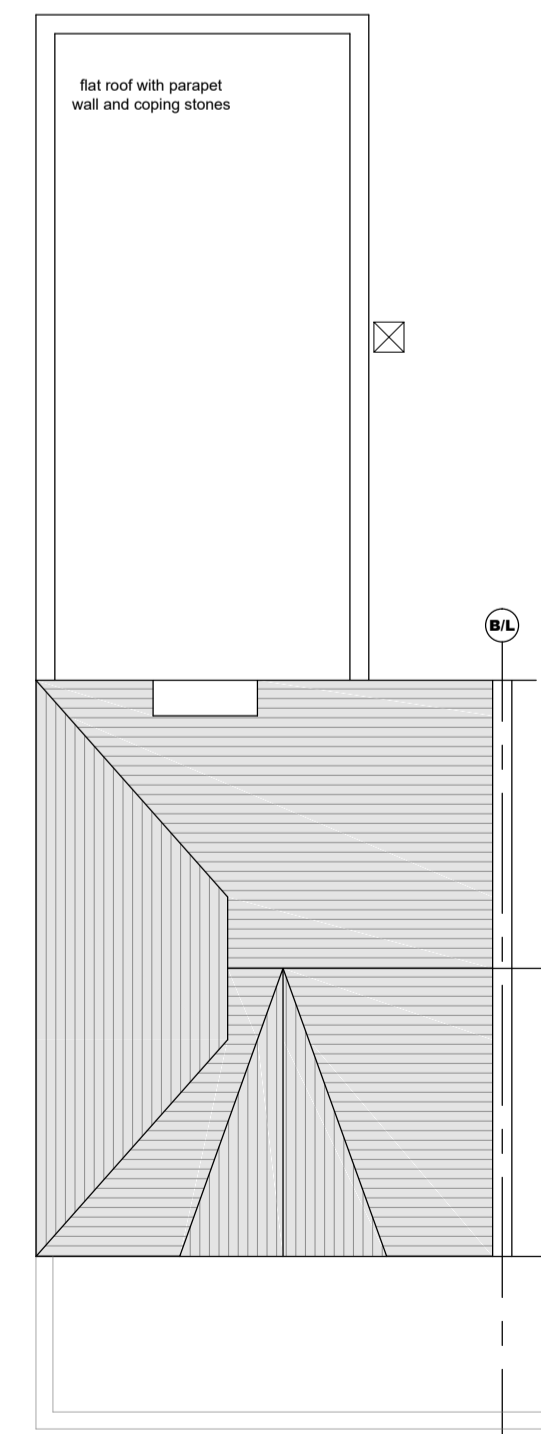

Proposed Roof Plan

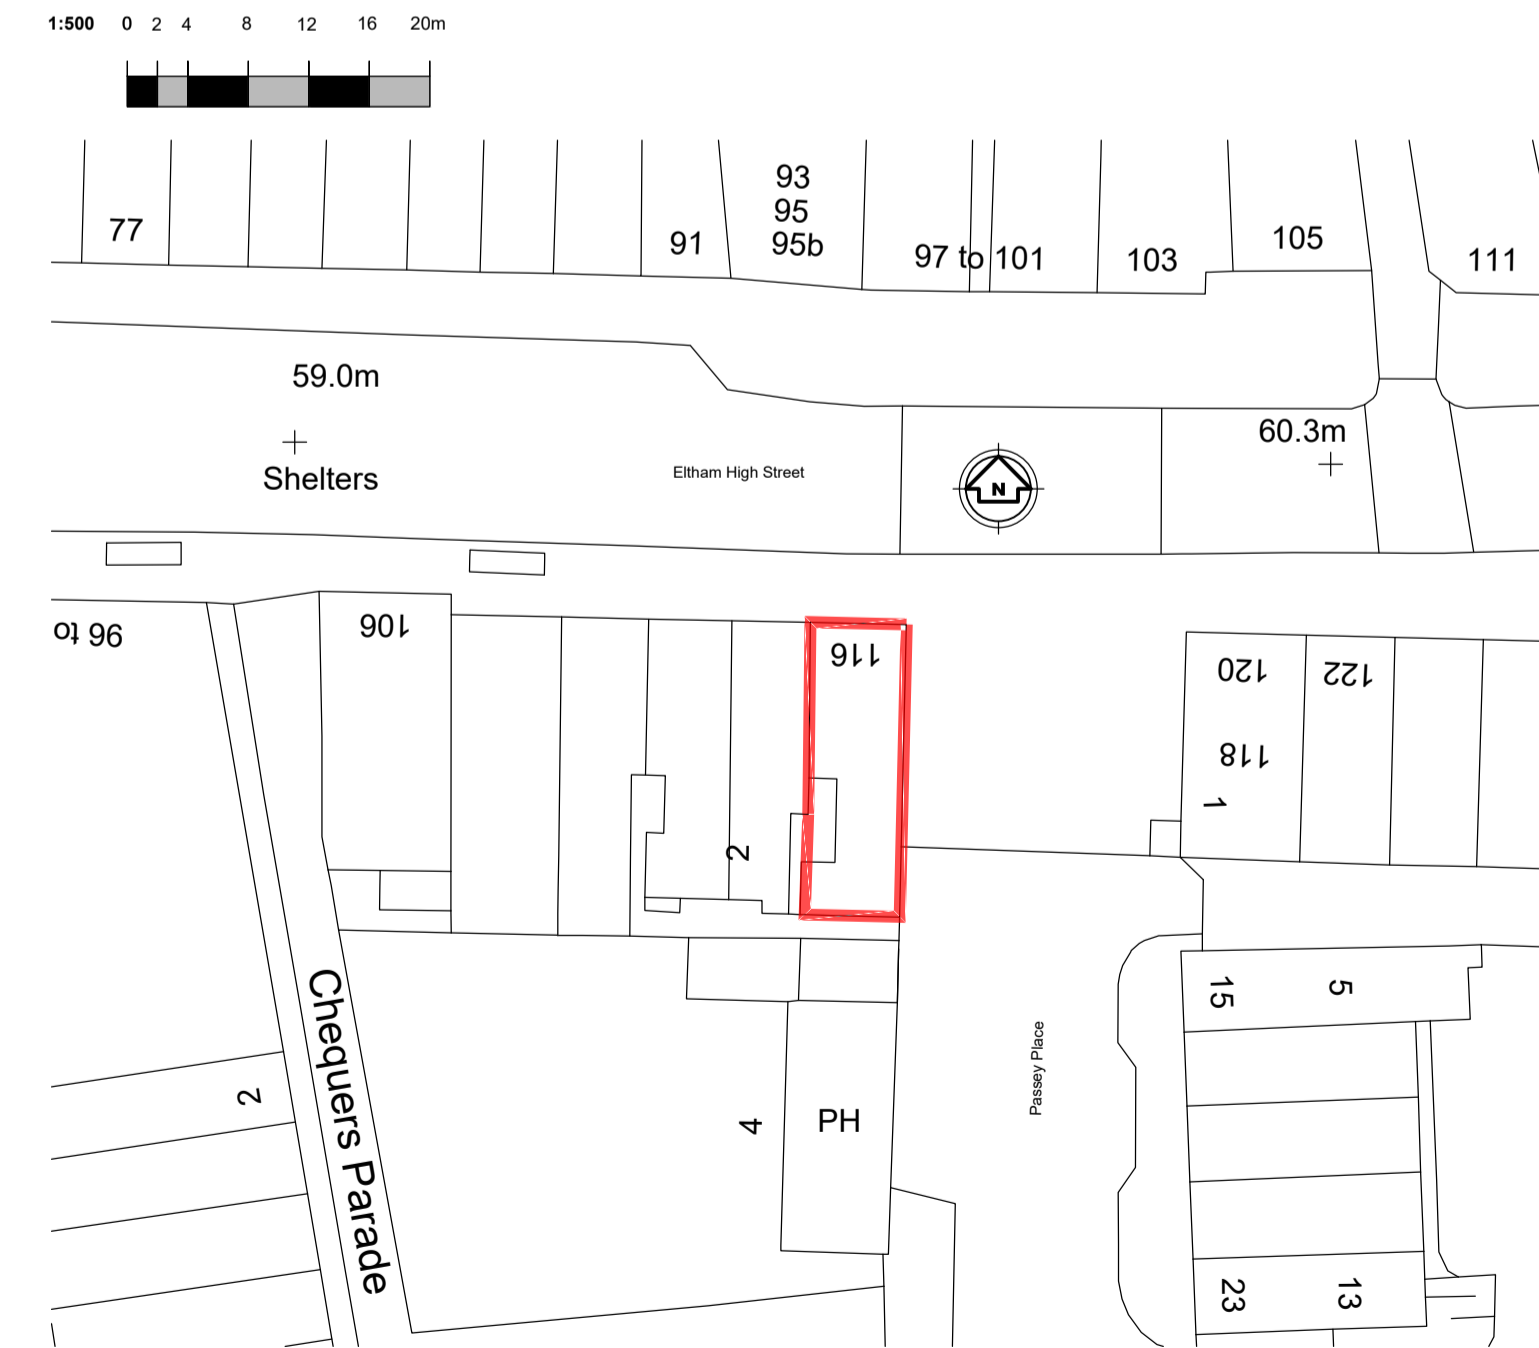

Existing Block Plan at 1:500

When printing off pdf drawings, it is the responsibility of the user to verify that the resulting prints are to scale on the appropriate sized sheet. Also the scale bar on the plan measure correctly.



All dimensions in millimetres unless stated otherwise

General Notes:

1. Dimensions should not be scaled from the drawings where accuracy is essential.
2. Details dimensions and levels to be checked on site by builder prior to commencement of works. Any works commenced prior to all necessary local authority approvals are entirely at the risk of the owner & builder.
3. Structural details are subject to exposure of existing construction and verification by L.A. Surveyor and any necessary revised details are to be agreed with the L.A. Surveyor prior to carrying out the affected works.
4. All materials are to be used in accordance with the manufacturers' guidelines and all relevant British Standards Codes of Practice & Regulation 7 of Building Regs.
5. All works are to be carried out in accordance with Local Authority requirements.
6. The intended works fall within the Party Wall Act 1996 and any adjoining owners affected must be notified prior to commencement of any works.
7. Thames Water Authority permission to be obtained if building over or adjacent to sewers within 3 metres. (Tel: 08459 200 800)
8. No part of the extension to project into adjoining boundary lines.

Drawn: Drawing No.

Eralp Semi 07787744404 EFP/23074 - 2

Client: Mr Tevfik Ozsoykal

Address:
116 Eltham High Street
London
SE9 1BW

Drawings:
Existing-Proposed Floor Elevations and Photographs.

Project:
Addition of a new floor above rear outrigger and re configuration of internal layout of the existing 2 bedroom flat.

Date: December 2023

Scale: 1:100 @ A1