

## **EXISTING WINDOW CONDITION** NOTES:


W1& W2 both sashes are in working condition and can open, pulleys, ropes and weights would benefit from refurbishment to better ease of opening. No evidence of existing draught brushes installed to face of inner frame, there is a trickle vent to the underside of the outer sash mid transform. Windows would benefit from the install of draught brushes within the frame.

6 over 6 configuration, suggests window arrangements are as per the original design. Existing ironmongery in working condition but would benefit from refurbishment.


Both windows are identical in dimension and profile. Astragals appear to be original in profile and dimension.

Please refer to Supporting Statement for further information and elevation photos which show each window in context within front elevation.

Glazing Type: Single Glazing GLASS MAKE UP: 6-7mm

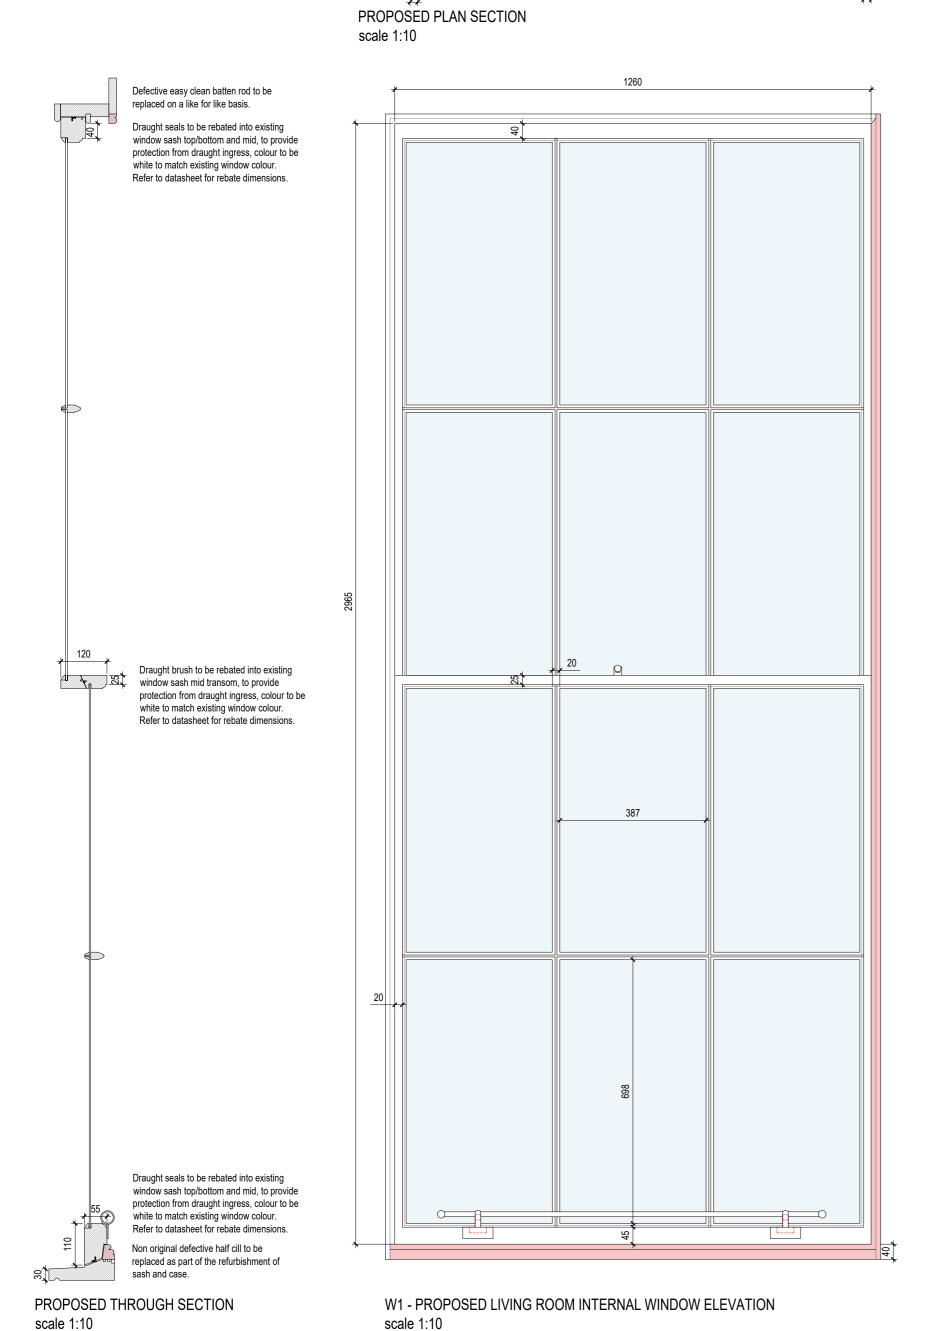

NOTES

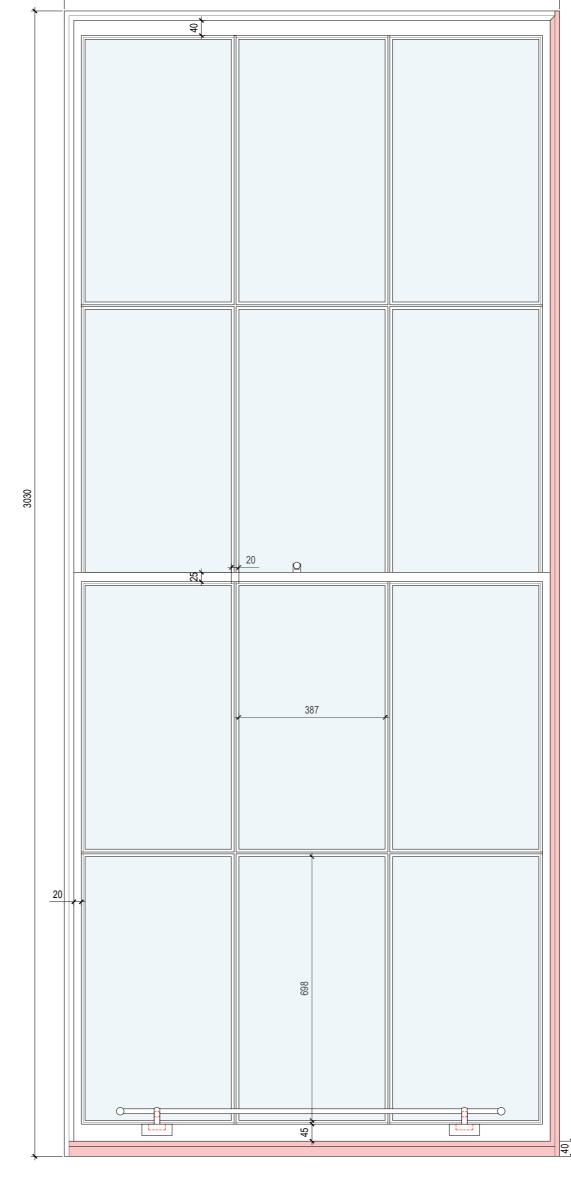

## PROPOSED WINDOW SCOPE:

W1 & W2 to undergo full refurbishment as follows:

- Generally all existing window timbers are in good condition. Allowance for overhaul of the easy clean batten rods and non original half cills (highlighted in red) as necessary to ensure windows are without defective timbers and are tight fitting.
- Replace all existing defective ropes with new waxed cotton ropes and check weight distribution to both windows to ensure ease of opening. Existing defective top sash rope pulls to be replaced and reinstated
- Schlegel draught seals to be rebated into existing window sashes, top/mid/bottom. Slidex draughts brushes rebated into sides of sashes.
- Existing sash weights to be adjusted and re balanced along with install of new pulley wheels to allow for ease of opening.
- Existing shutters to undergo refurbishment to allow for adjustments ensure they are working efficiently and closing tightly without any weak draft spots. Ironmongery to be refurbished as required.
- Non original finger pulls to be removed and replaced with brass pull bar.

Both windows to undergo full redecoration as follows:

- Removal of existing defective and heavily coated paint internally and externally with full dip and strip of existing windows and internal shutters.
- Windows and shutters to be repainted in white gloss to match existing.
- Window pane putty to be replaced on a like for like basis and painted white to match existing.
- Existing, failing exterior sand mastic to be removed and replaced with new traditional mastic.

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W2 - PROPOSED LIVING ROOM INTERNAL WINDOW ELEVATION scale 1:10

HEALTH AND SAFETY NOTES EXISTING & PROPOSED W1&W2 HARRY DEVINE DESCRIPTION Do not scale for construction purposes SIGNIFICANT RESIDUAL HAZARDS Should any discrepancies be found with this Asbestos **DRAWINGS** drawing, please inform the office. Health Hazards Structural Instability Copyright of this drawing is owned by -PROJECT Ground Conditions 9 FORRES ST, Mill Architects Limited DATE SCALE - A1 Buried and Overhead Services 5-6 Easter Dalmeny **EDINBURGH** 1:10 FEB 24' Dalmeny, South Queensferry Underground Structures Edinburgh, EH30 9TS Tel: 0131 629 1466 Adjacent Activities JOB NO. DWG. NO. STATUS Site Restrictions LBC 1069 (31)100 hello@millarchitects.co.uk Other (Specify)

