


1 South East Elevation
1: 100

- Natural Slate Roof Tiles
- Natural Slate Cladding
- uPVC Guttering & RWP's
- Natural Stone Cladding
- uPVC Double Glazed Windows
- Render Finish Elevations
- Timber Casement Double Glazed Windows & Doors




2 North East Elevation
1: 100

- uPVC Double Glazed Windows
- Horizontal Timber Cladding
- Natural Slate Roof Tiles
- uPVC Guttering & RWP's
- Natural Stone Cladding
- Render Finish Elevations
- Timber Casement Double Glazed Windows & Doors

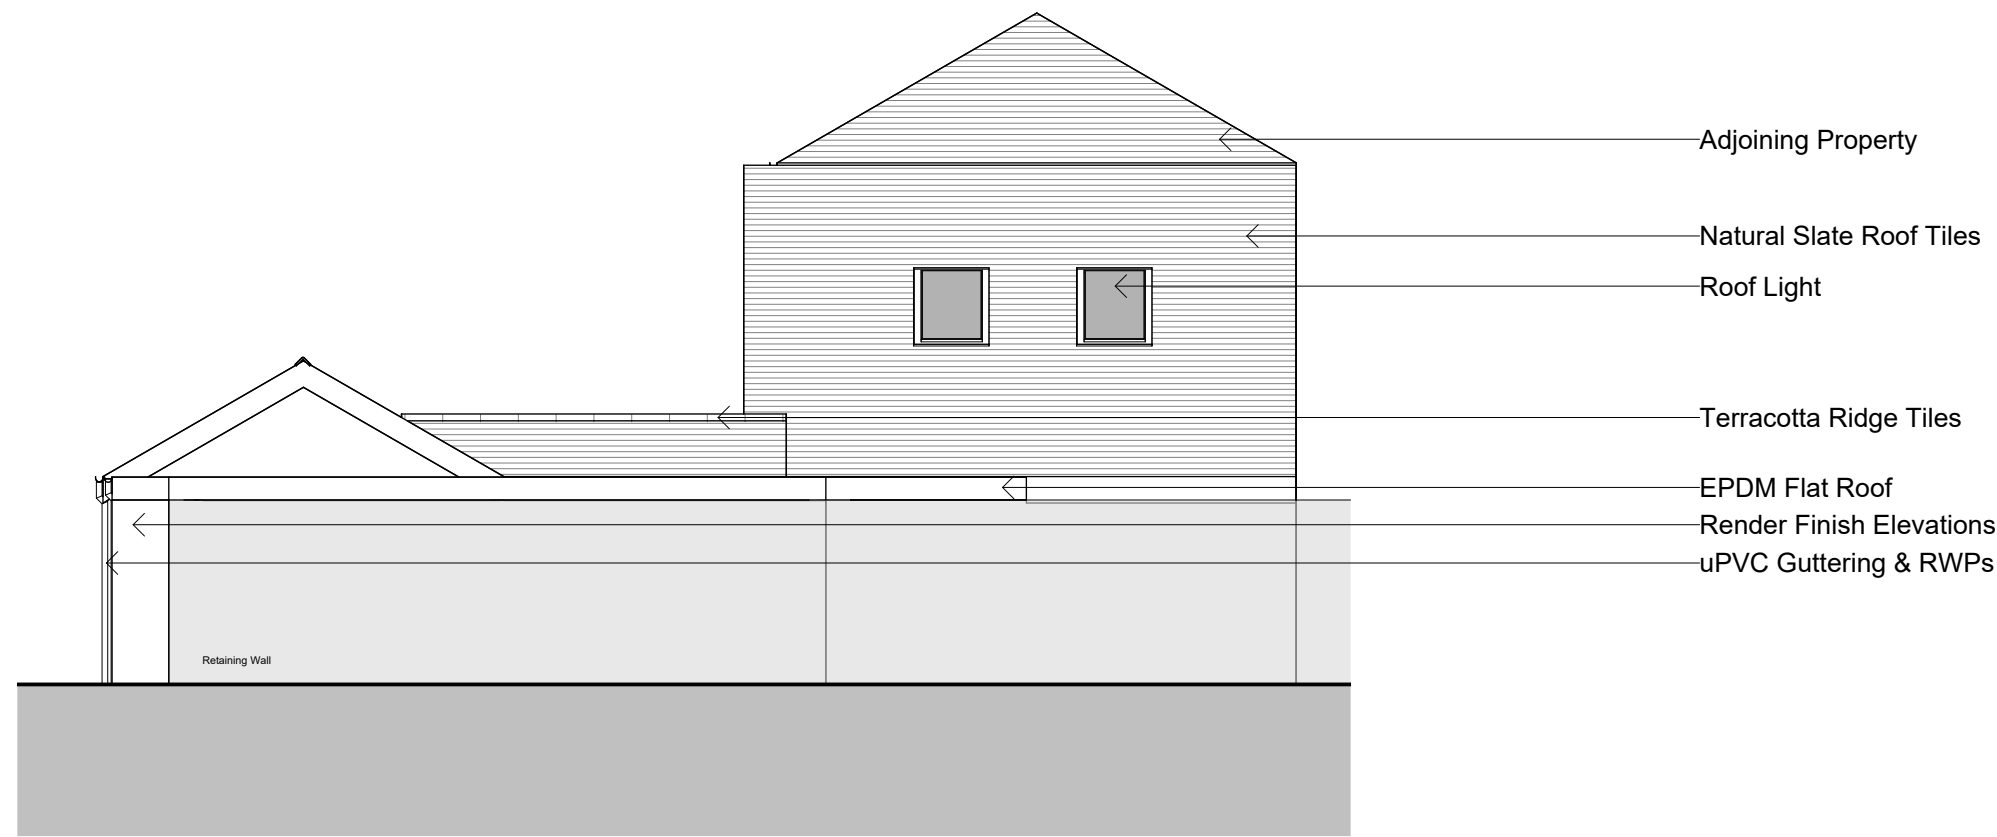


3 North West Elevation
1: 100

- Adjoining Property
- Natural Slate Roof Tiles
- Roof Light
- Terracotta Ridge Tiles
- EPDM Flat Roof
- Render Finish Elevations
- uPVC Guttering & RWP's

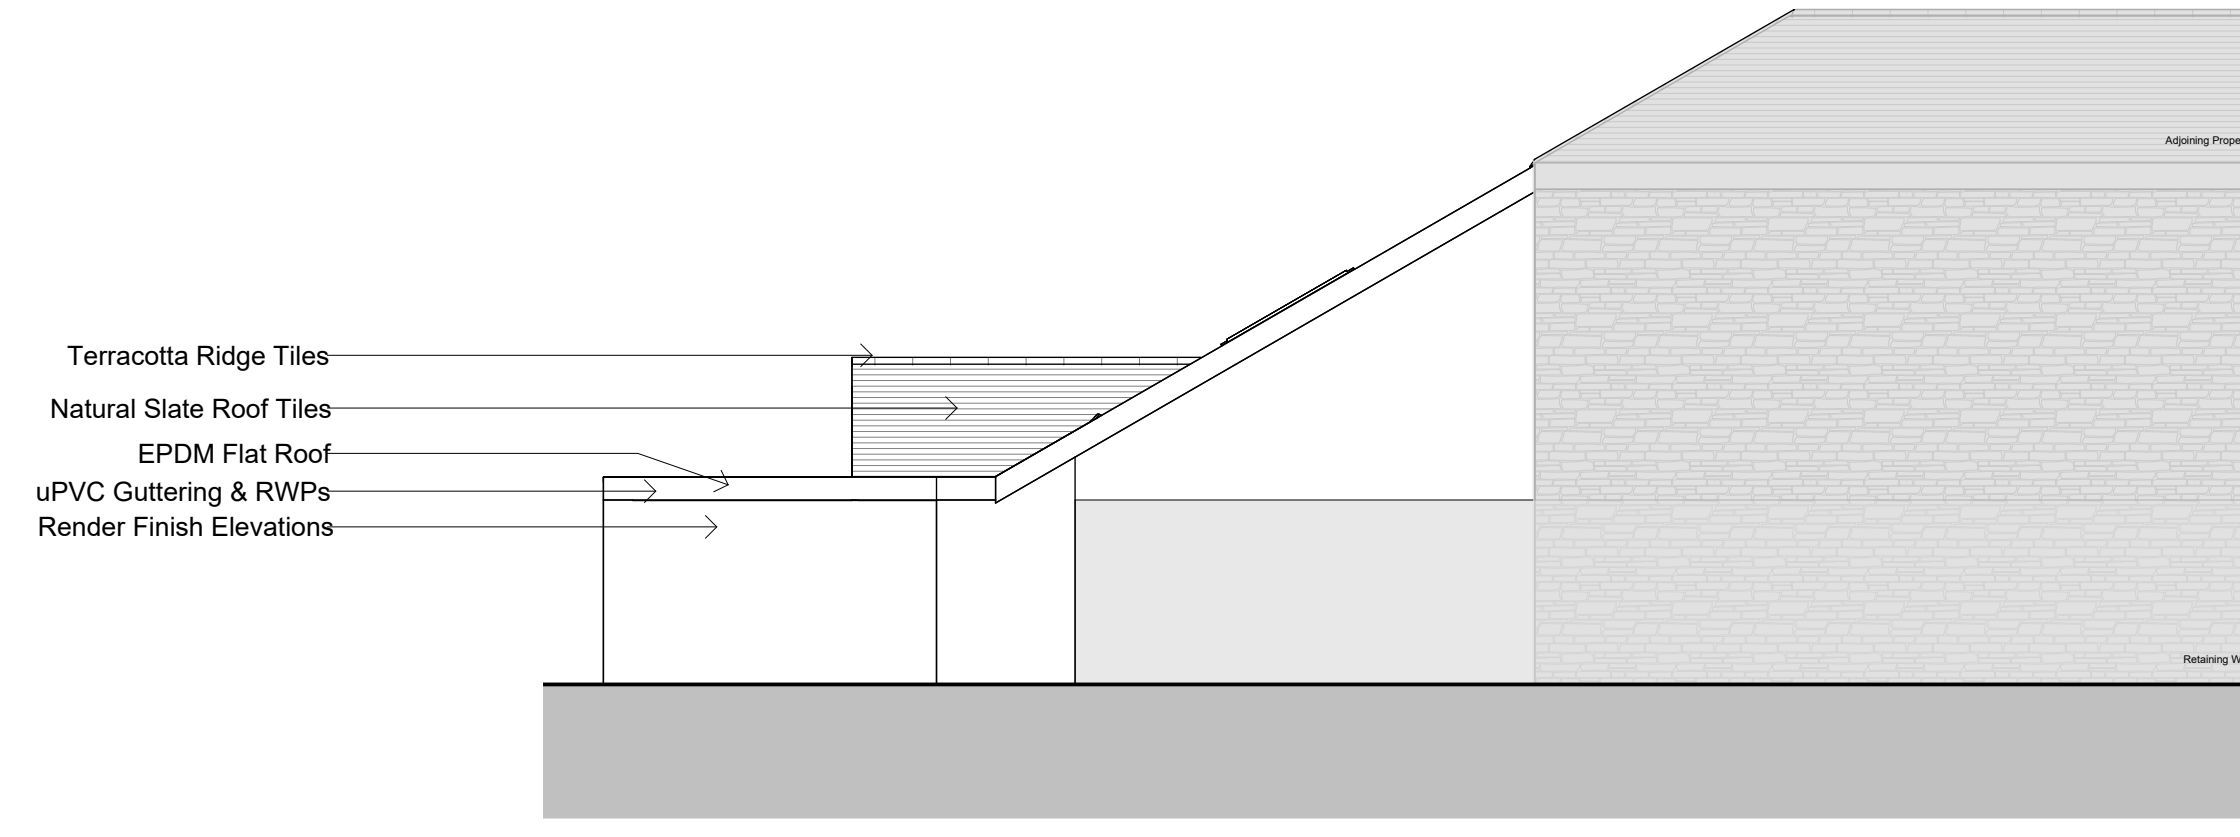


4 South West Elevation
1: 100

- Terracotta Ridge Tiles
- Natural Slate Roof Tiles
- EPDM Flat Roof
- uPVC Guttering & RWP's
- Render Finish Elevations

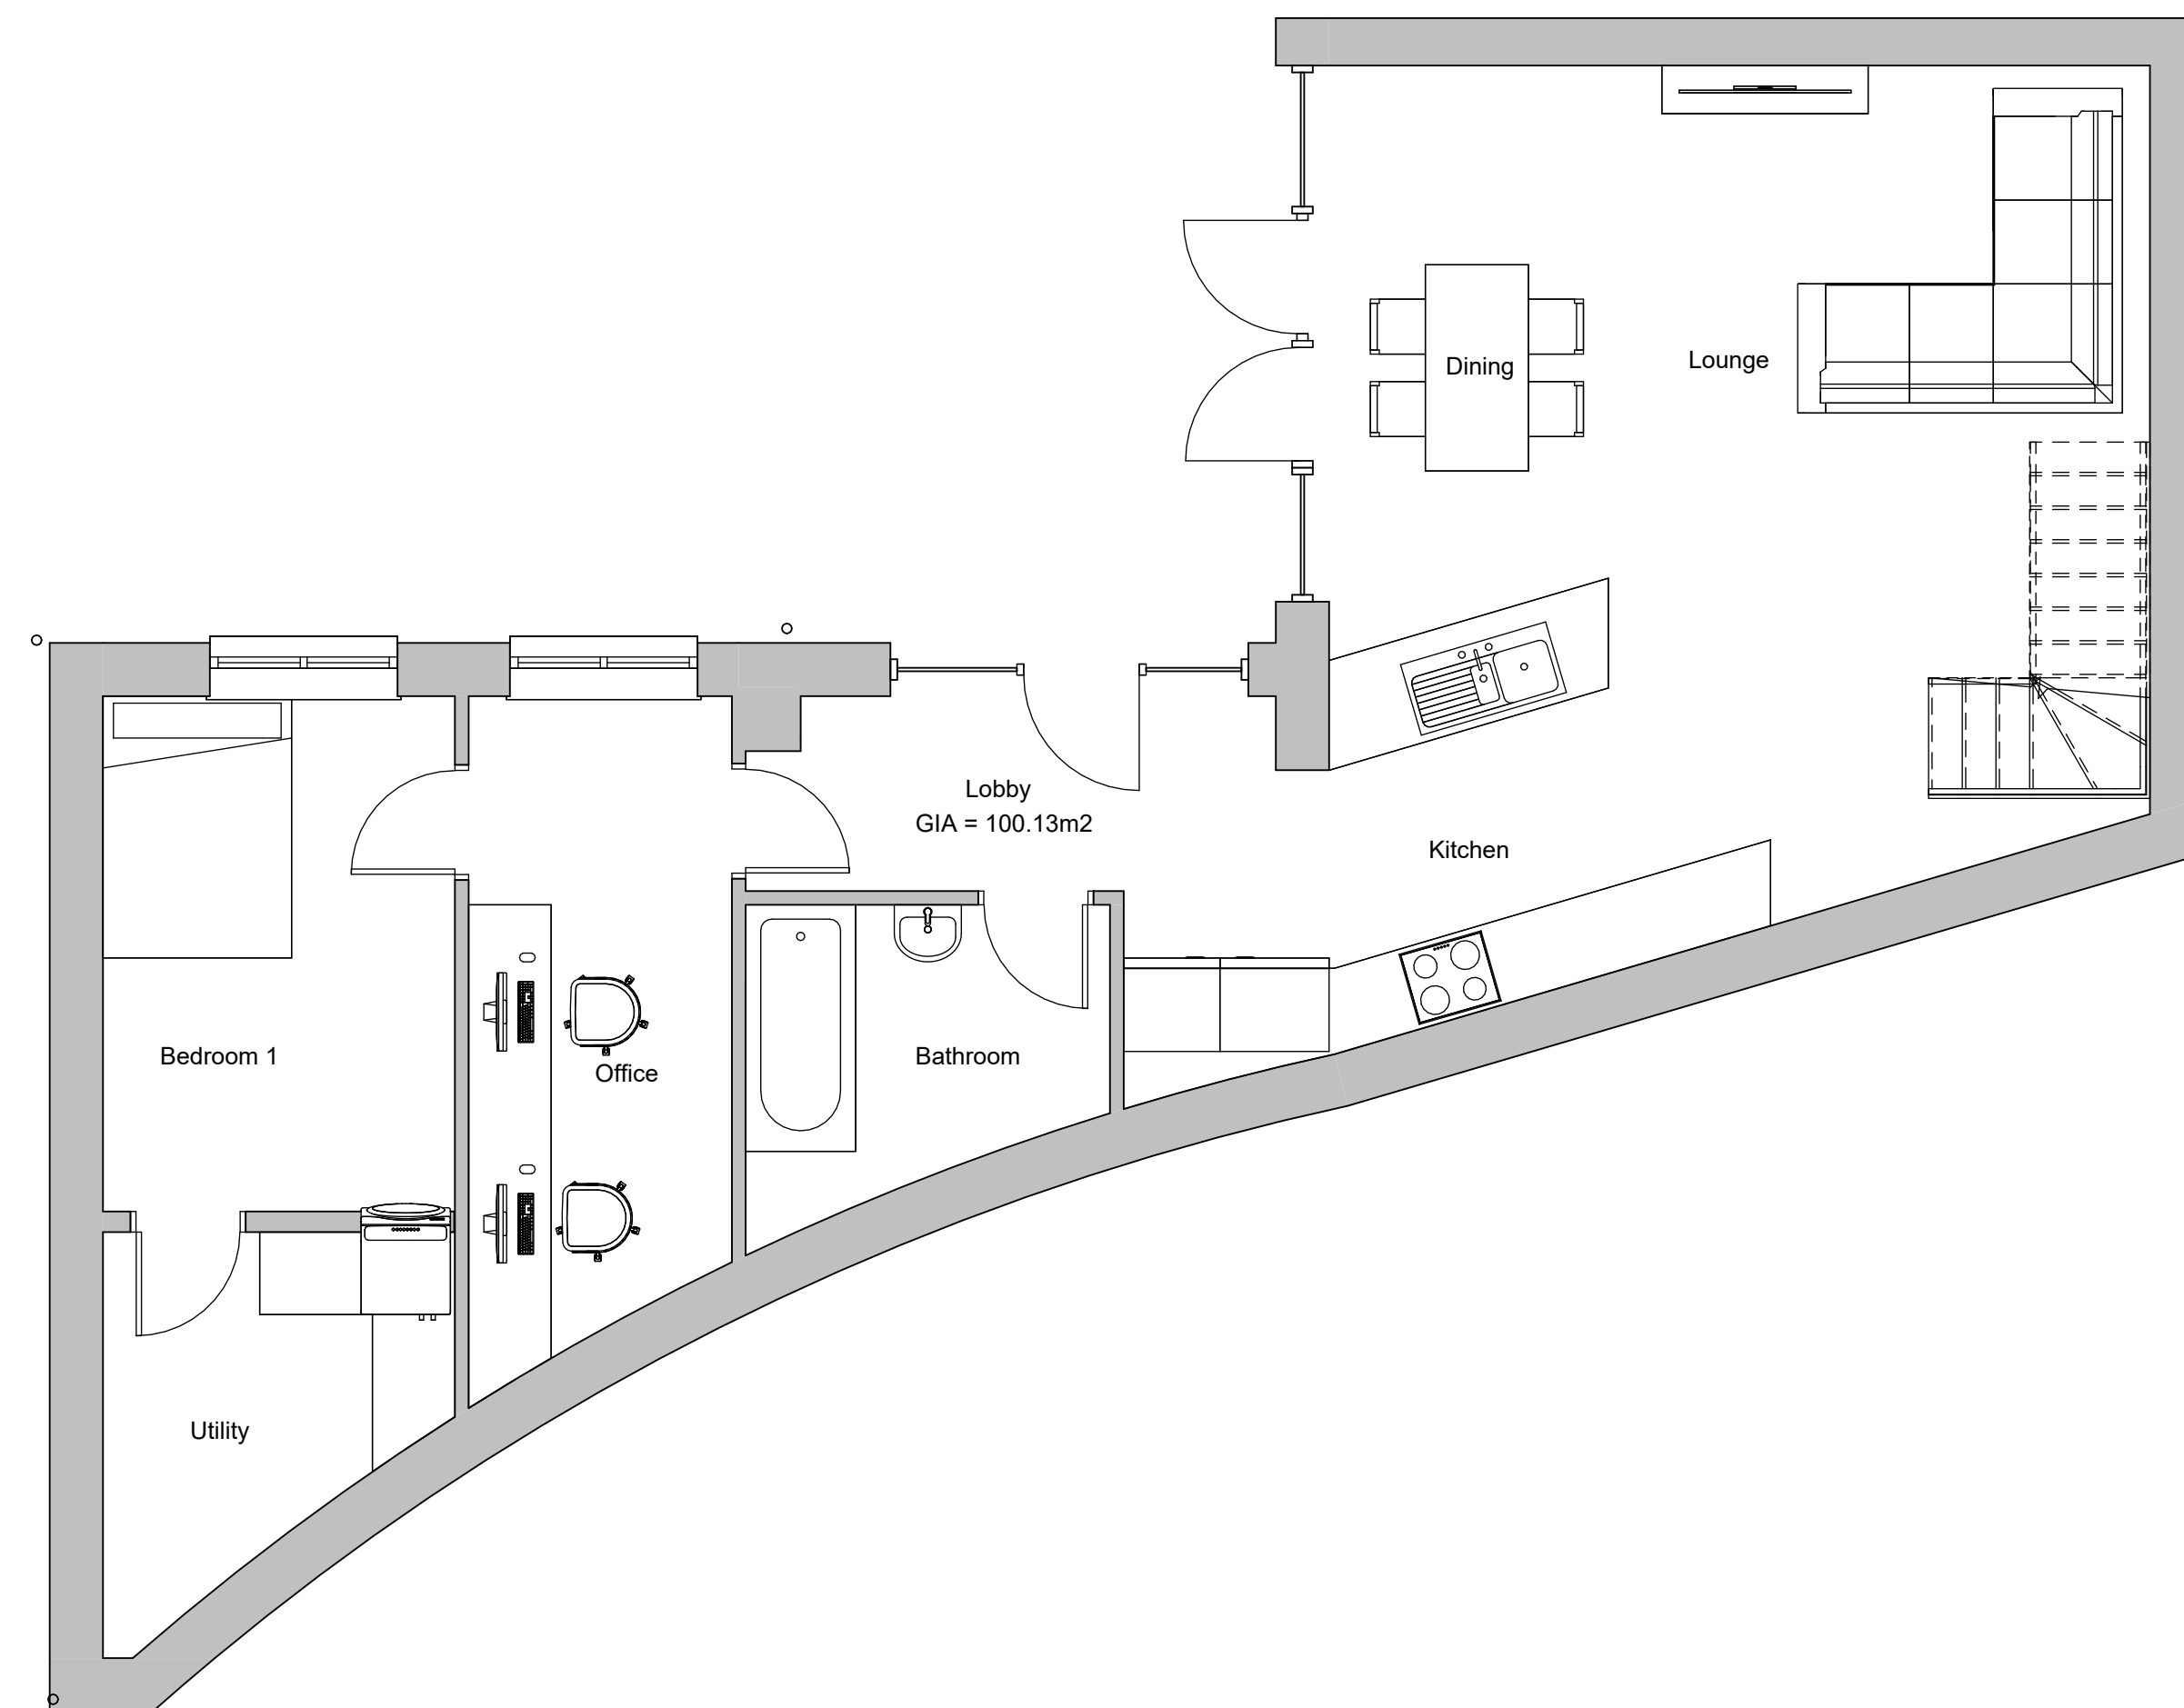


5 Ground Floor
1: 50

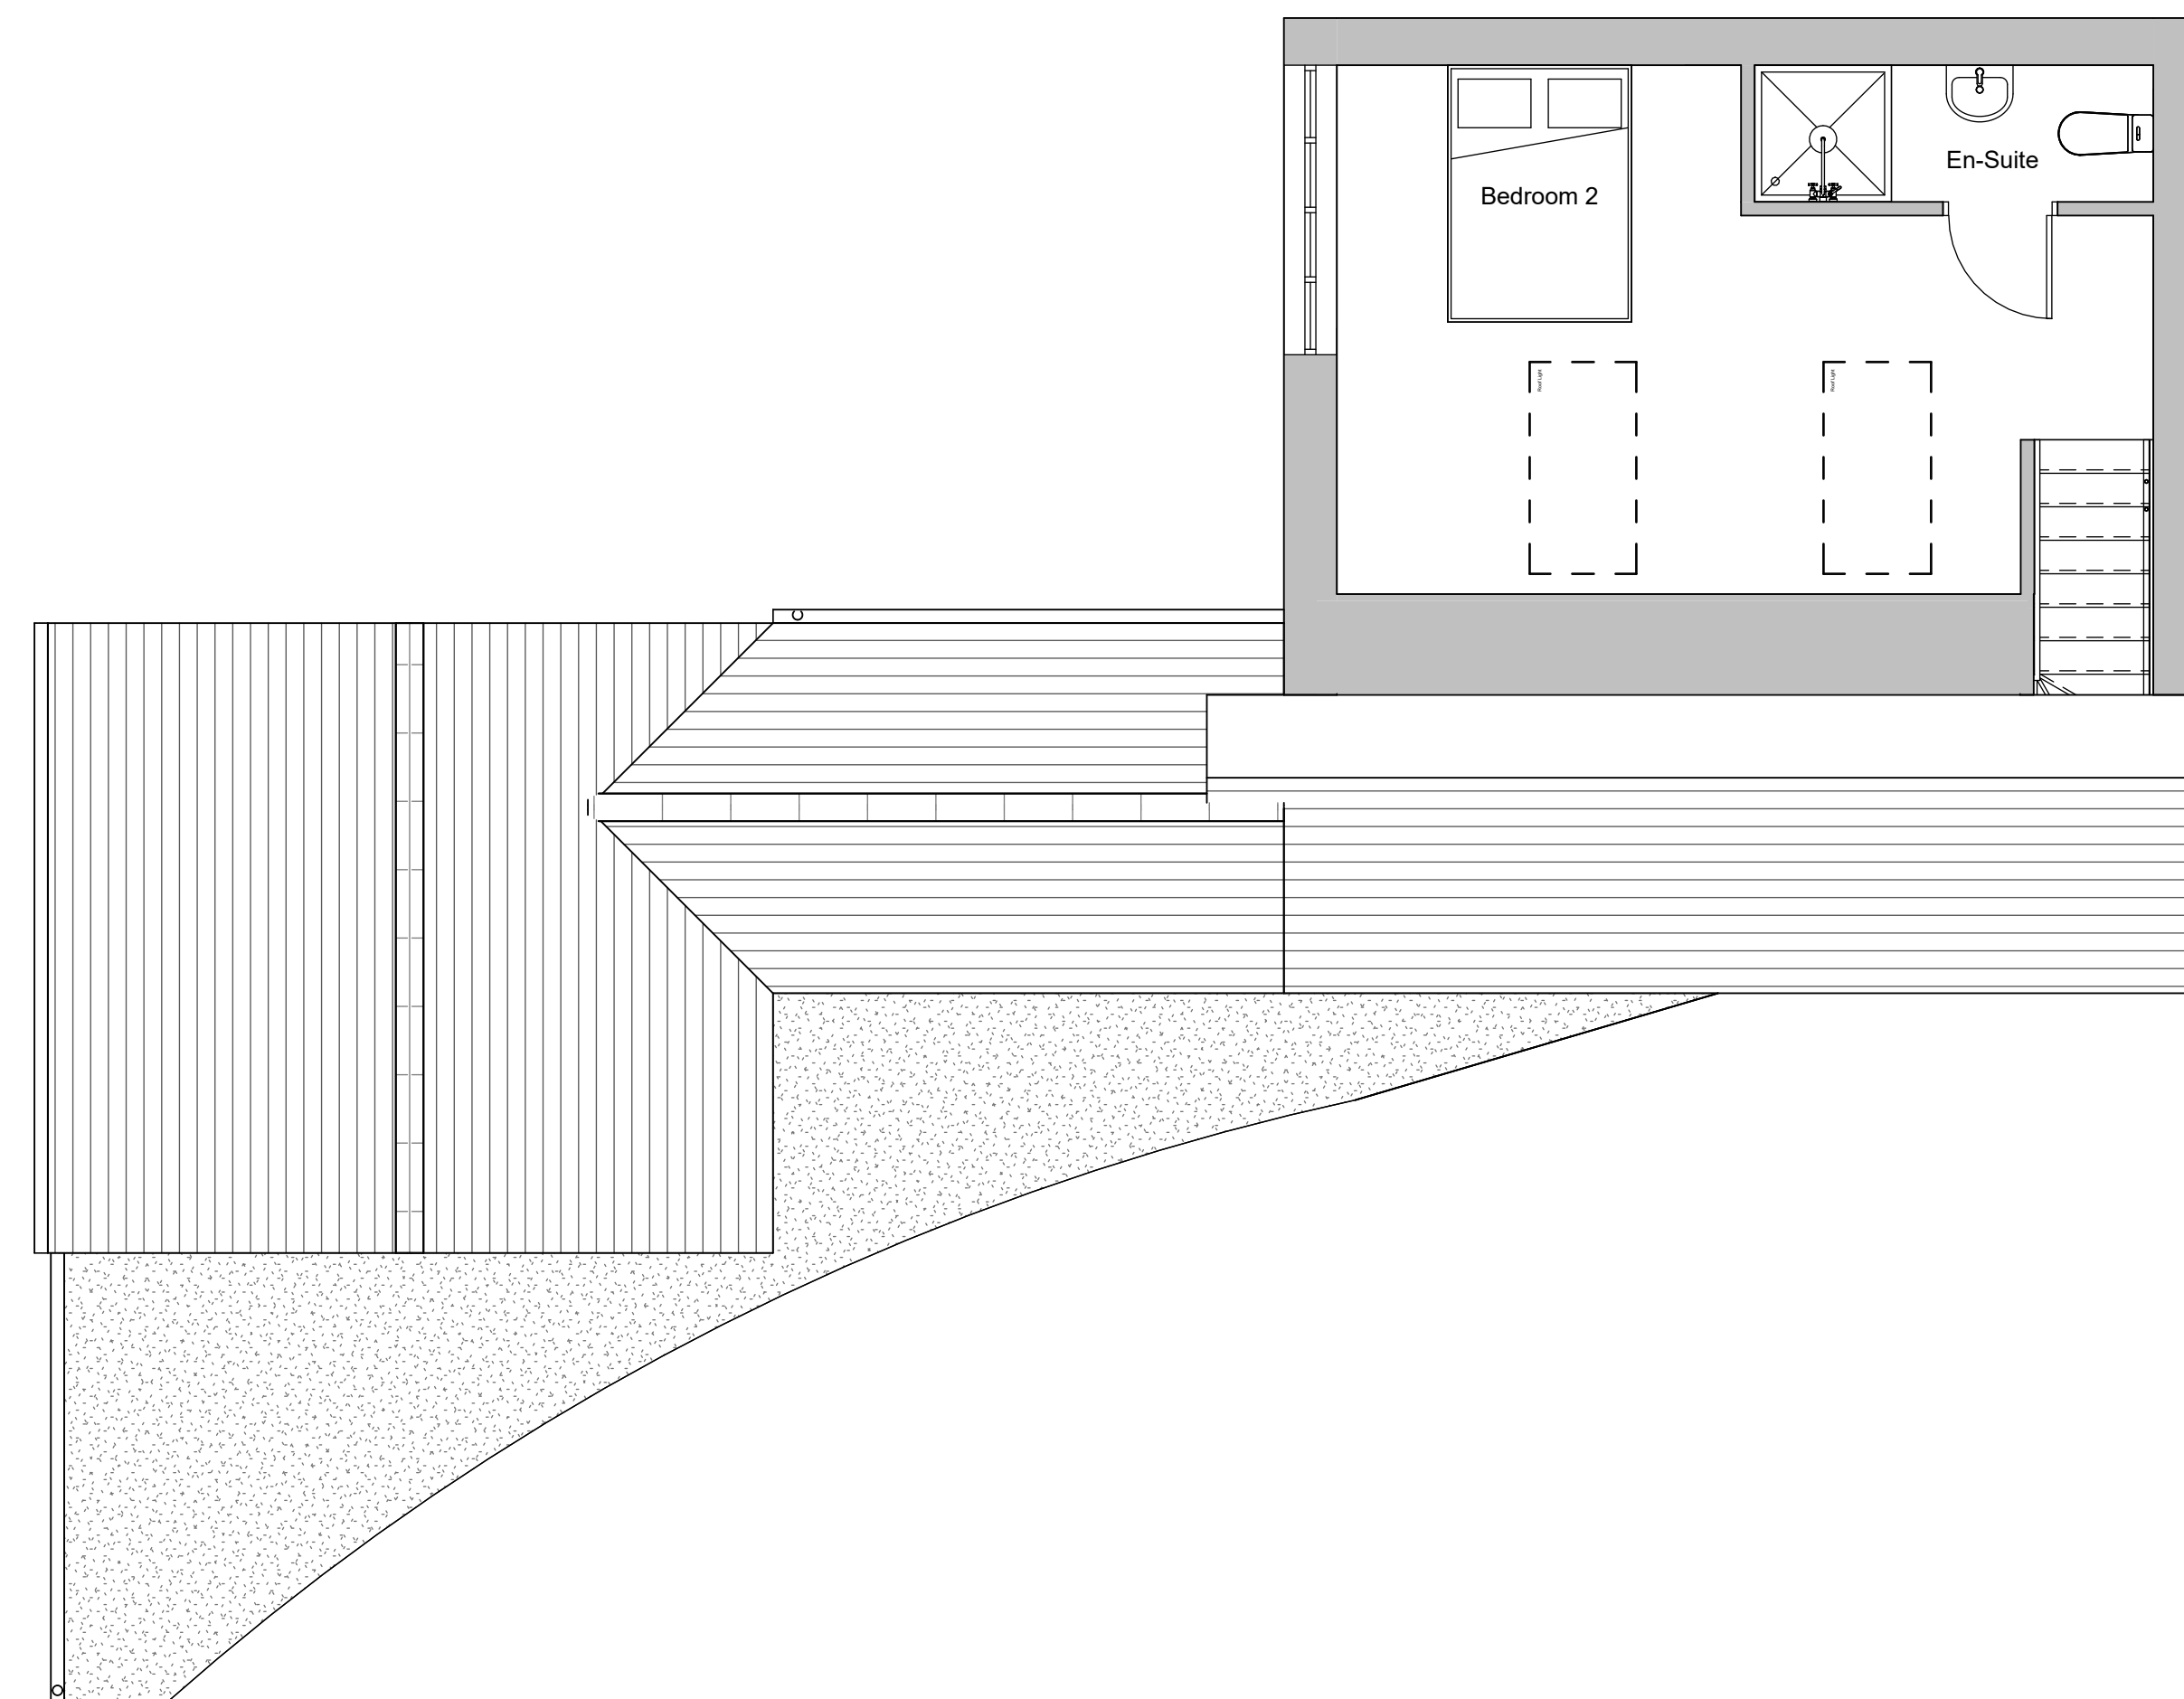

6 First Floor Plan
1: 50

1. This drawing is the copyright of Cornwall Planning Group and may not be reproduced without licence.
 2. The Contractor shall not scale off this drawing for construction purposes, only figured dimensions shall be worked from.
 3. All dimensions and levels are to be checked on site by the Contractor before the commencement of any work and any discrepancies reported to the Architect.
 4. No responsibility can be accepted for errors arising on site due to unauthorised variations from the Architects drawings.
 5. The Contractor is recommended to visit the site before tendering to ascertain all local conditions and restrictions likely to affect the works.
 6. Tenders must include for all the works described or being apparent on the drawings or can reasonably be inferred as being necessary for proper execution of the works.
 7. This drawing is for town planning and building regulations only and is not a complete working drawing.
 8. Depth, size and design of foundations shown are preliminary only, actual foundation, depth, size and design may differ depending on site conditions.
 9. On completion of the works, if a National Home Energy Rating Certificate is required by the client, contact the Local Authority Building Control Department.
 10. L1 and L2 requirements for limiting thermal bridging & air leakage workmanship shall be executed by the Contractor in accordance with the appropriate sections and DEPR/D1/R guidance document "Limiting Thermal Bridging & Air Leakage - Robust Construction Details for Dwellings and Similar Buildings" available from the Stationery Office Ltd.

Scale = 1:50@A1
 Scale = 1:100@A1

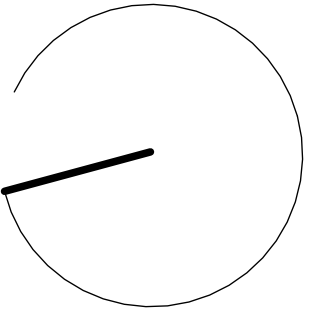

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Client: Mrs Anna Wilson
 Project: Extension & Alterations of Existing Dwelling House & Associated Works

Address: The Studio, Goonvrea Manor, Perran-Ar-Worthal, TR3 7PN

Title: Existing Plans & Elevations

Revisions			
Rev.	Issue Date	Description	Issued by

Stage: Project Status
 Scale: As indicated
 Date: 29/08/2023
 Drawn: QEC Checked: CM
 Project No: 2452 Drawing No: 002
 Rev: