


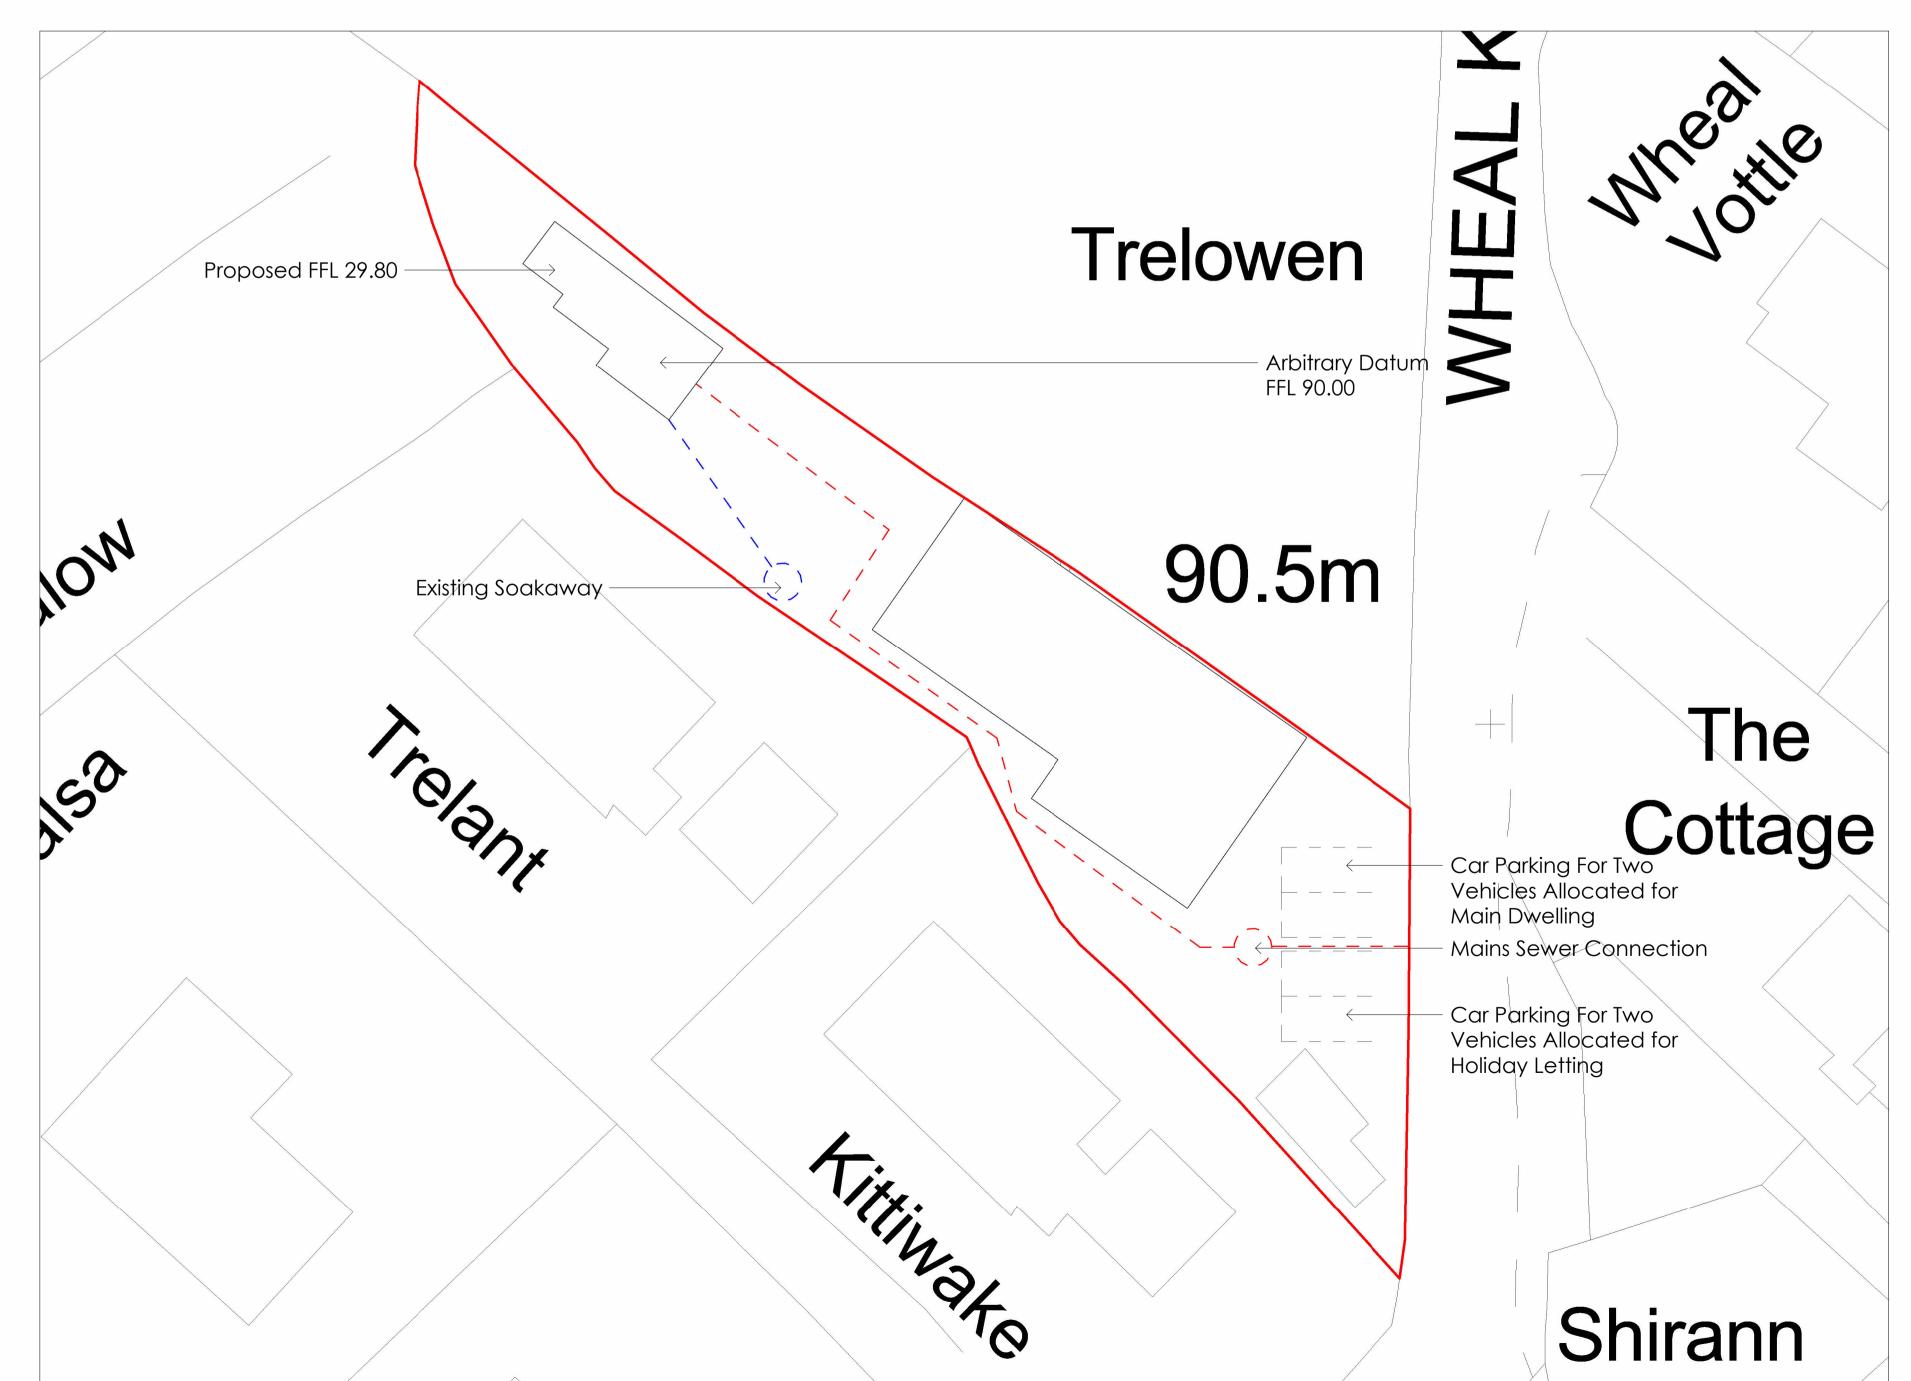

Existing Location Plan

Proposed Location Plan Trelowen 90.5m Trelant The Cottage Titinako Shirann

Proposed Block Plan
1:500



not be reproduced without licence.


2. The Contractor shall not scale off this drawing for construction purposes, only figured dimensions shall be worked from. 3. All dimensions and levels are to be checked on site by the Contractor before the commencement of any work and any discrepancies reported to the Architect. unauthorised variations from the Architects drawings. ascertain all local conditions and restrictions likely to affect the works No claims arising from failure to do so will be considered.

1. This drawing is the copyright of Cornwall Planning Group and may

6. Tenders must include for all the works described or being on the drawings or can reasonably inferred as being necessary for the proper execution of the works. 7. This drawing is for town planning and b not a complete working drawing. 8. Depth, size and design of foundations shown are preliminary only actual foundation, depth, size and design may differ depending on site

9. On completion of the works, if a National Home Energy Rating Certificate is required by the client, contact the Local Authority Build

workmanship shall be executed by the Contractor in accordance w the appropriate sections and DEFRE/DTLR guidance document "Limitin Thermal Bridging & Air Leakage: Robust Construction Details for Dwellings and Similar Buildings" available from The Stationery Office

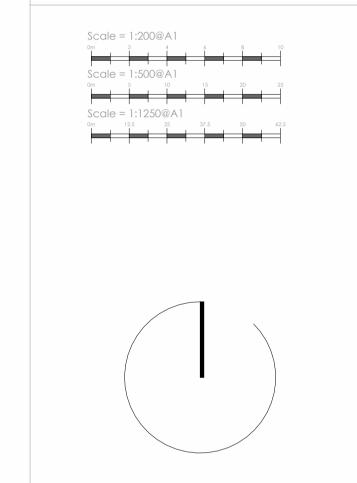

Cornwall Planning Group

Head Office: Chi Gallos, Hayle Marine Renewables Business Park, North Quay, Hayle, Cornwall, TR27 4DD Phone: +44 (0)1736 448 500 Email: office@cornwallplanninggroup.co.uk

Client: Mr B Harvey

Project: Change of Use of Annex to Form Holiday

Web: www.cornwallplanninggroup.co.uk

Address: Osocozy, Wheal Kitty, St Agnes, Cornwal, TR5 0RW

Title: Location Plans

Rev. Issue Date Description

Revisions

Stage: Project Status

Scale: As indicated

Date: 20/12/2023

Drawn: AF Checked: CM Drawing No: 001 Project No: 2569

Rev: A

Proposed Site Plan

Site Area: 832.43m²