

ANY CHANGES FROM APPROVED DRAWINGS ARE THE RESPONSIBILITY OF CLIENT/CONTRACTOR - PLEASE READ CLAUSED BELOW BEFORE WORKS COMMENCE

Any dimensions taken from this drawing should be cross checked on site and approved prior to any construction works. The contractor shall be responsible for taking all necessary site dimensions and levels and for all exploratory works to verify any existing structure before commencement of works. The contractor will be responsible for all the correct setting out and temporary supports of works on site to property and neighbouring properties

No liability taken of any kind is accepted by Architect for any error or omission Where new work is near/on boundary line/party wall the property owner is to serve party wall notice to the adjoining property/land owner in accordance with the requirements of the 'Party Wall etc.' Act 1996

Contractor responsible for notifying of Building Control Surveyor of each stage of works and ensure inspections have been made. All details to comply with current building regulations and Building Control Approval. Work not to commence until approval of plans by Building Control Body. Any works that commence before Building Regulations drawings have been approved is responsibility of client.

After confirmation from local authority that prior approval is not required, proposed extension must comply with all permitted development criteria set out under the General Permitted Development Order 1995

Any development carried out without Permitted Development Certificate is at owner's own risk. It is strongly advised that a Permitted Development Certificate/Certificate of Lawfulness is sought prior to commencement of any works

- FD30** All habitable room doors to be replaced with FD30 doors with 38x25mm Door Stops and 3 No Stainless Steel Hinges. Middle Hinge to be installed at least 2/3 of way up door frame
- SD** Mains powered with battery back up interlinked smoke detector to be installed within at least 7.5m of all habitable rooms and at least 30cm from any light fitting or wall
- HD** Mains powered and interlinked operated heat detector with battery back up
- Ex** Extractor fan for shower room - 15l/s and Kitchen 30l/s to be taken through to run and expel externally



For Structural Steelwork refer to Structural Engineer's Drawing. Beams indicated by red dashed lines (see right)

All Steel work to be encased in 2 layers of FireLine Board with staggered joints or fire resisting intumescent paint in accordance with manufacturer's guidance to provide minimum 60min fire resistance

All Steel work to only be ordered once contractor has confirmed dimensions on site and positioning with client. Any discrepancies noted to be discussed with Surveyor prior to ordering any steel work. No responsibility taken by Surveyor for steels ordered to match site conditions

A-Z Building Services

A: Addlestone KT15
E: hthusayin0809@msn.com
T: 07969925562

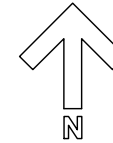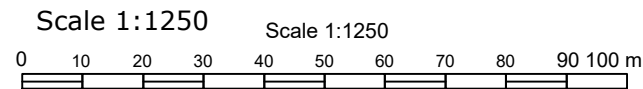

Mapping contents (c) Crown copyright and database rights 2016 Ordnance Survey 100035207

LOCATION MAP

Scale 1:1250

LOCATION PLAN - 11 MORDEN GARDENS, GREENFORD UB6

SUBJECT TO Approval

CLIENT	PROJECT	DRAWING	STAGE	CHECKED	APPROVED
11 MORDEN GARDENS GREENFORD UB6	PART TWO STOREY/PART SINGLE STOREY SIDE AND REAR EXTENSION	LOCATION PLAN	Building Control	SCALE 1:1250 @A3	DATE
DRAWING No.				REV	
1 7 C H A W O R T H - 0 1					



ANY CHANGES FROM APPROVED DRAWINGS ARE THE RESPONSIBILITY OF CLIENT/CONTRACTOR – PLEASE READ CLAUSED BELOW BEFORE WORKS COMMENCE

Any dimensions taken from this drawing should be cross checked on site and approved prior to any construction works. The contractor shall be responsible for taking all necessary site dimensions and levels and for all exploratory works to verify any existing structure before commencement of works. The contractor will be responsible for all the correct setting out and temporary supports of works on site to property and neighbouring properties

No liability taken of any kind is accepted by Architect for any error or omission Where new work is near/on boundary line/party wall the property owner is to serve party wall notice to the adjoining property/land owner in accordance with the requirements of the 'Party Wall etc.' Act 1996

Contractor responsible for notifying of Building Control Surveyor of each stage of works and ensure inspections have been made. All details to comply with current building regulations and Building Control Approval. Work not to commence until approval of plans by Building Control Body. Any works that commence before Building Regulations drawings have been approved is responsibility of client.

After confirmation from local authority that prior approval is not required, proposed extension must comply with all permitted development criteria set out under the General Permitted Development Order 1995

Any development carried out without Permitted Development Certificate is at owner's own risk. It is strongly advised that a Permitted Development Certificate/Certificate of Lawfulness is sought prior to commencement of any works

- FD30 **FD30**
All habitable room doors to be replaced with FD30 doors with 38x25mm Door Stops and 3 No Stainless Steel Hinges. Middle Hinge to be installed at least 2/3 of way up door frame
- SD **SD**
Mains powered with battery back up interlinked smoke detector to be installed within at least 7.5m of all habitable rooms and at least 30cm from any light fitting or wall
- HD **HD**
Mains powered and interlinked operated heat detector with battery back up
- Ex **Ex**
Extractor fan for shower room - 15l/s and Kitchen 30l/s to be taken through to run and expel externally

For Structural Steelwork refer to Structural Engineer's Drawing. Beams indicated by red dashed lines (see right)

All Steel work to be encased in 2 layers of FireLine Board with staggered joints or fire resisting intumescent paint in accordance with manufacturer's guidance to provide minimum 60min fire resistance

All Steel work to only be ordered once contractor has confirmed dimensions on site and positioning with client. Any discrepancies noted to be discussed with Surveyor prior to ordering any steel work. No responsibility taken by Surveyor for steels ordered to match site conditions

A-Z Building Services


A: Addestone KT15
E: hthus@0809@msn.com
T: 07969925562

Scale 1:200



SUBJECT TO Approval

CLIENT 11 MORDEN GARDENS GREENFORD UB6	PROJECT PART TWO STOREY/PART SINGLE STOREY SIDE AND REAR EXTENSION	DRAWING EXISTING SITE PLAN	STAGE Building Control	CHECKED SCALE 1:200 @A3	APPROVED DATE	DRAWING No. 17 CHAWORTH - 02	REV
---	---	-------------------------------	---------------------------	----------------------------	------------------	---------------------------------	-----

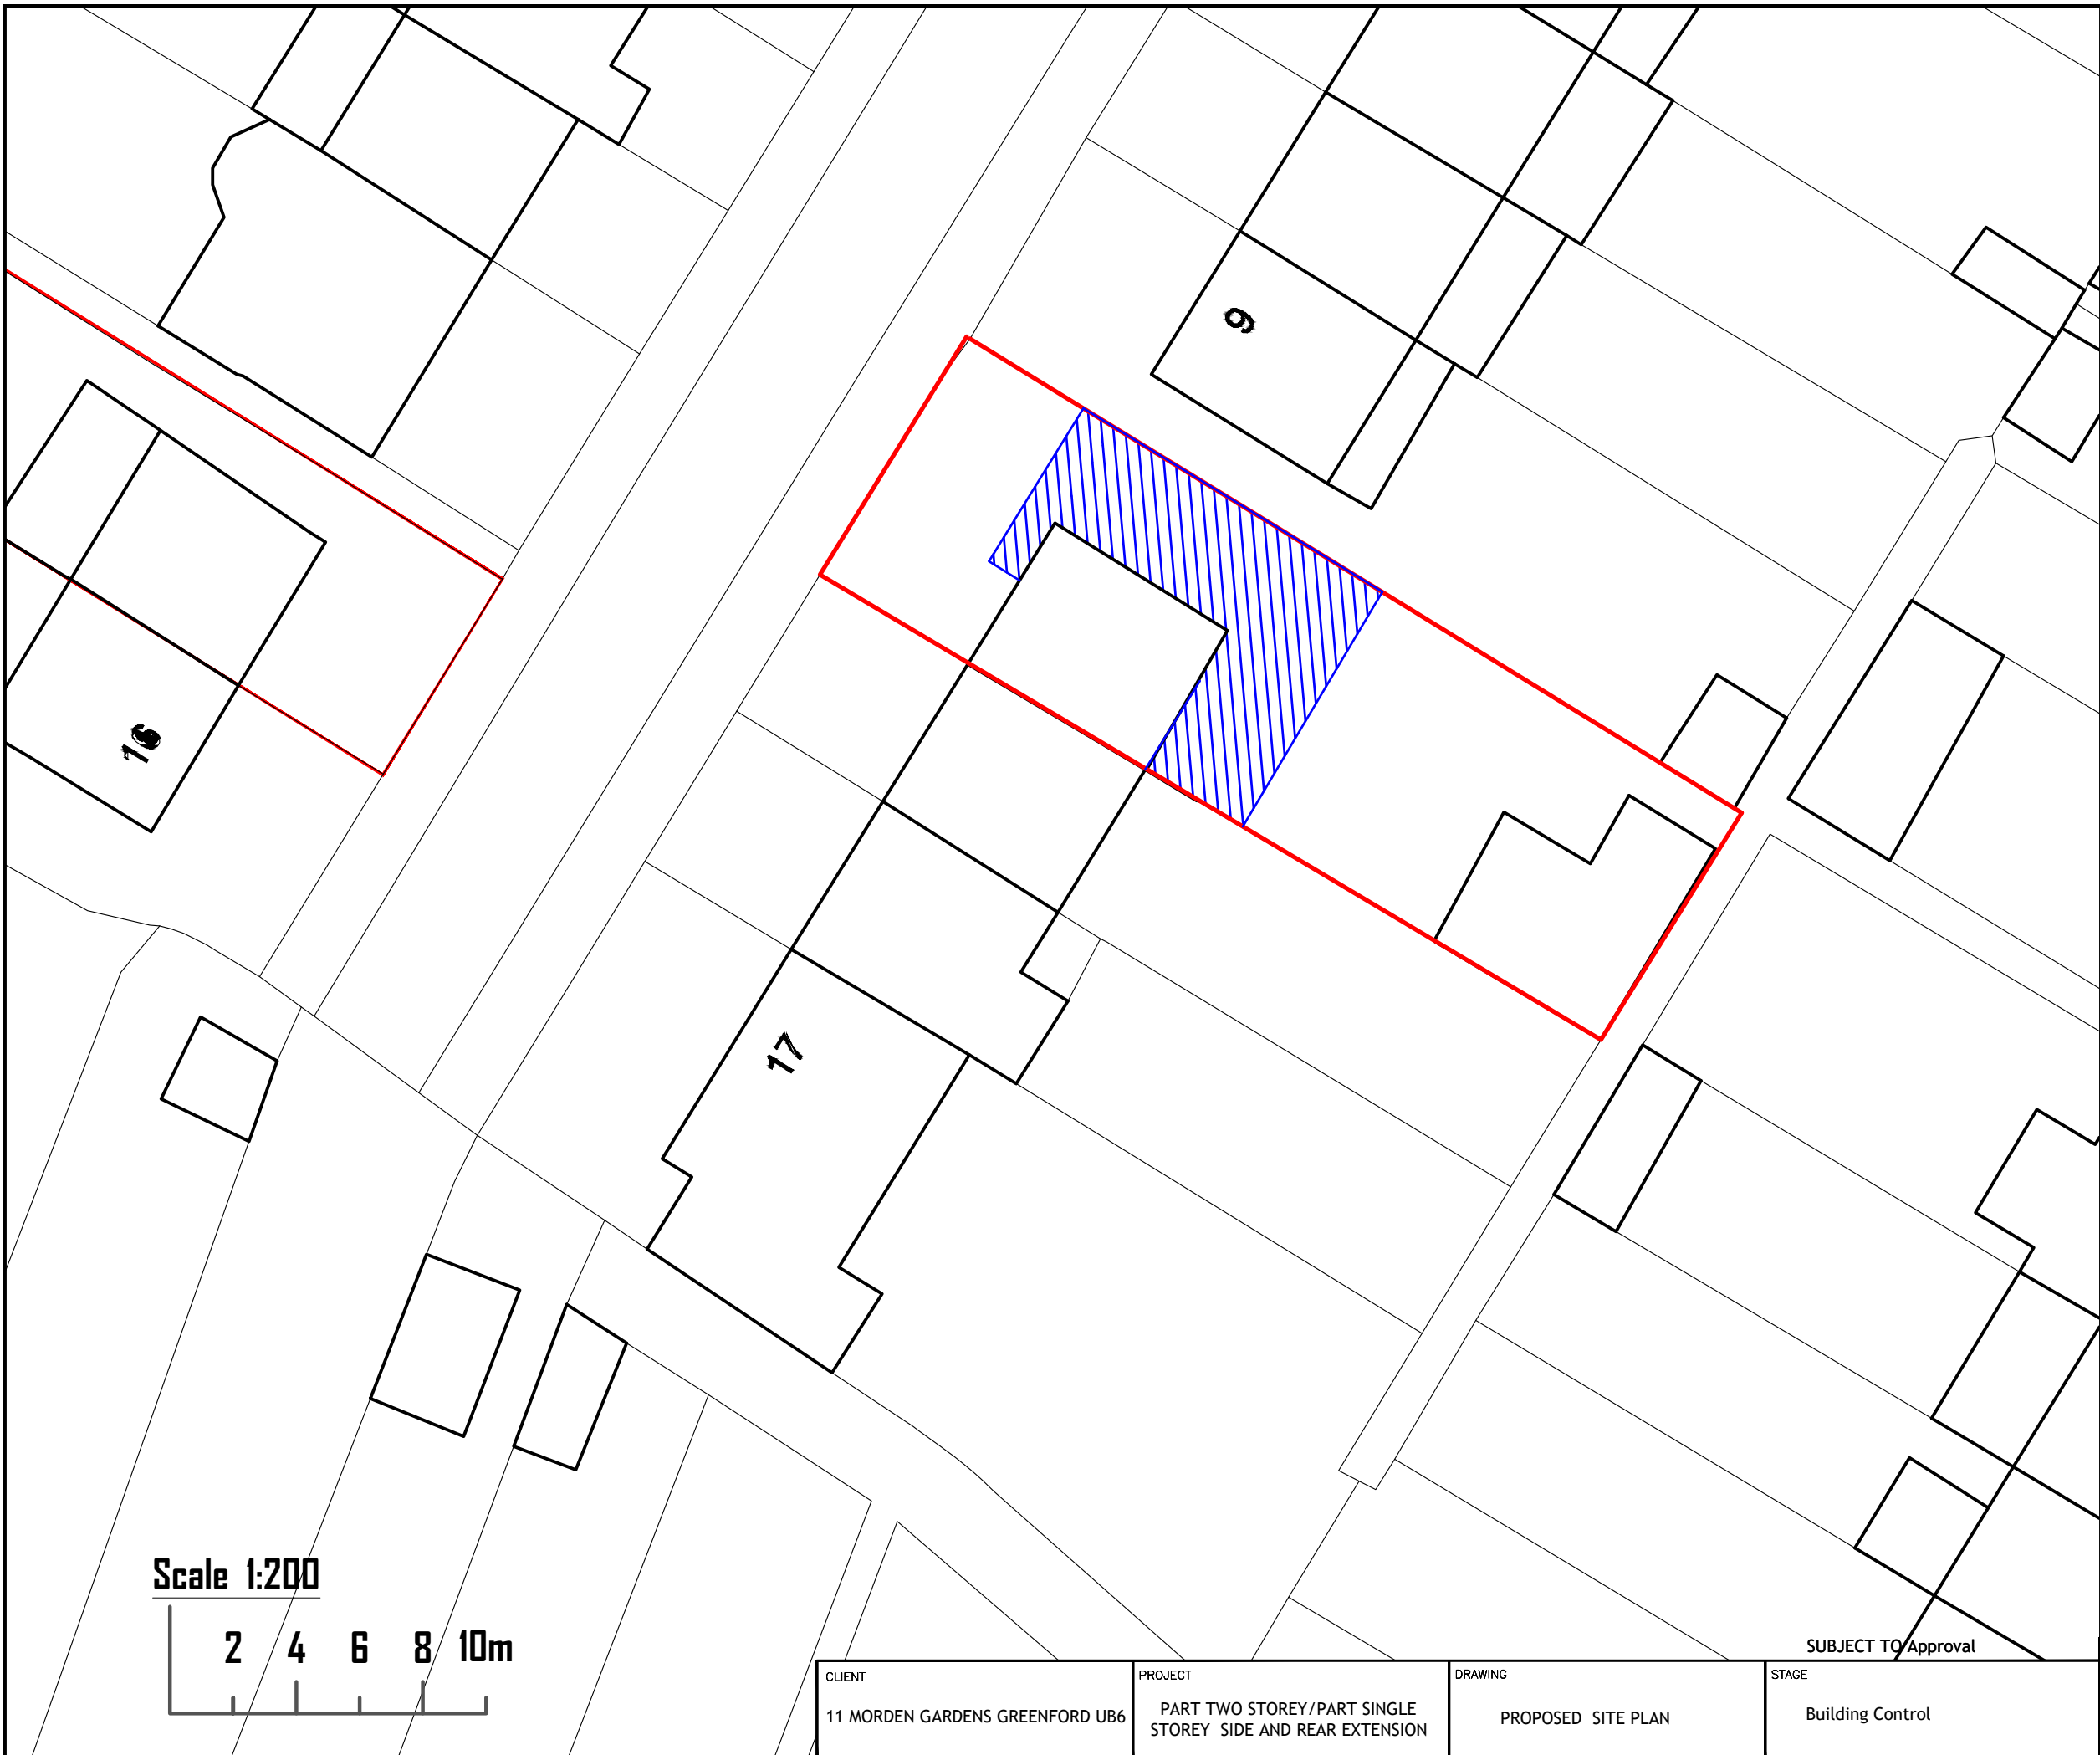

ANY CHANGES FROM APPROVED DRAWINGS ARE THE RESPONSIBILITY OF CLIENT/CONTRACTOR - PLEASE READ CLAUSED BELOW BEFORE WORKS COMMENCE

Any dimensions taken from this drawing should be cross checked on site and approved prior to any construction works. The contractor shall be responsible for taking all necessary site dimensions and levels and for all exploratory works to verify any existing structure before commencement of works. The contractor will be responsible for all the correct setting out and temporary supports of works on site to property and neighbouring properties

No liability taken of any kind is accepted by Architect for any error or omission Where new work is near/on boundary line/party wall the property owner is to serve party wall notice to the adjoining property/land owner in accordance with the requirements of the 'Party Wall etc.' Act 1996

Contractor responsible for notifying of Building Control Surveyor of each stage of works and ensure inspections have been made. All details to comply with current building regulations and Building Control Approval. Work not to commence until approval of plans by Building Control Body. Any works that commence before Building Regulations drawings have been approved is responsibility of client.

After confirmation from local authority that prior approval is not required, proposed extension must comply with all permitted development criteria set out under the General Permitted Development Order 1995

Any development carried out without Permitted Development Certificate is at owner's own risk. It is strongly advised that a Permitted Development Certificate/Certificate of Lawfulness is sought prior to commencement of any works

- FD30 FD30 All habitable room doors to be replaced with FD30 doors with 38x25mm Door Stops and 3 No Stainless Steel Hinges. Middle Hinge to be installed at least 2/3 of way up door frame
- SD Mains powered with battery back up interlinked smoke detector to be installed within at least 7.5m of all habitable rooms and at least 30cm from any light fitting or wall
- HD Mains powered and interlinked operated heat detector with battery back up
- Ex Extractor fan for shower room - 15l/s and Kitchen 30l/s to be taken through to run and expel externally

For Structural Steelwork refer to Structural Engineer's Drawing. Beams indicated by red dashed lines (see right)

All Steel work to be encased in 2 layers of FireLine Board with staggered joints or fire resisting intumescent paint in accordance with manufacturer's guidance to provide minimum 60min fire resistance

All Steel work to only be ordered once contractor has confirmed dimensions on site and positioning with client. Any discrepancies noted to be discussed with Surveyor prior to ordering any steel work. No responsibility taken by Surveyor for steels ordered to match site conditions

A-Z Building Services


A: Addestone KT15
E: hthus@0809@msn.com
T: 07969925562



SUBJECT TO Approval



CLIENT 11 MORDEN GARDENS GREENFORD UB6	PROJECT PART TWO STOREY/PART SINGLE STOREY SIDE AND REAR EXTENSION	DRAWING PROPOSED SITE PLAN	STAGE Building Control
		CHECKED SCALE 1:200 @A3	APPROVED DATE
DRAWING No. 1 7 C H A W O R T H - 0 3			REV

BOUNDARY

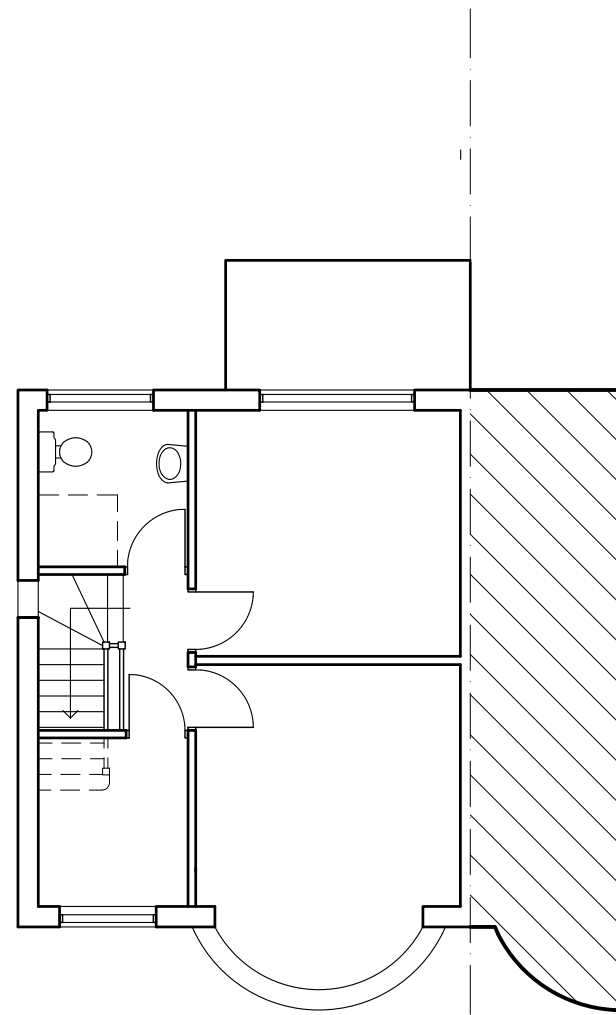

EXISTING FIRST FLOOR PLAN

BOUNDARY

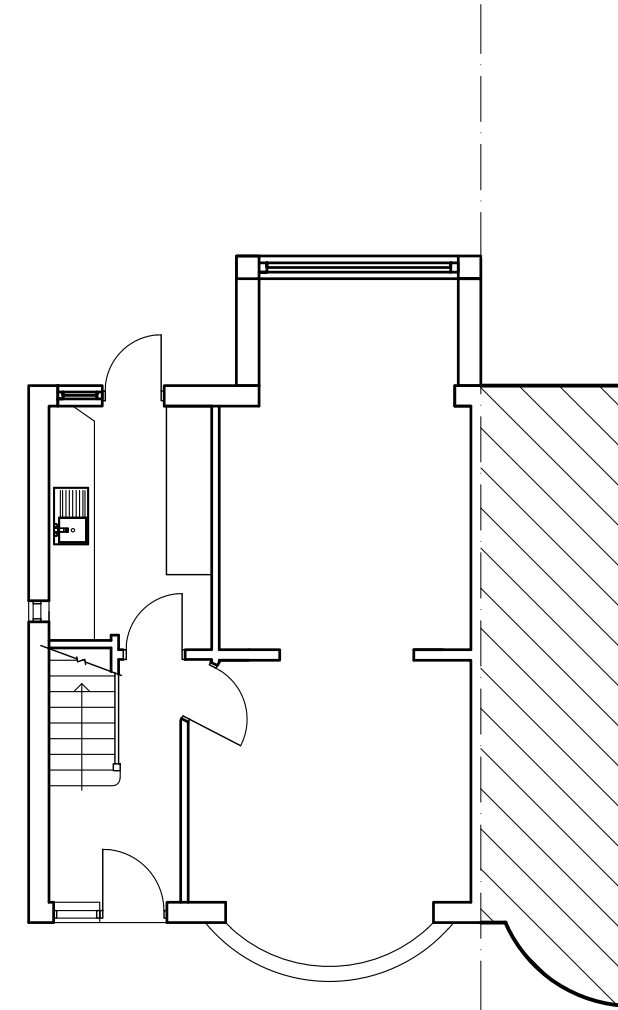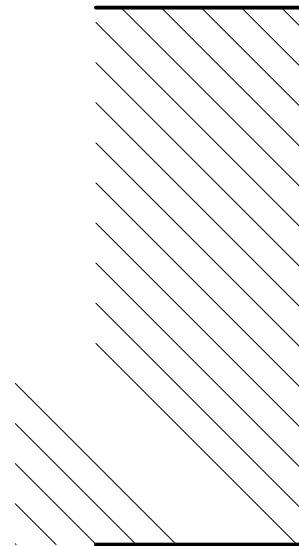

EXISTING GROUND FLOOR PLAN

ANY CHANGES FROM APPROVED DRAWINGS ARE THE RESPONSIBILITY OF CLIENT/CONTRACTOR - PLEASE READ CLAUSED BELOW BEFORE WORKS COMMENCE

Any dimensions taken from this drawing should be cross checked on site and approved prior to any construction works. The contractor shall be responsible for taking all necessary site dimensions and levels and for all exploratory works to verify any existing structure before commencement of works. The contractor will be responsible for all the correct setting out and temporary supports of works on site to property and neighbouring properties

No liability taken of any kind is accepted by Architect for any error or omission Where new work is near/on boundary line/party wall the property owner is to serve party wall notice to the adjoining property/land owner in accordance with the requirements of the 'Party Wall etc.' Act 1996

Contractor responsible for notifying of Building Control Surveyor of each stage of works and ensure inspections have been made. All details to comply with current building regulations and Building Control Approval. Work not to commence until approval of plans by Building Control Body. Any works that commence before Building Regulations drawings have been approved is responsibility of client.

After confirmation from local authority that prior approval is not required, proposed extension must comply with all permitted development criteria set out under the General Permitted Development Order 1995

Any development carried out without Permitted Development Certificate is at owner's own risk. It is strongly advised that a Permitted Development Certificate/Certificate of Lawfulness is sought prior to commencement of any works

- FD30** All habitable room doors to be replaced with FD30 doors with 38x25mm Door Stops and 3 No Stainless Steel Hinges. Middle Hinge to be installed at least 2/3 of way up door frame
- SD** Mains powered with battery back up interlinked smoke detector to be installed within at least 7.5m of all habitable rooms and at least 30cm from any light fitting or wall
- HD** Mains powered and interlinked operated heat detector with battery back up
- Ex** Extractor fan for shower room - 15l/s and Kitchen 30l/s to be taken through to run and expel externally

For Structural Steelwork refer to Structural Engineer's Drawing. Beams indicated by red dashed lines (see right)

All Steel work to be encased in 2 layers of FireLine Board with staggered joints or fire resisting intumescent paint in accordance with manufacturer's guidance to provide minimum 60min fire resistance

All Steel work to only be ordered once contractor has confirmed dimensions on site and positioning with client. Any discrepancies noted to be discussed with Surveyor prior to ordering any steel work. No responsibility taken by Surveyor for steels ordered to match site conditions

A-Z Building Services

A: Addlestone KT15
E: hthusyjn0809@msn.com
T: 07969925562

Scale 1:100



SUBJECT TO Approval

CLIENT 11 MORDEN GARDENS GREENFORD UB6	PROJECT PART TWO STOREY/PART SINGLE STOREY SIDE AND REAR EXTENSION	DRAWING Existing Plans	STAGE Building Control	CHECKED SCALE 1:100 @A3	APPROVED DATE
DRAWING No. 1 7 C H A W O R T H - 0 4				REV	

ANY CHANGES FROM APPROVED DRAWINGS ARE THE RESPONSIBILITY OF CLIENT/CONTRACTOR - PLEASE READ CLAUSED BELOW BEFORE WORKS COMMENCE

Any dimensions taken from this drawing should be cross checked on site and approved prior to any construction works. The contractor shall be responsible for taking all necessary site dimensions and levels and for all exploratory works to verify any existing structure before commencement of works. The contractor will be responsible for all the correct setting out and temporary supports of works on site to property and neighbouring properties

No liability taken of any kind is accepted by Architect for any error or omission Where new work is near/on boundary line/party wall the property owner is to serve party wall notice to the adjoining property/land owner in accordance with the requirements of the 'Party Wall etc.' Act 1996

Contractor responsible for notifying of Building Control Surveyor of each stage of works and ensure inspections have been made. All details to comply with current building regulations and Building Control Approval. Work not to commence until approval of plans by Building Control Body. Any works that commence before Building Regulations drawings have been approved is responsibility of client.

After confirmation from local authority that prior approval is not required, proposed extension must comply with all permitted development criteria set out under the General Permitted Development Order 1995

Any development carried out without Permitted Development Certificate is at owner's own risk. It is strongly advised that a Permitted Development Certificate/Certificate of Lawfulness is sought prior to commencement of any works

- FD30 FD30 All habitable room doors to be replaced with FD30 doors with 38x25mm Door Stops and 3 No Stainless Steel Hinges. Middle Hinge to be installed at least 2/3 of way up door frame
- SD Mains powered with battery back up interlinked smoke detector to be installed within at least 7.5m of all habitable rooms and at least 30cm from any light fitting or wall
- HD Mains powered and interlinked operated heat detector with battery back up
- Ex Extractor fan for shower room - 15l/s and Kitchen 30l/s to be taken through to run and expel externally

For Structural Steelwork refer to Structural Engineer's Drawing. Beams indicated by red dashed lines (see right)

All Steel work to be encased in 2 layers of FireLine Board with staggered joints or fire resisting intumescent paint in accordance with manufacturer's guidance to provide minimum 60min fire resistance


All Steel work to only be ordered once contractor has confirmed dimensions on site and positioning with client. Any discrepancies noted to be discussed with Surveyor prior to ordering any steel work. No responsibility taken by Surveyor for steels ordered to match site conditions

A-Z Building Services

A: Addlestone KT15
E: hthusyjn0809@msn.com
T: 07969925562



EXISTING FRONT ELEVATION

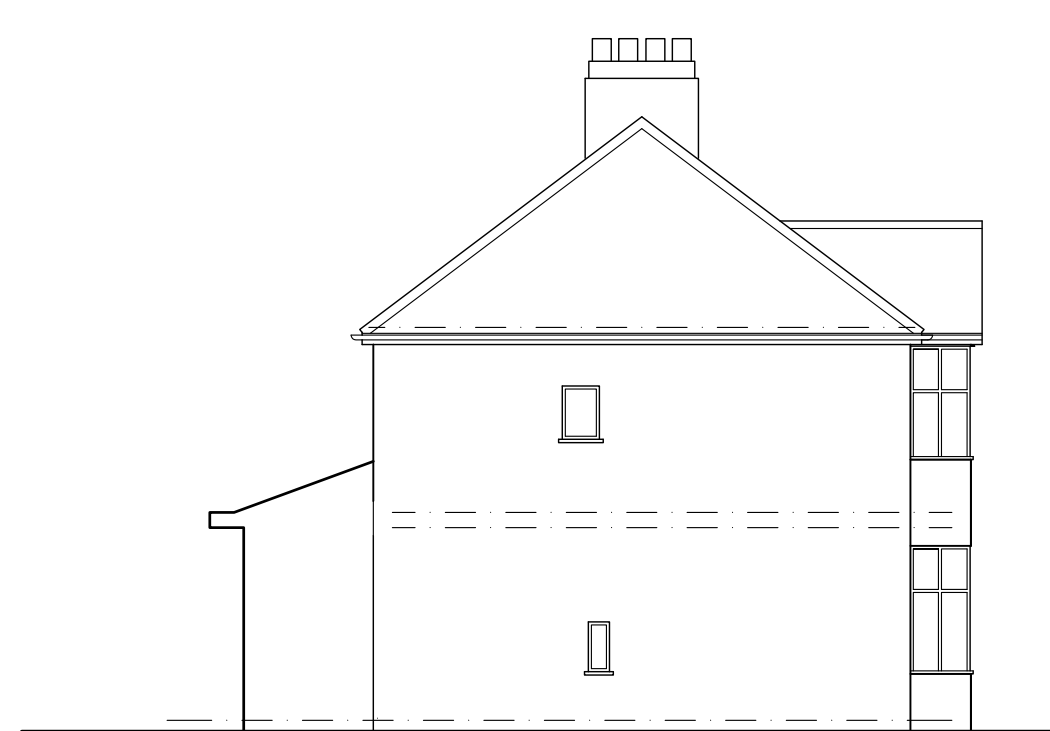

EXISTING SIDE ELEVATION



EXISTING REAR ELEVATION



EXISTING SIDE ELEVATION

Scale 1:100

1 2 3 4 5m

SUBJECT TO Approval

CLIENT 11 MORDEN GARDENS GREENFORD UB6	PROJECT PART TWO STOREY/PART SINGLE STOREY SIDE AND REAR EXTENSION	DRAWING Existing Elev 1	STAGE Building Control	CHECKED SCALE 1:100 @A3	APPROVED DATE
DRAWING No. 1 7 C H A W O R T H - 0 5				REV A	

ANY CHANGES FROM APPROVED DRAWINGS ARE THE RESPONSIBILITY OF CLIENT/CONTRACTOR - PLEASE READ CLAUSED BELOW BEFORE WORKS COMMENCE

Any dimensions taken from this drawing should be cross checked on site and approved prior to any construction works. The contractor shall be responsible for taking all necessary site dimensions and levels and for all exploratory works to verify any existing structure before commencement of works. The contractor will be responsible for all the correct setting out and temporary supports of works on site to property and neighbouring properties

No liability taken of any kind is accepted by Architect for any error or omission Where new work is near/on boundary line/party wall the property owner is to serve party wall notice to the adjoining property/land owner in accordance with the requirements of the 'Party Wall etc.' Act 1996

Contractor responsible for notifying of Building Control Surveyor of each stage of works and ensure inspections have been made. All details to comply with current building regulations and Building Control Approval. Work not to commence until approval of plans by Building Control Body. Any works that commence before Building Regulations drawings have been approved is responsibility of client.

After confirmation from local authority that prior approval is not required, proposed extension must comply with all permitted development criteria set out under the General Permitted Development Order 1995


Any development carried out without Permitted Development Certificate is at owner's own risk. It is strongly advised that a Permitted Development Certificate/Certificate of Lawfulness is sought prior to commencement of any works

- FD30** All habitable room doors to be replaced with FD30 doors with 38x25mm Door Stops and 3 No Stainless Steel Hinges. Middle Hinge to be installed at least 2/3 of way up door frame
- SD** Mains powered with battery back up interlinked smoke detector to be installed within at least 7.5m of all habitable rooms and at least 30cm from any light fitting or wall
- HD** Mains powered and interlinked operated heat detector with battery back up
- Ex** Extractor fan for shower room - 15l/s and Kitchen 30l/s to be taken through to run and expel externally


For Structural Steelwork refer to Structural Engineer's Drawing. Beams indicated by red dashed lines (see right)
 All Steel work to be encased in 2 layers of FireLine Board with staggered joints or fire resisting intumescent paint in accordance with manufacturer's guidance to provide minimum 60min fire resistance
 All Steel work to only be ordered once contractor has confirmed dimensions on site and positioning with client. Any discrepancies noted to be discussed with Surveyor prior to ordering any steel work. No responsibility taken by Surveyor for steels ordered to match site conditions

A-Z Building Services

A: Addlestone KT15
 E: hthus@n0809@msn.com
 T: 07969925562

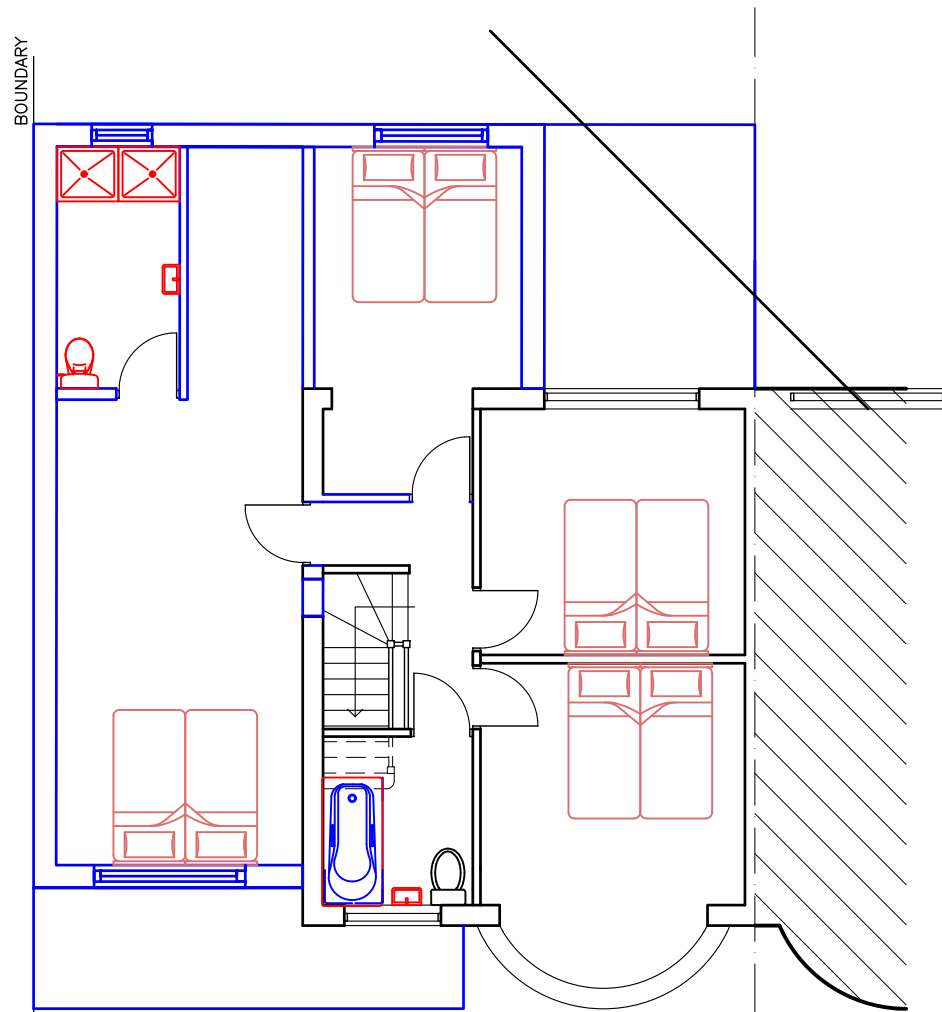

PROPOSED FIRST FLOOR PLAN

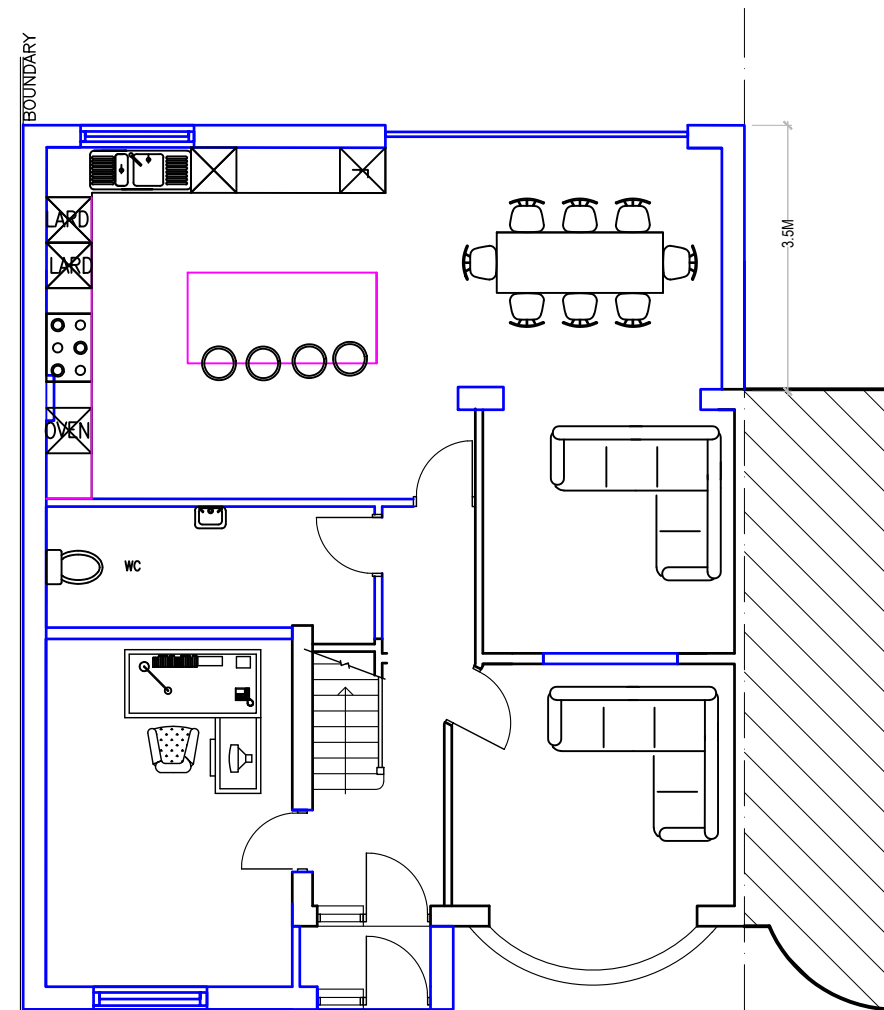

PROPOSED GROUND FLOOR PLAN

Scale 1:100



SUBJECT TO Approval

CLIENT 11 MORDEN GARDENS GREENFORD UB6	PROJECT PART TWO STOREY/PART SINGLE STOREY SIDE AND REAR EXTENSION	DRAWING Proposed PLANS	STAGE Building Control	CHECKED SCALE 1:50 @A3	APPROVED DATE
DRAWING No. 1 7 C H A W O R T H - 0 6				REV A	

ANY CHANGES FROM APPROVED DRAWINGS ARE THE RESPONSIBILITY OF CLIENT/CONTRACTOR - PLEASE READ CLAUSED BELOW BEFORE WORKS COMMENCE

Any dimensions taken from this drawing should be cross checked on site and approved prior to any construction works. The contractor shall be responsible for taking all necessary site dimensions and levels and for all exploratory works to verify any existing structure before commencement of works. The contractor will be responsible for all the correct setting out and temporary supports of works on site to property and neighbouring properties

No liability taken of any kind is accepted by Architect for any error or omission Where new work is near/on boundary line/party wall the property owner is to serve party wall notice to the adjoining property/land owner in accordance with the requirements of the 'Party Wall etc.' Act 1996

Contractor responsible for notifying of Building Control Surveyor of each stage of works and ensure inspections have been made. All details to comply with current building regulations and Building Control Approval. Work not to commence until approval of plans by Building Control Body. Any works that commence before Building Regulations drawings have been approved is responsibility of client.


NOTE

Any alterations to these drawings or changes effect on site during construction, could materially affect sizes of structural members that have been designed and adopted on plan. The latter should be brought to the notice of the structural engineer with specific instructions to prepare revised calculations to accommodate the changes made. No inspection of the existing soil conditions has been made by the designer, and no information appertaining to the latter have been offered. The bearing capacity of soil is Assumed 100 KN/m2. No work appertaining to the plans should be carried out until the plan and calculations have been examined by the local authority, and formal written approval obtained. Any works carried out before such approval is obtained, is done solely at contractors or owners risk. The availability of new and or existing foundation to sustain the new loading arrangement should be verified on site & agreement reached with the Building Control Officer and appropriate changes made where applicable. The condition of all existing load bearing walls to be verified on site and agreement reached with Building Control Officer as to their suitability. Any additional Loads on existing lintels need to be exposed and verified by Building Control

A-Z Building Services


A: Addlestone KT15
E: hthus@msn.com
T: 07969925562

BOUNDARY

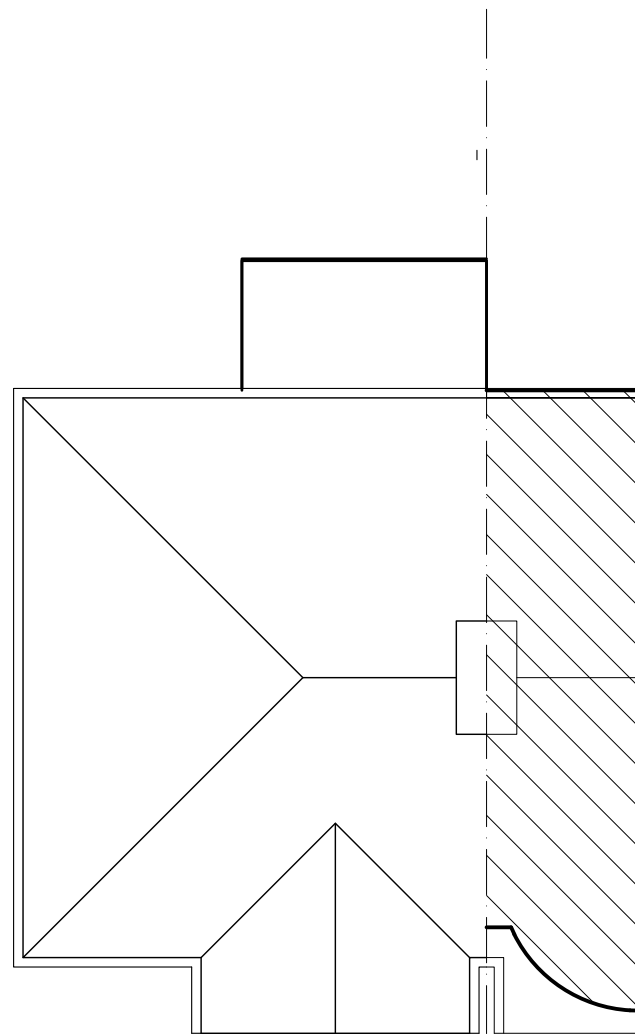

EXISTING ROOF PLAN

BOUNDARY

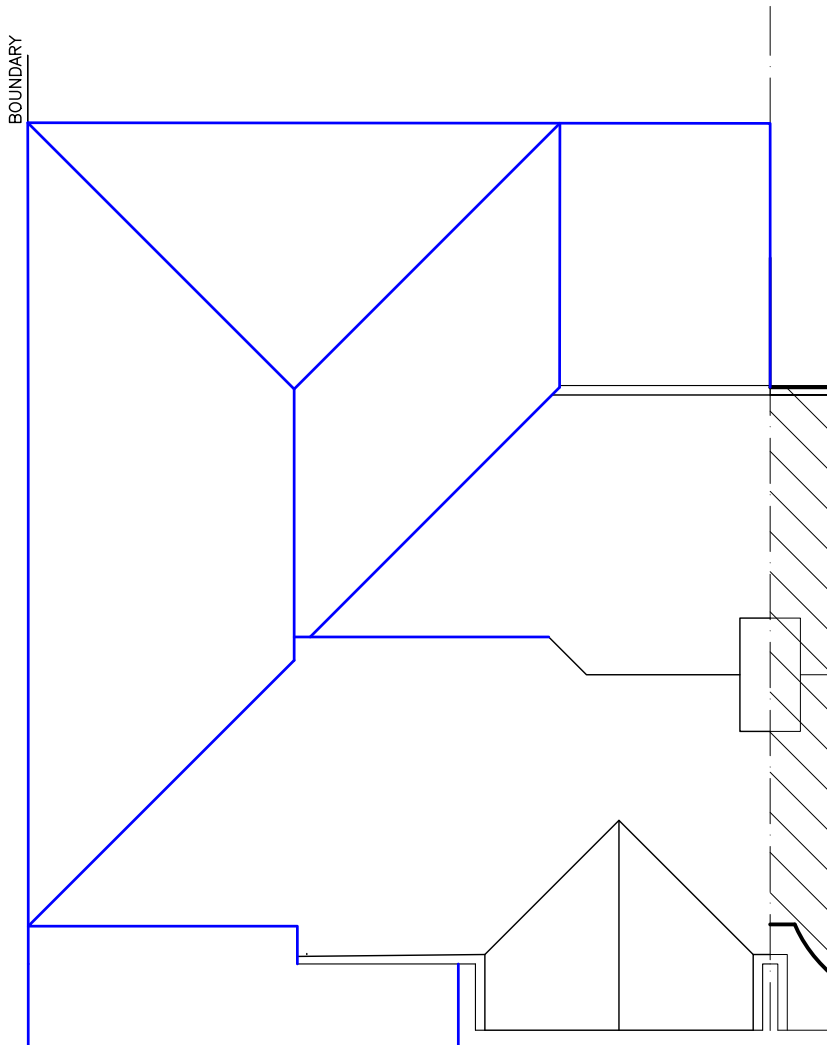

PROPOSED ROOF PLAN

Scale 1:100




SUBJECT TO Approval


CLIENT 11 MORDEN GARDENS GREENFORD UB6	PROJECT PART TWO STOREY/PART SINGLE STOREY SIDE AND REAR EXTENSION	DRAWING ROOF PLANS	STAGE Building Control	CHECKED SCALE 1:50 @A3	APPROVED DATE
DRAWING No. 1 7 C H A W O R T H - 0 7				REV A	




PROPOSED FRONT ELEVATION

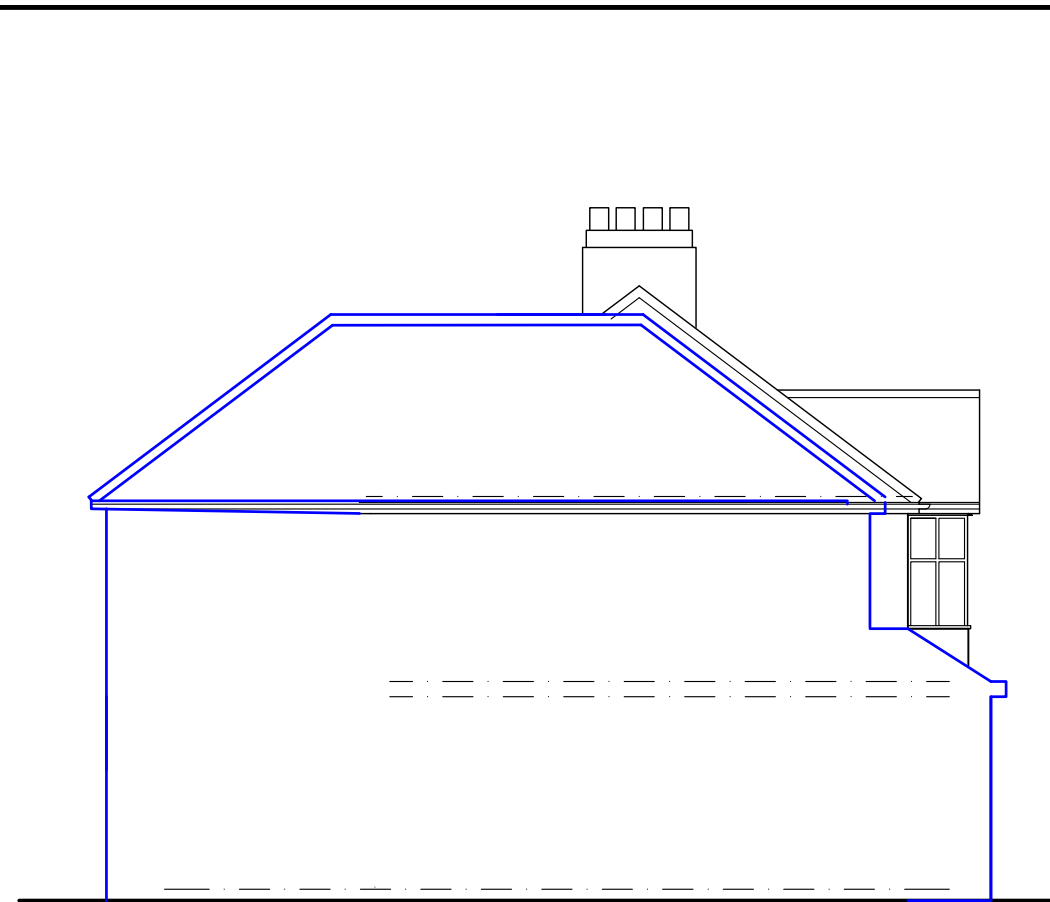

PROPOSED SIDE ELEVATION

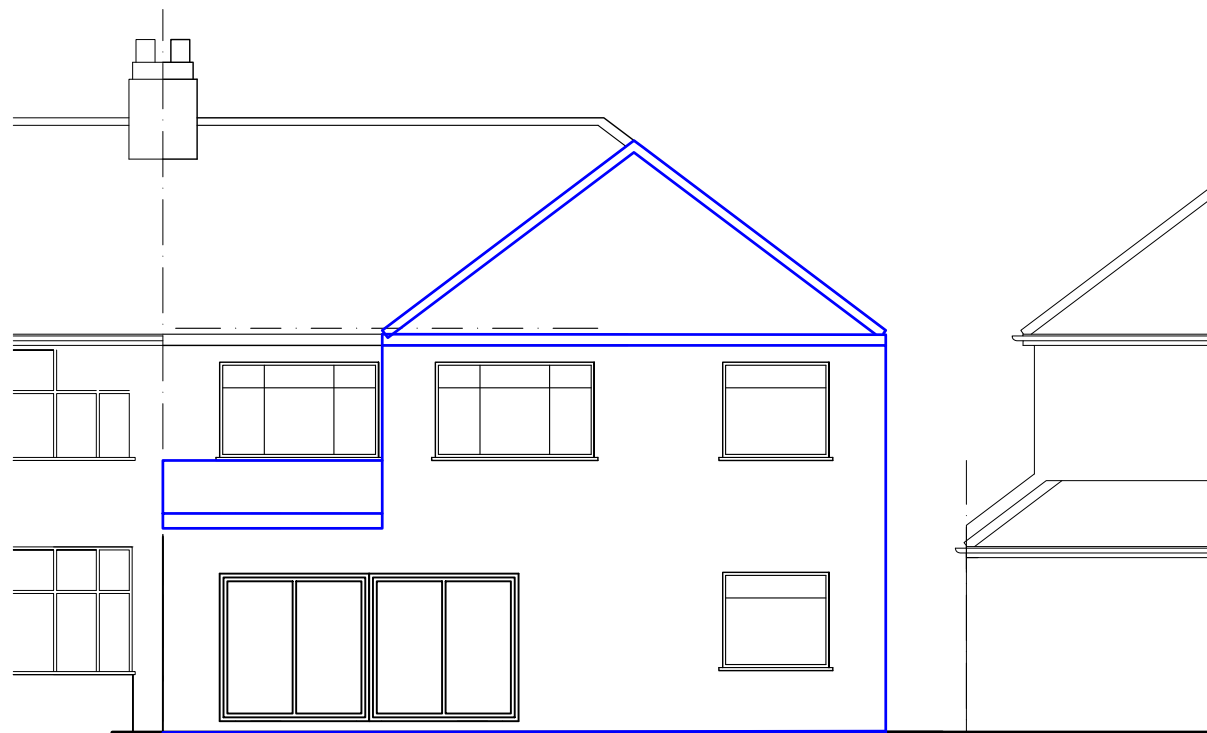

PROPOSED REAR ELEVATION

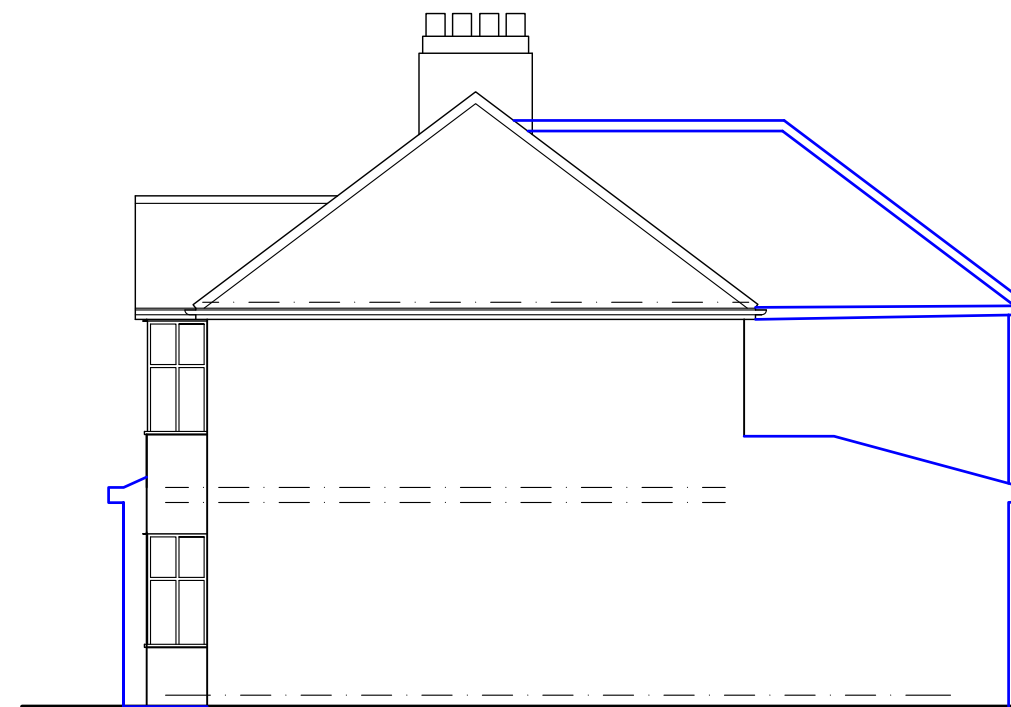

PROPOSED SIDE ELEVATION

ANY CHANGES FROM APPROVED DRAWINGS ARE THE RESPONSIBILITY OF CLIENT/CONTRACTOR - PLEASE READ CLAUSED BELOW BEFORE WORKS COMMENCE

Any dimensions taken from this drawing should be cross checked on site and approved prior to any construction works. The contractor shall be responsible for taking all necessary site dimensions and levels and for all exploratory works to verify any existing structure before commencement of works. The contractor will be responsible for all the correct setting out and temporary supports of works on site to property and neighbouring properties

No liability taken of any kind is accepted by Architect for any error or omission Where new work is near/on boundary line/party wall the property owner is to serve party wall notice to the adjoining property/land owner in accordance with the requirements of the 'Party Wall etc.' Act 1996

Contractor responsible for notifying of Building Control Surveyor of each stage of works and ensure inspections have been made. All details to comply with current building regulations and Building Control Approval. Work not to commence until approval of plans by Building Control Body. Any works that commence before Building Regulations drawings have been approved is responsibility of client.

After confirmation from local authority that prior approval is not required, proposed extension must comply with all permitted development criteria set out under the General Permitted Development Order 1995

Any development carried out without Permitted Development Certificate is at owner's own risk. It is strongly advised that a Permitted Development Certificate/Certificate of Lawfulness is sought prior to commencement of any works

- FD30 FD30 All habitable room doors to be replaced with FD30 doors with 38x25mm Door Stops and 3 No Stainless Steel Hinges. Middle Hinge to be installed at least 2/3 of way up door frame
- SD Mains powered with battery back up interlinked smoke detector to be installed within at least 7.5m of all habitable rooms and at least 30cm from any light fitting or wall
- HD Mains powered and interlinked operated heat detector with battery back up
- Ex Extractor fan for shower room - 15l/s and Kitchen 30l/s to be taken through to run and expel externally

For Structural Steelwork refer to Structural Engineer's Drawing. Beams indicated by red dashed lines (see right)

All Steel work to be encased in 2 layers of FireLine Board with staggered joints or fire resisting intumescent paint in accordance with manufacturer's guidance to provide minimum 60min fire resistance

All Steel work to only be ordered once contractor has confirmed dimensions on site and positioning with client. Any discrepancies noted to be discussed with Surveyor prior to ordering any steel work. No responsibility taken by Surveyor for steels ordered to match site conditions

A-Z Building Services

A: Addlestone KT15
E: hthusyjn0809@msn.com
T: 07969925562

Scale 1:100



SUBJECT TO Approval

CLIENT 11 MORDEN GARDENS GREENFORD UB6	PROJECT PART TWO STOREY/PART SINGLE STOREY SIDE AND REAR EXTENSION	DRAWING Proposed ELEVATIONS	STAGE Building Control	CHECKED SCALE 1:50 @A3	APPROVED DATE
DRAWING No. 1 7 C H A W O R T H - 0 8				REV A	