




FRONT ELEVATION  
SCALE 1:100

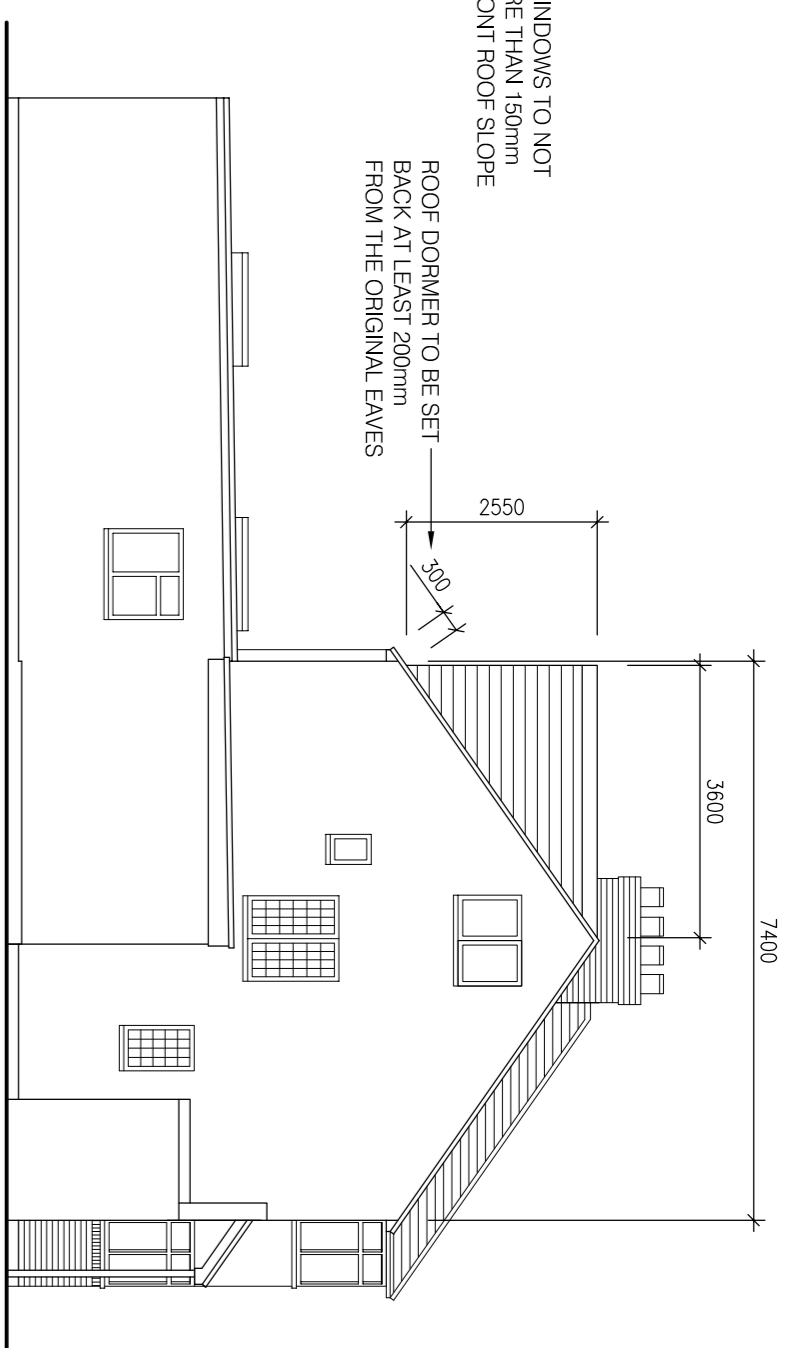

SIDE ELEVATION  
SCALE 1:100

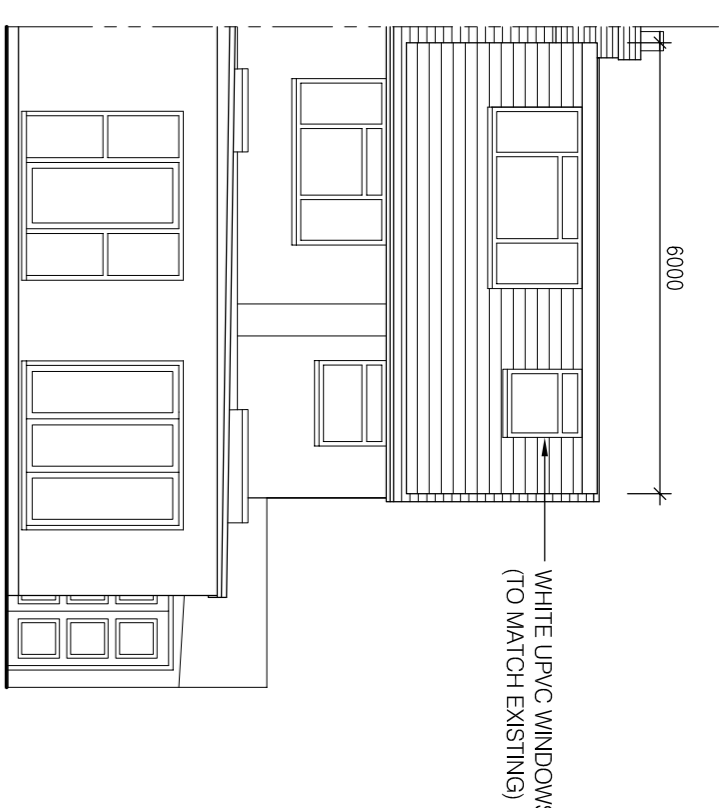


REAR ELEVATION  
SCALE 1:100


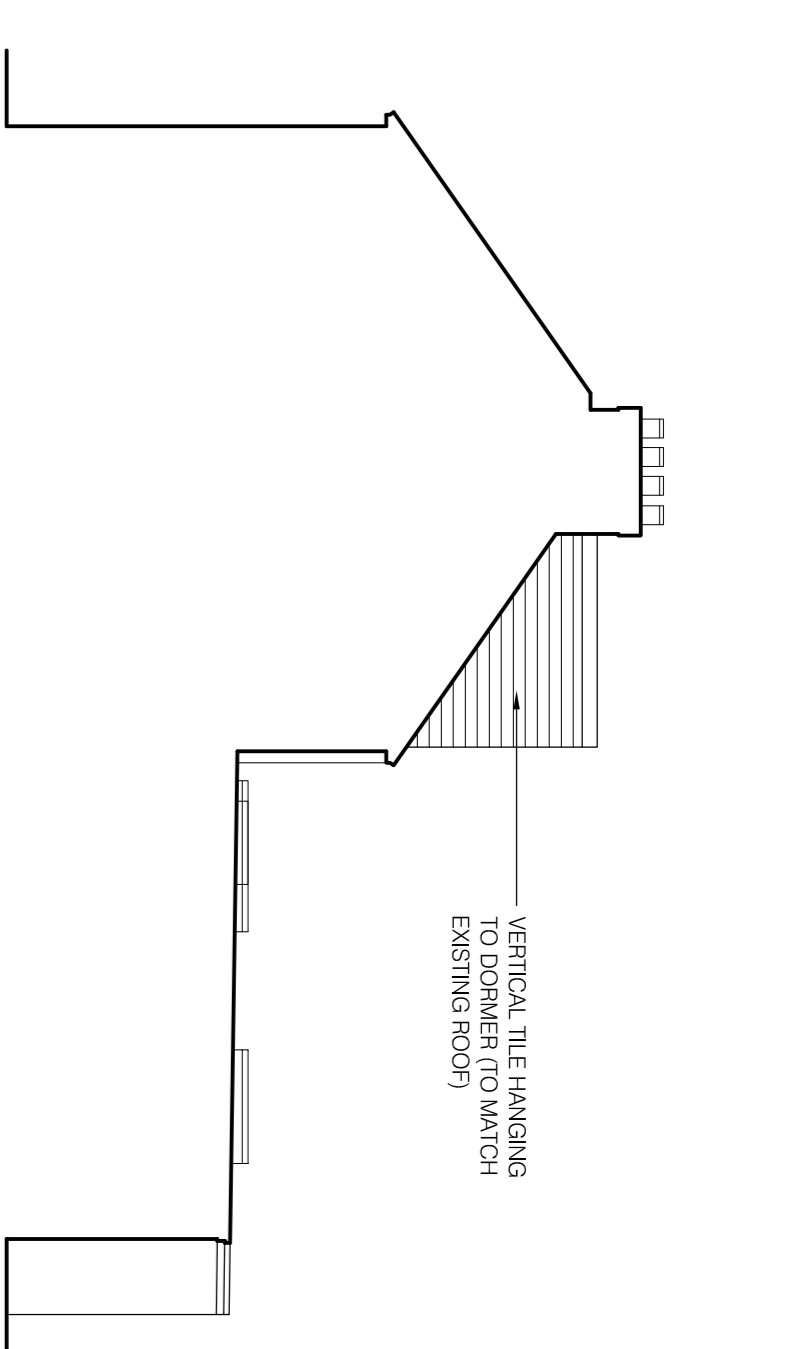


SIDE ELEVATION  
SCALE 1:100


LOFT CONVERSION VOLUME CALCULATIONS  
 HP TO GABLE EXTENSION =  $116 \times 7.4m \times 3.75m \times 2.85m = 1226$  CUBIC METRES  
 ROOF DORMER EXTENSION =  $12 \times 3.6m \times 2.55m \times 6.0m = 2754$  CUBIC METRES  
 TOTAL VOLUME =  $1226 + 2754 = 3980$  CUBIC METRES (<50 CUBIC METRES)

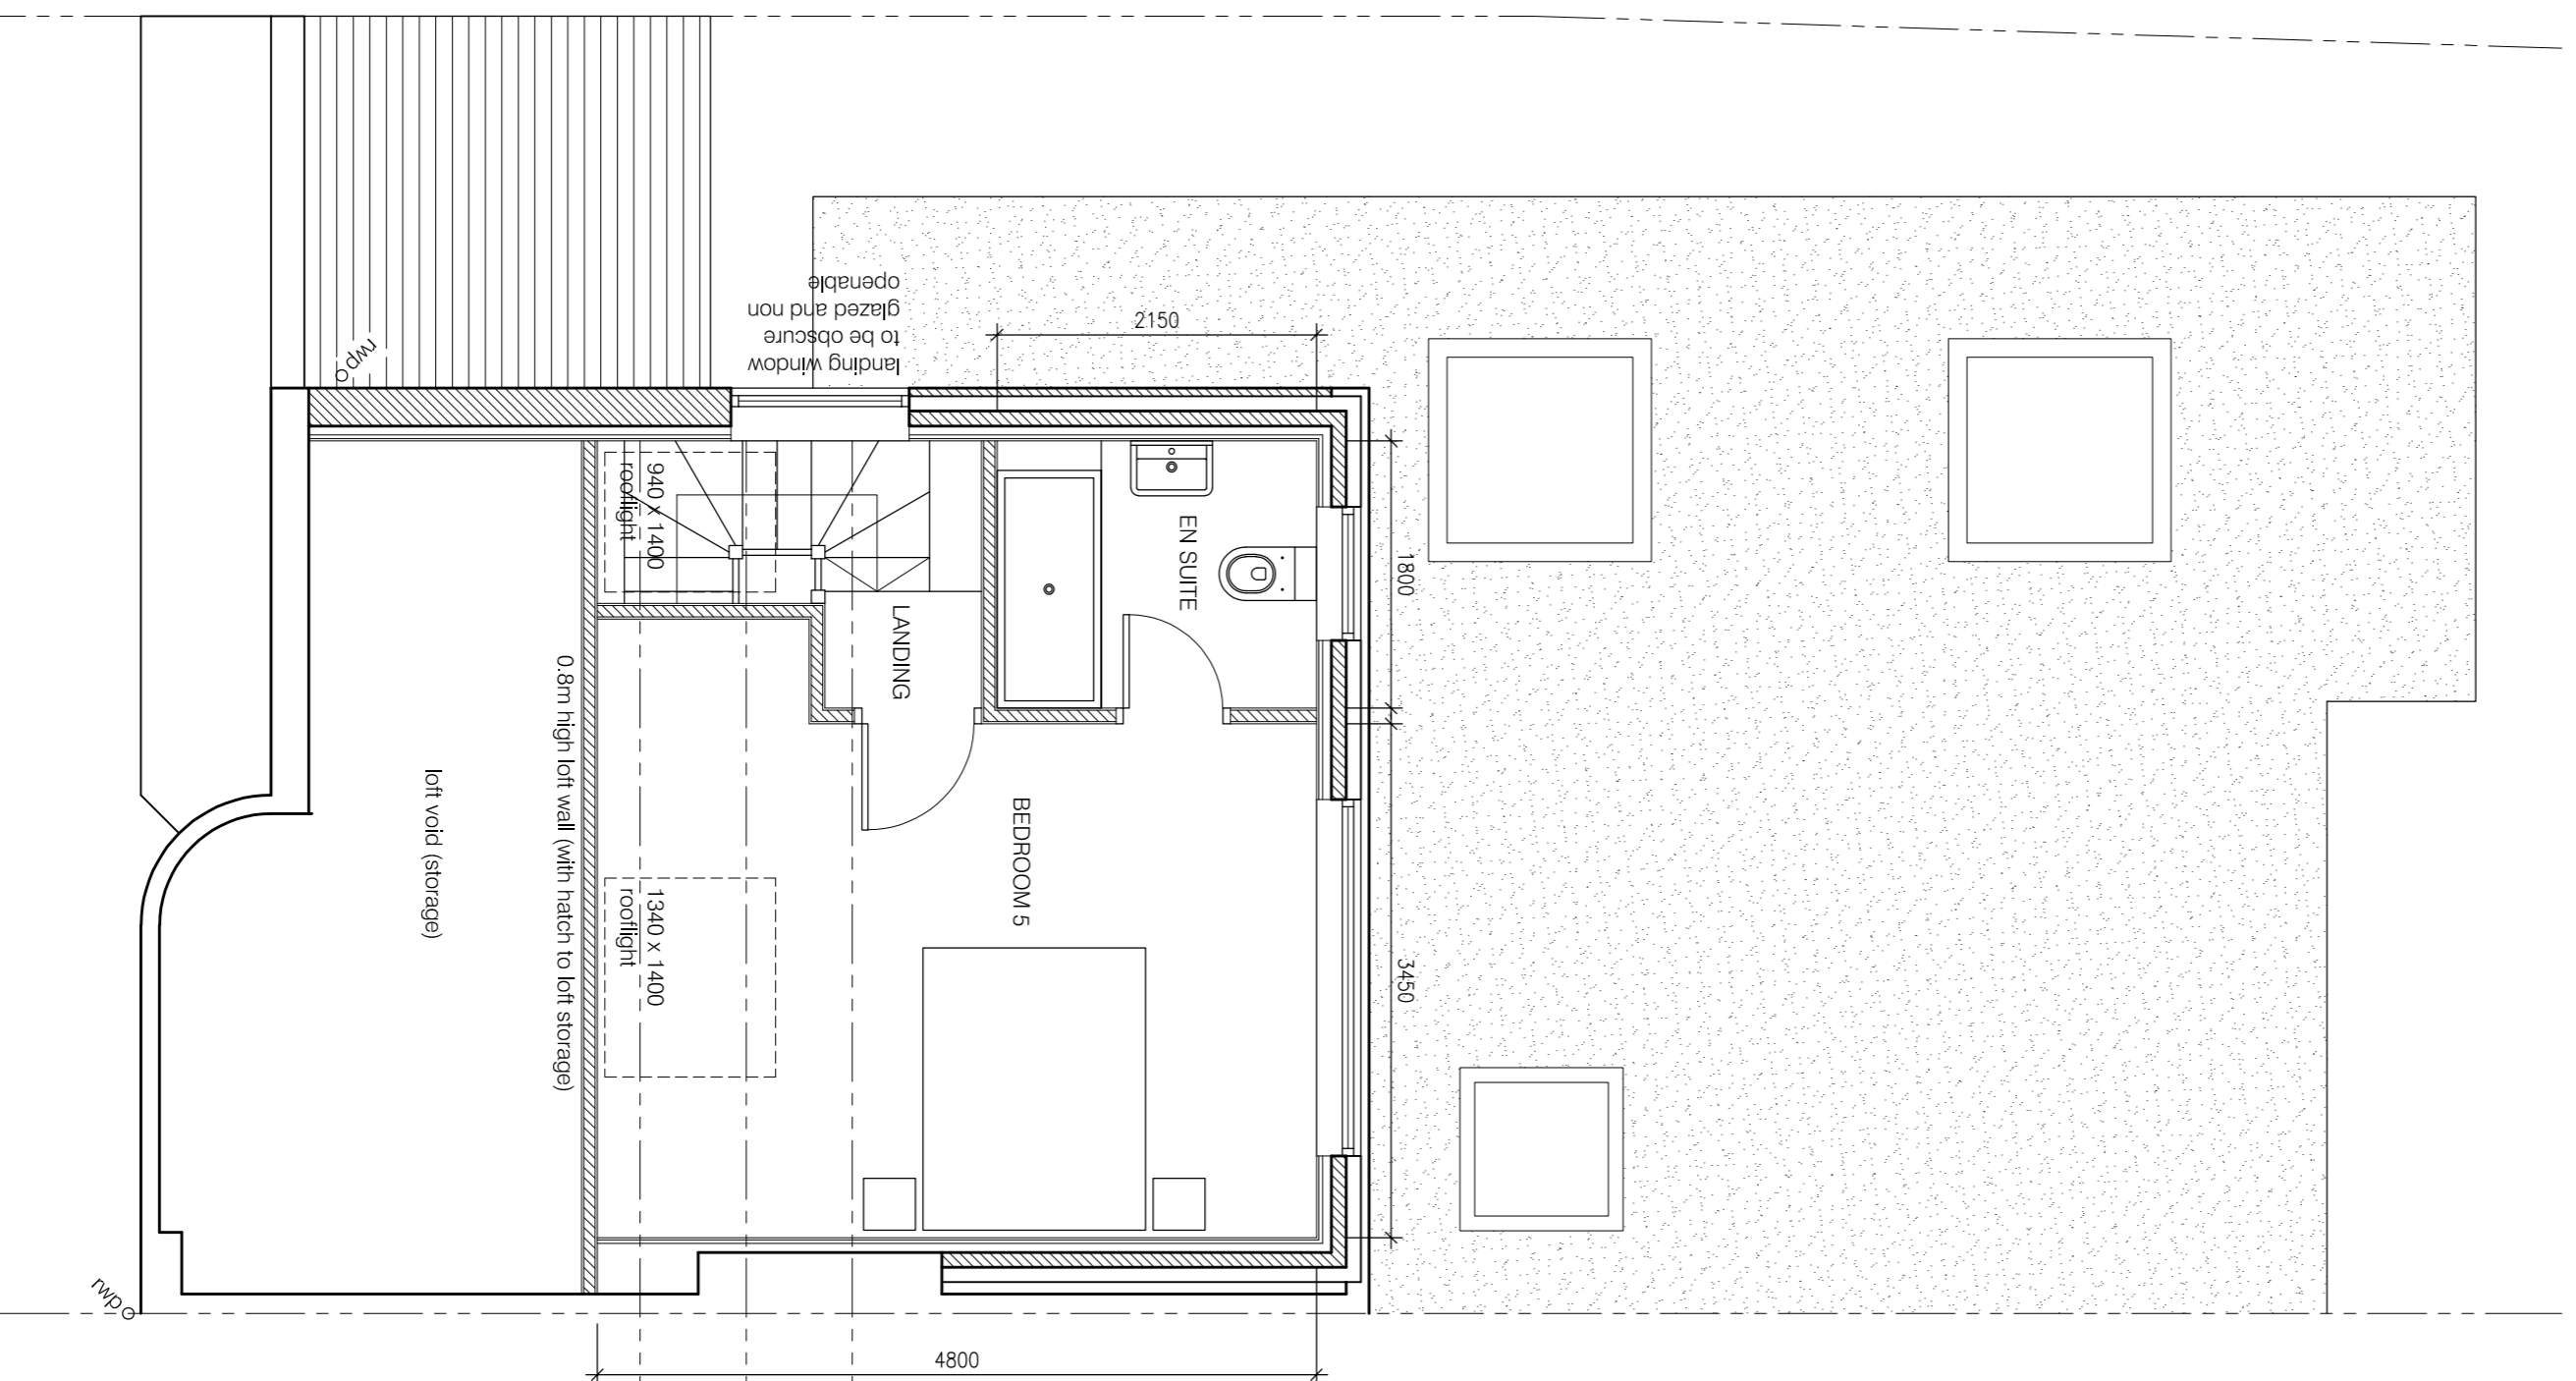

SECOND FLOOR PLAN  
SCALE 1:50

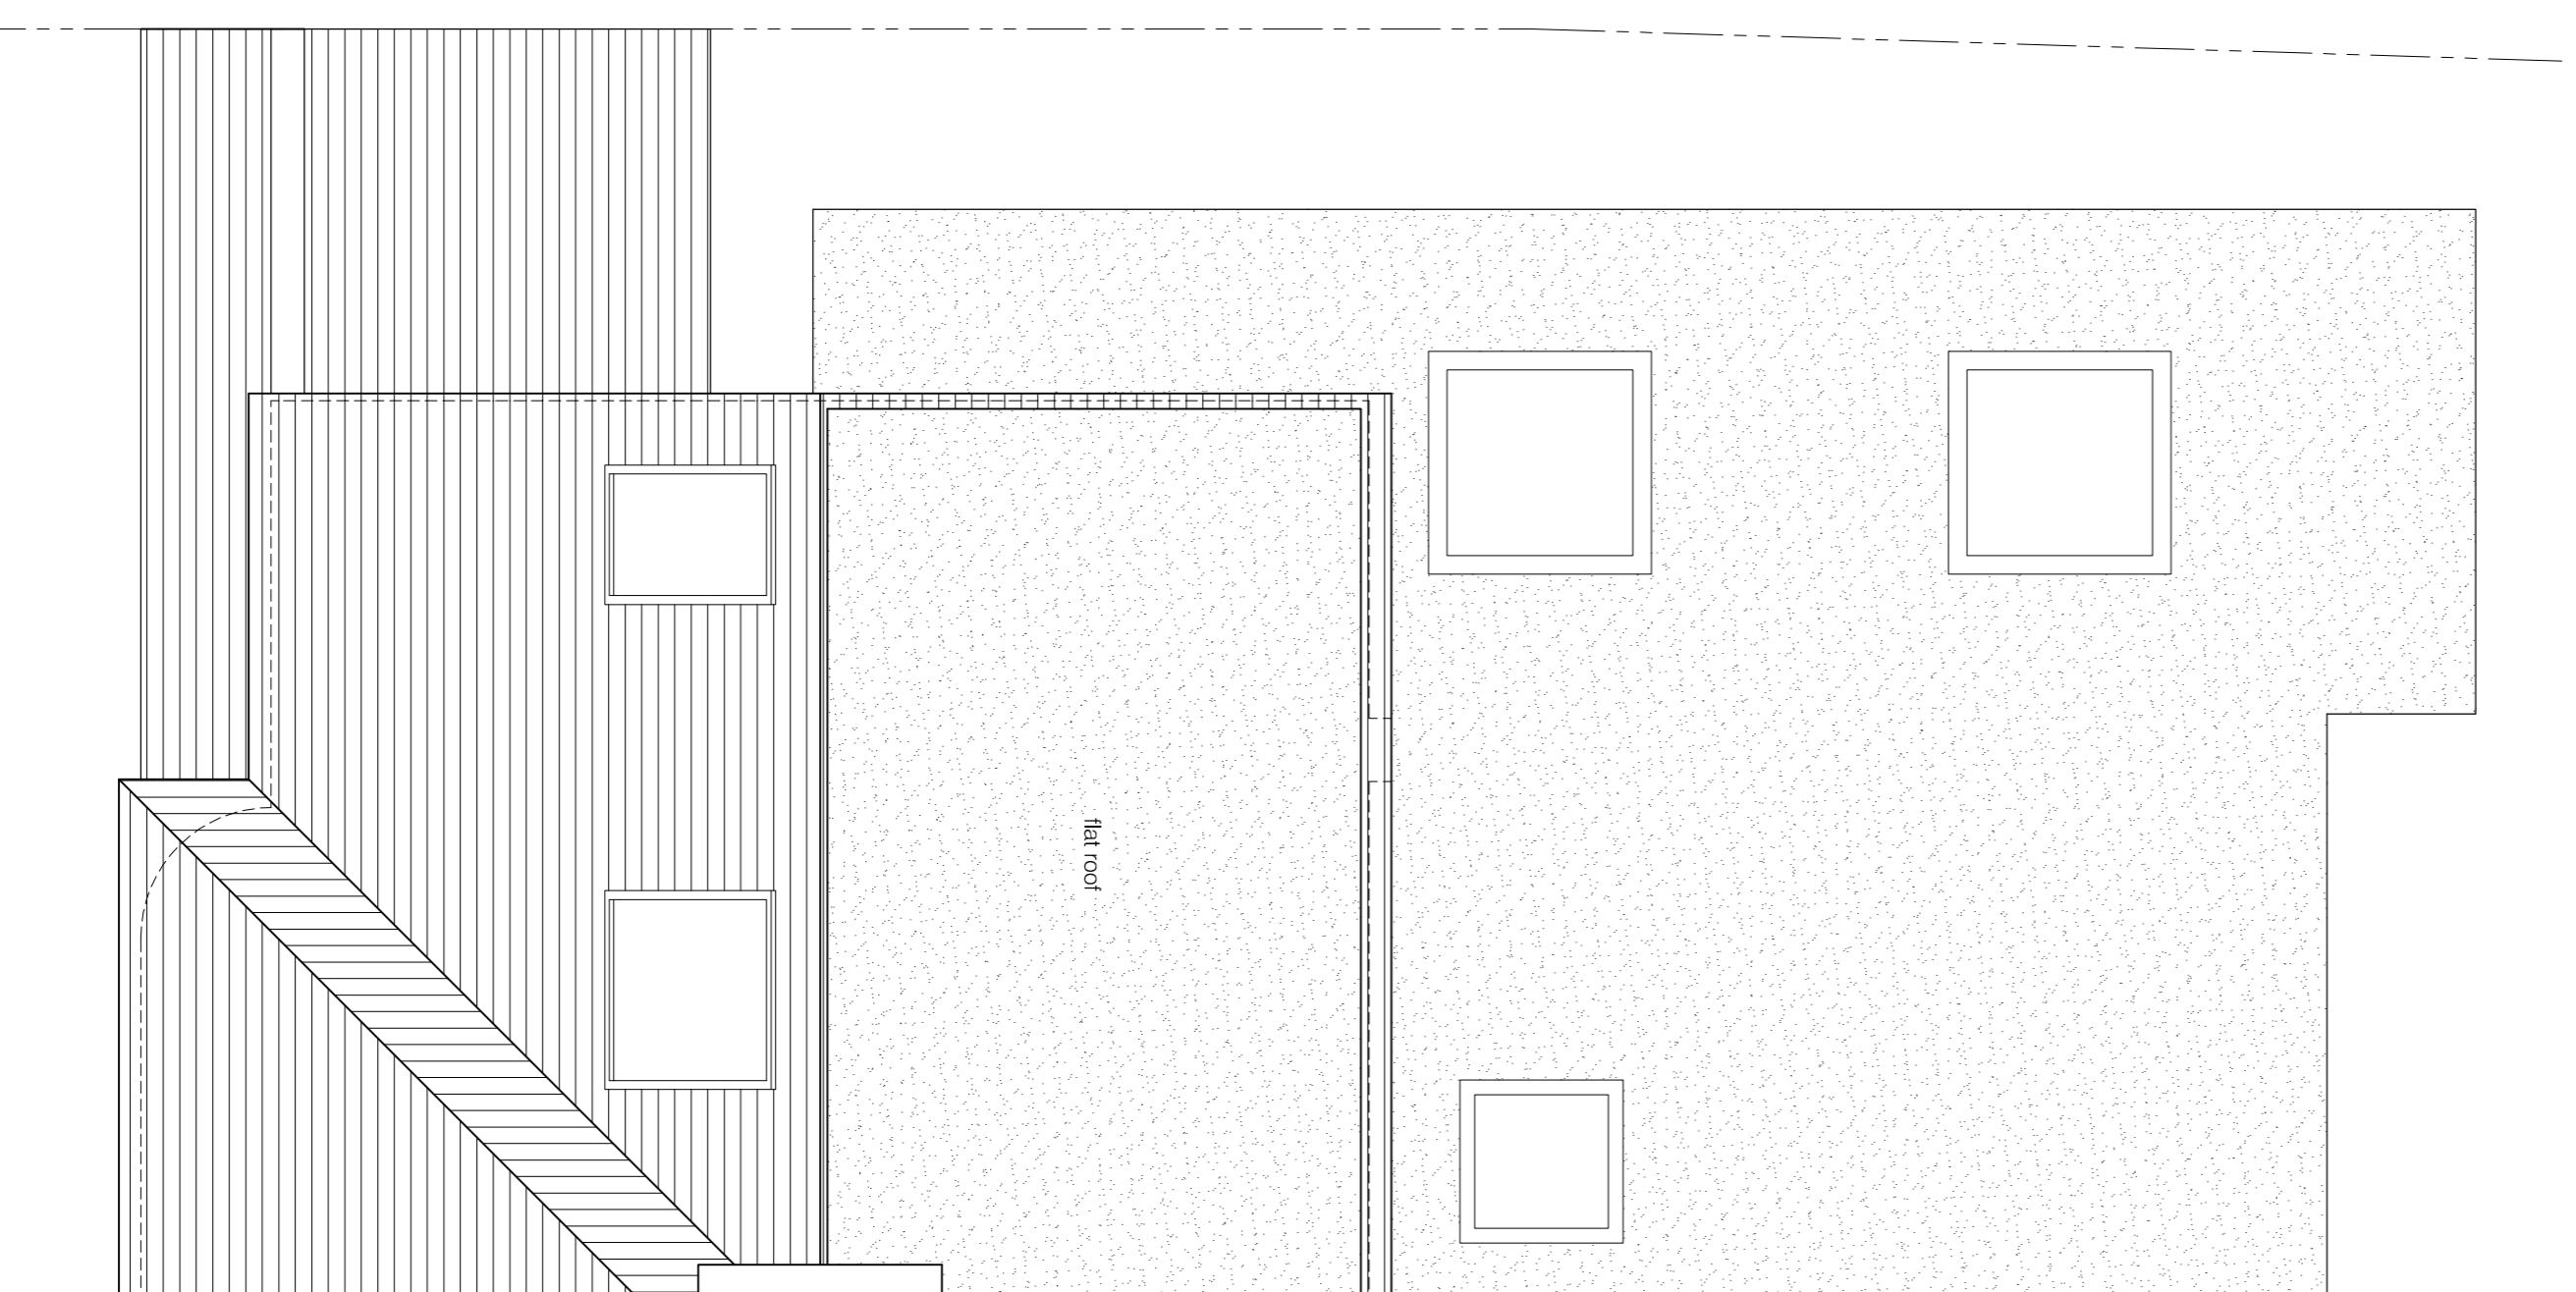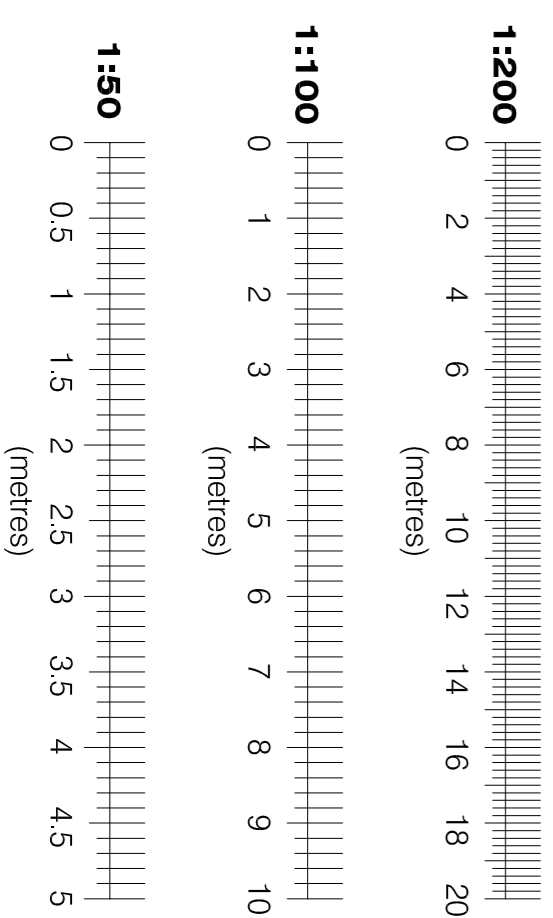

ROOF PLAN  
SCALE 1:50

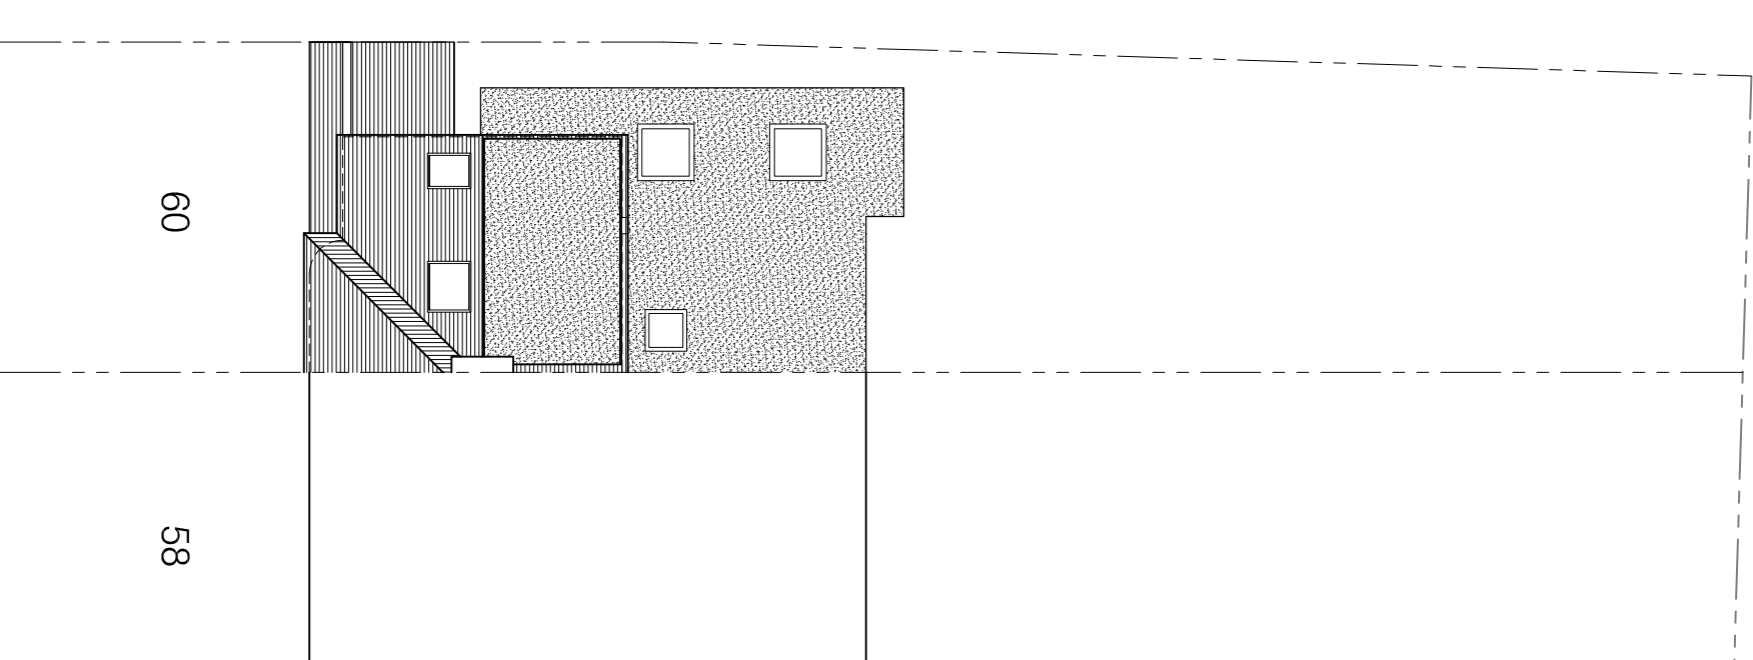

SITE PLAN  
SCALE 1:200

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  3. THIS DRAWING IS NOT TO BE SCALED UNLESS FOR PLANNING PURPOSES. SETTING OUT TO BE FIGURED DIMENSIONS.

Rev.	Date	Revisions

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Client  
MR AND MRS JOHNSON

Job Title  
60 WAVERLEY ROAD  
STONELEIGH  
EPSOM  
KT17 2LS

Drawing Title  
LOFT CONVERSION  
SECOND FLOOR PLAN,  
ROOF PLAN, ELEVATIONS  
AND SITE PLAN

Scale  
1:200, 1:100, 1:50 @ A1

Date FEB 23 Drawn G.J.

Drawing No.  
A1/120/21

Plot Date: 20 FEBRUARY 2024