




The Old Mill

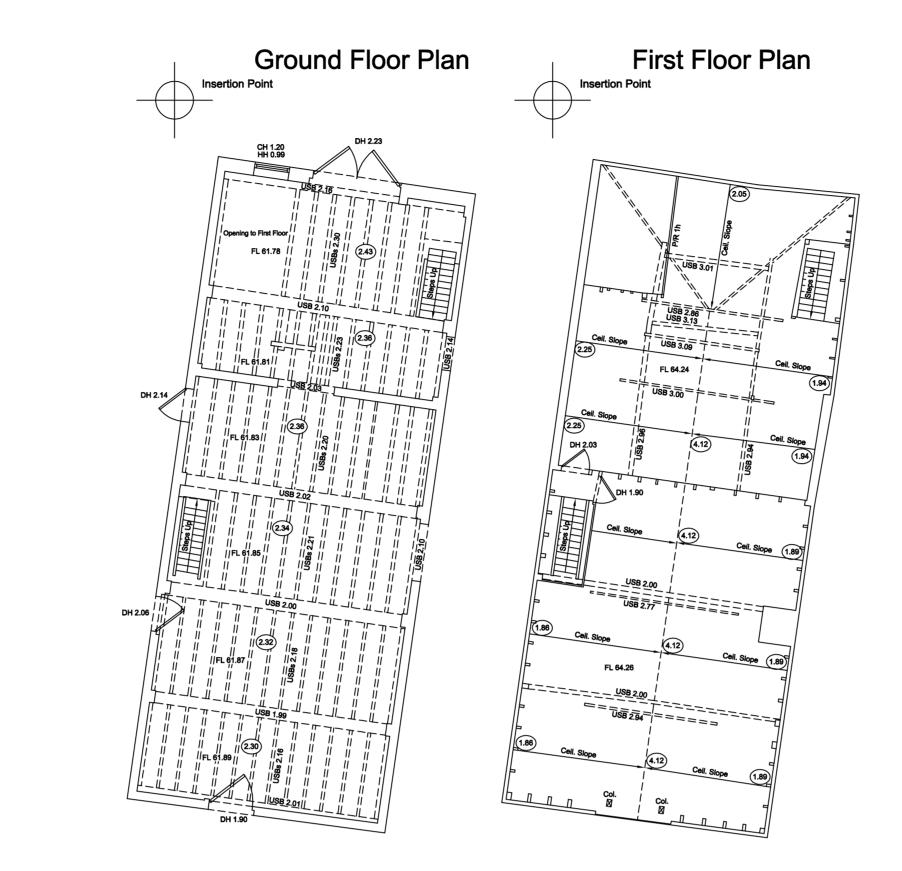

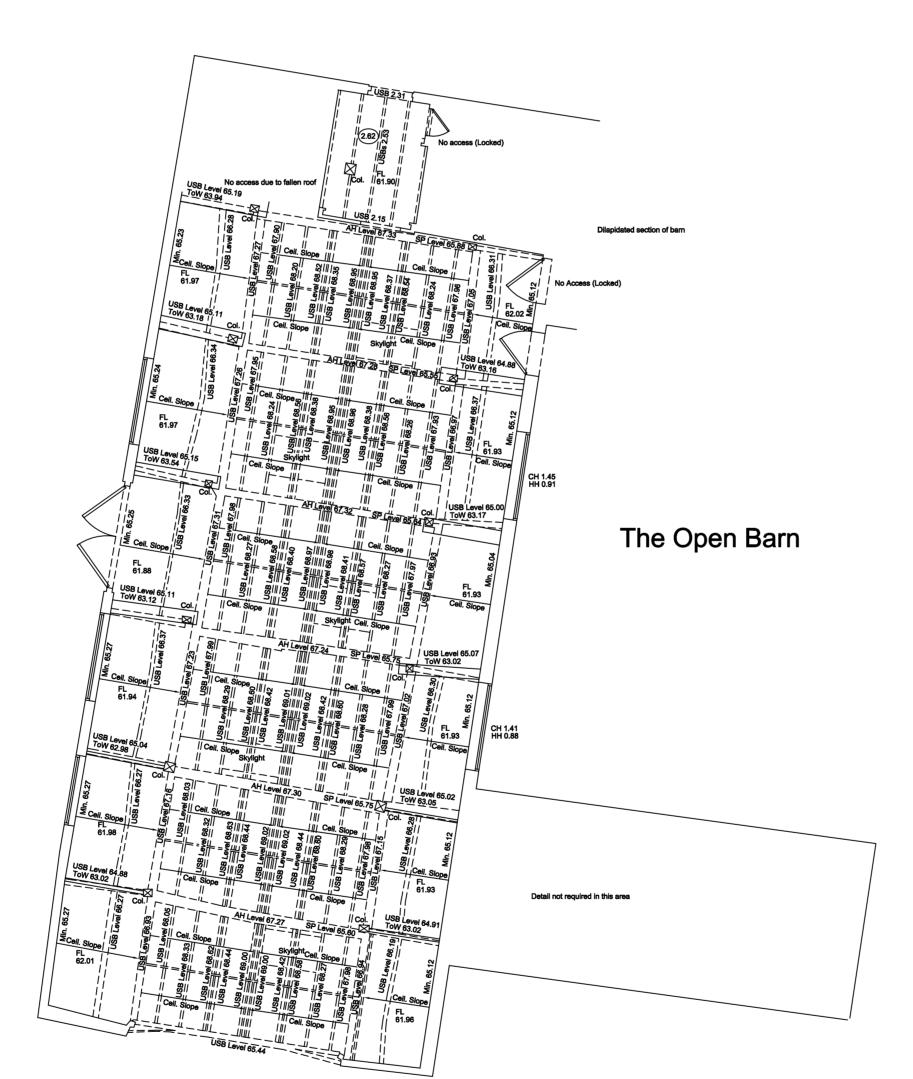

The Grain Barn

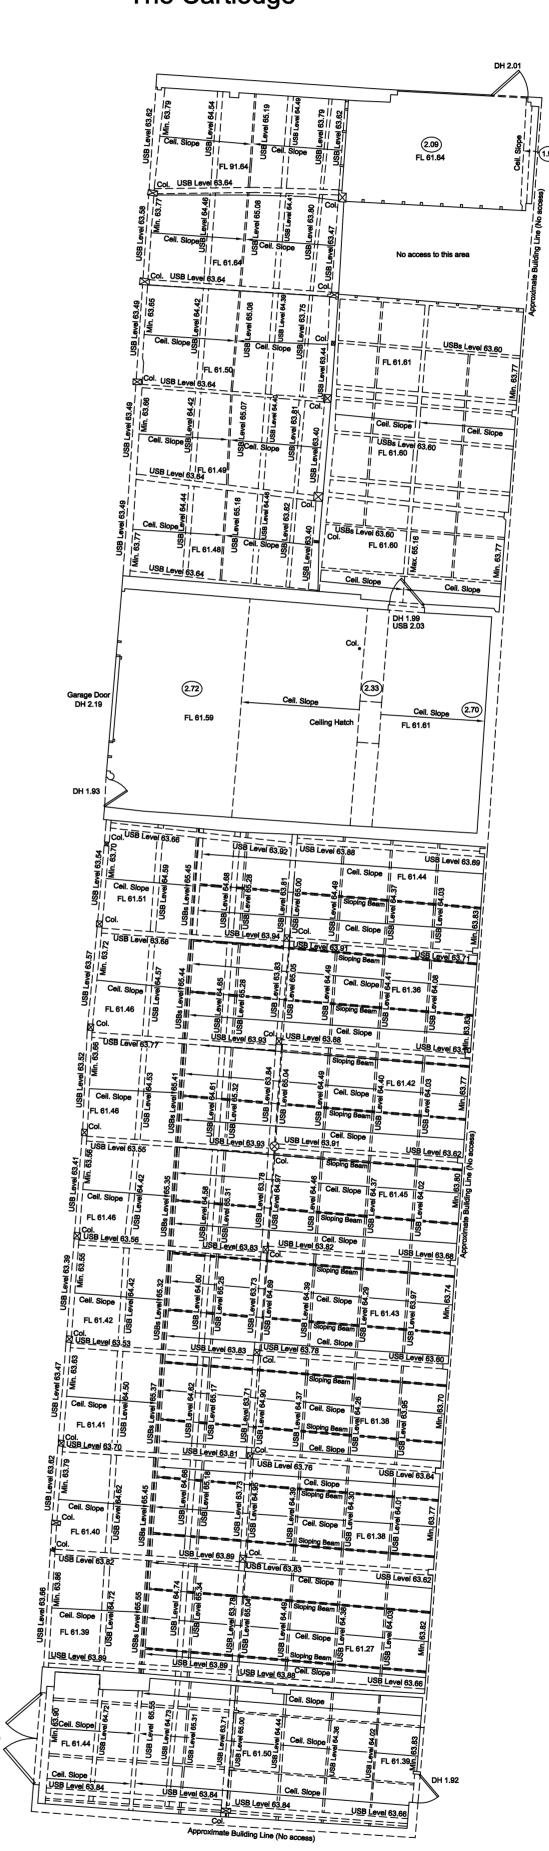

AH Arch Head Height FH Fire Hydrant RSJ Rolled Steel Joist AR Assumed Route FBD Floor Board Direction SI Sign Post
AV Air Valve FH Fire Hydrant SP Arch Spring Point Height
BB Belisha Beacon FL Floor Level SV Stop Valve
BH Bore Hole FP Flag Pole SW Surface Water
BL Bed Level FW Foul Water SY Stay BH Bore Hole
BL Bed Level
BO Bollard GG Gully Grate Tac Tactile Paving BrP Brace Post GV Gas Valve TC Telecom Cover BS Bus Stop
BU Bush HH Head Height TH Trial Pit IC Inspection Cover THL Threshold Level B/W Barbed Wire Fence IL Invert Level TL Traffic Light BX Box (Utilities) I/R Iron Railings ToW Top of Wall C/B Close Board Fence KO Kerb Outlet TP Telegraph Pole CH Cill Height LP Lamp Post
CL Cover Level MH Manhole
C/L Chain Link Fence MP Marker Post TV Cable TV Cover UB Universal Beam UC Unknown Cover C-Lev Ceiling Level NB Name Board UK Unknown Tree
Col Column OHL Overhead Line (approx) USB Under Side Beam
C/P Chestnut Paling Fence Pan Panel Fence UTL Unable To Lift CR Cable Riser PB Post Box DC Drainage Channel PM Parking Meter
DH Door Head Height PO Post DP Down Pipe P/R Post & Rail Fence WL Water Level
DR Drain P/W Post & Wire Fence WM Water Meter EL Eaves Level P/Wall Partition Wall
EP Electric Pole RE Rodding Eye Floor to Ceiling Height FB Flower Bed RS Road Sign FBD Floor Board Direction RSD Roller Shutter Door 🛕 Survey Control Station DRAWING NOTE

TOPOGRAPHICAL & MEASURED BUILDING SURVEYS

Topographical Surveys

ABBREVIATIONS & SYMBOLS

Trees are drawn to scale showing the average canopy spread. Descriptions and heights should be used as a guide only.

All building names, descriptions, number of storeys, construction type including roof line details are indicative only and taken externally from ground level.

All below ground details including drainage, voids and services have been identified from above ground and therefore all details relating to these features including; sizes, depth, description etc will be approximate only. All critical dimensions and connections should be checked and verified prior to starting

Detail, services and features may not have been surveyed if obstructed or not reasonably visible at the time of the survey.

Measured Building Surveys Measurements to internal walls are taken to the wall finishes at approx 1m

above the floor level and the wall assumed to be vertical. Cill heights are measured as floor to the cill and head heights are measured from cill to the top of window.

The contractor must check and verify all site and building dimensions, levels, utilities and drainage details and connections prior to commencing work. Any errors or discrepancies must be notified to Survey Solutions immediately. The accuracy of the digital data is the same as the plotting scale implies. All dimensions are in metres unless otherwise stated.

The survey control listed is only to be used for topographical surveys at the stated scale. All control must be checked and verified prior to use. © Land Survey Solutions Limited holds the copyright to all the information contained within this document and their written consent must be obtained

before copying or using the data other than for the purpose it was originally

Do not scale from this drawing.

CONTROL CO-ORDINATES STATIONS EASTINGS NORTHINGS LEVEL

SURVEY GRID AND LEVEL DATUM All levels relate to previous EALS survey.



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Fax No: 0845 0405 970 enquiries@survey-solutions.co.uk www.survey-solutions.co.uk LAND SURVEYING BUILDING SURVEYING UNDERGROUND SURVEYING

BATTISFORD BARNS, BATTISFORD, SUFFOLK, IP14 2HL. DRAWING DETAIL MEASURED BUILDING SURVEY FLOOR PLANS THE TRUSTEES OF TA HARWOOD

SCALE 1:100 SURVEYOR SURVEY DATE CHECKED BY APPROVED BY DWG STATUS PJR 21/10/2016 CHP TJF FINAL REVISION ISSUE DATE DRAWING NUMBER 18416se-03

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No access to this area

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