






553 Green Lanes
PROPOSED FRONT ELEVATION

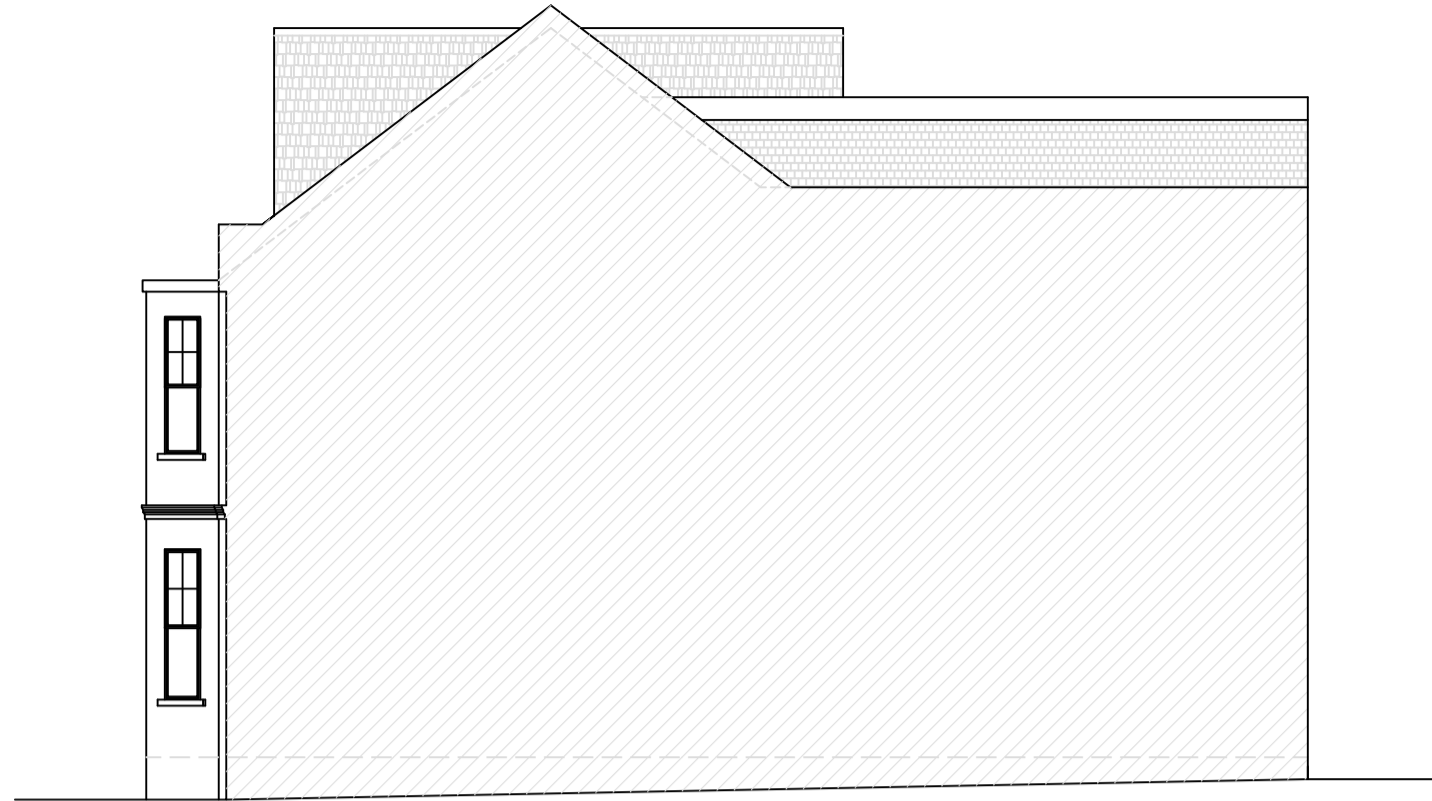


553 Green Lanes
PROPOSED SIDE ELEVATION

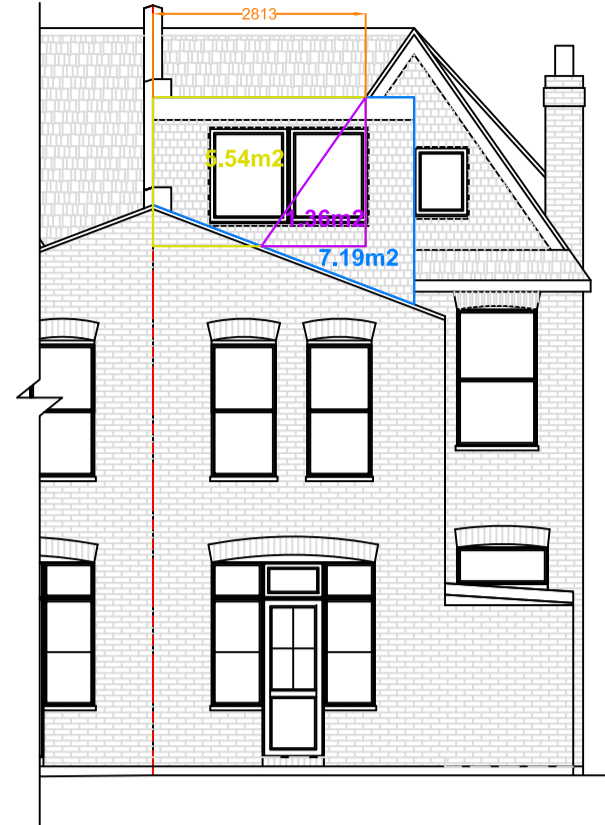


553 Green Lanes
PROPOSED REAR ELEVATION

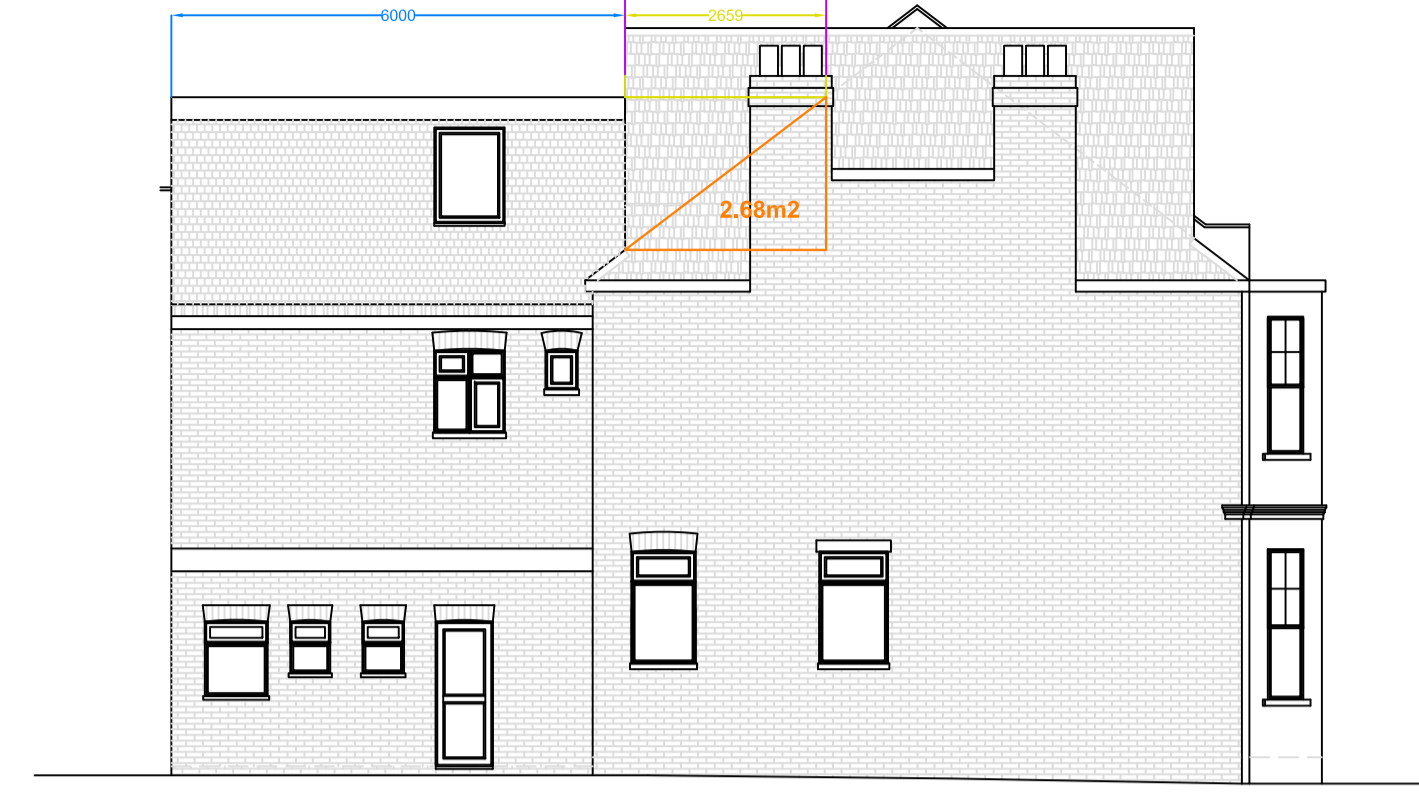


553 Green Lanes
PROPOSED SIDE ELEVATION

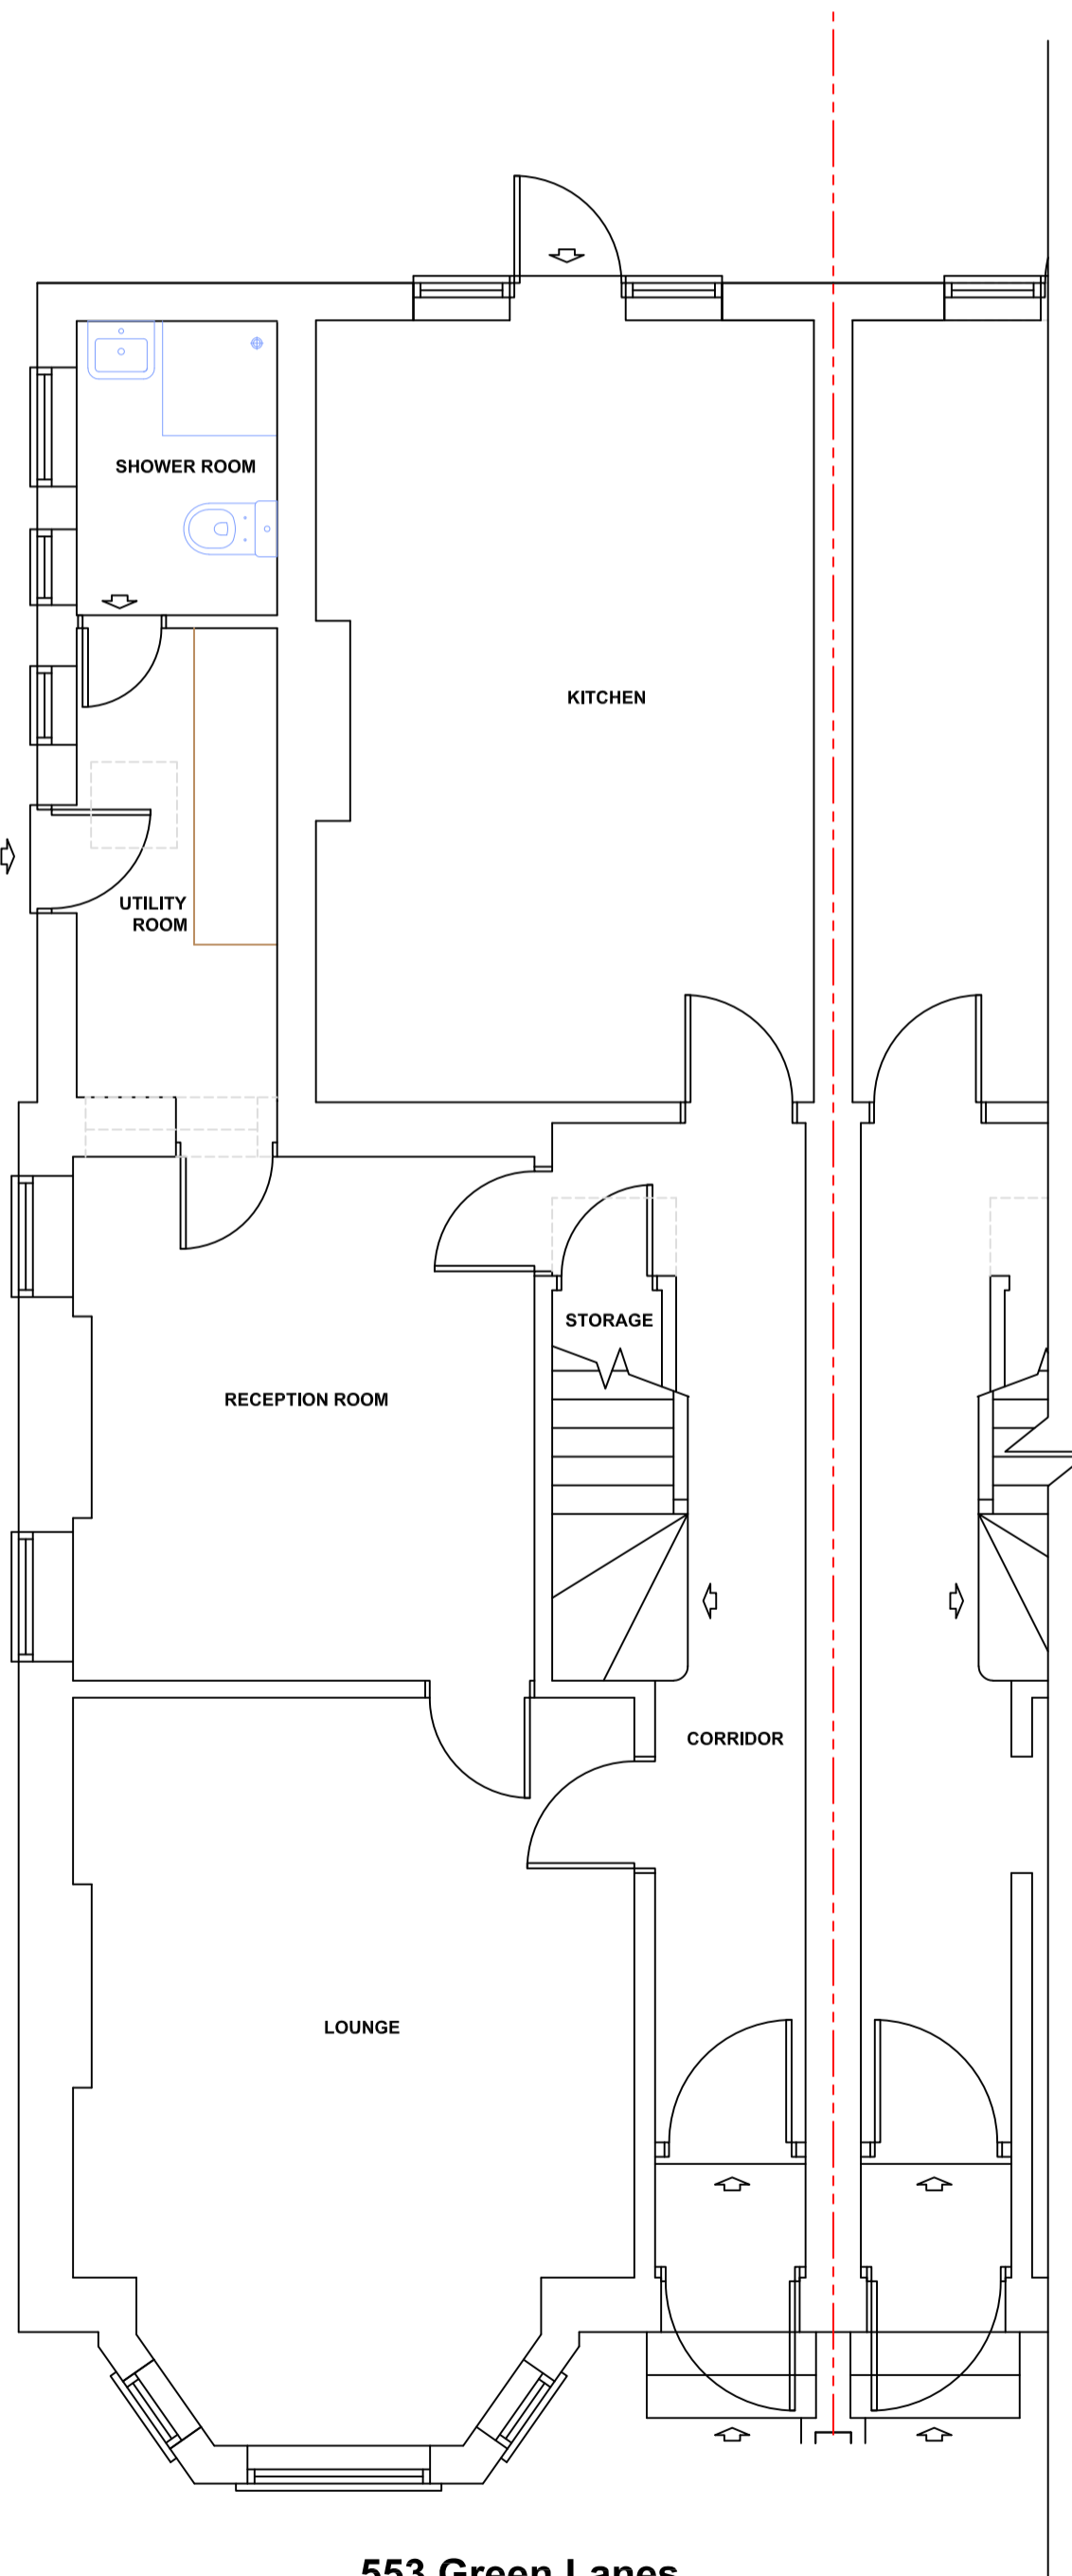

553 Green Lanes
PROPOSED GROUND FLOOR PLAN

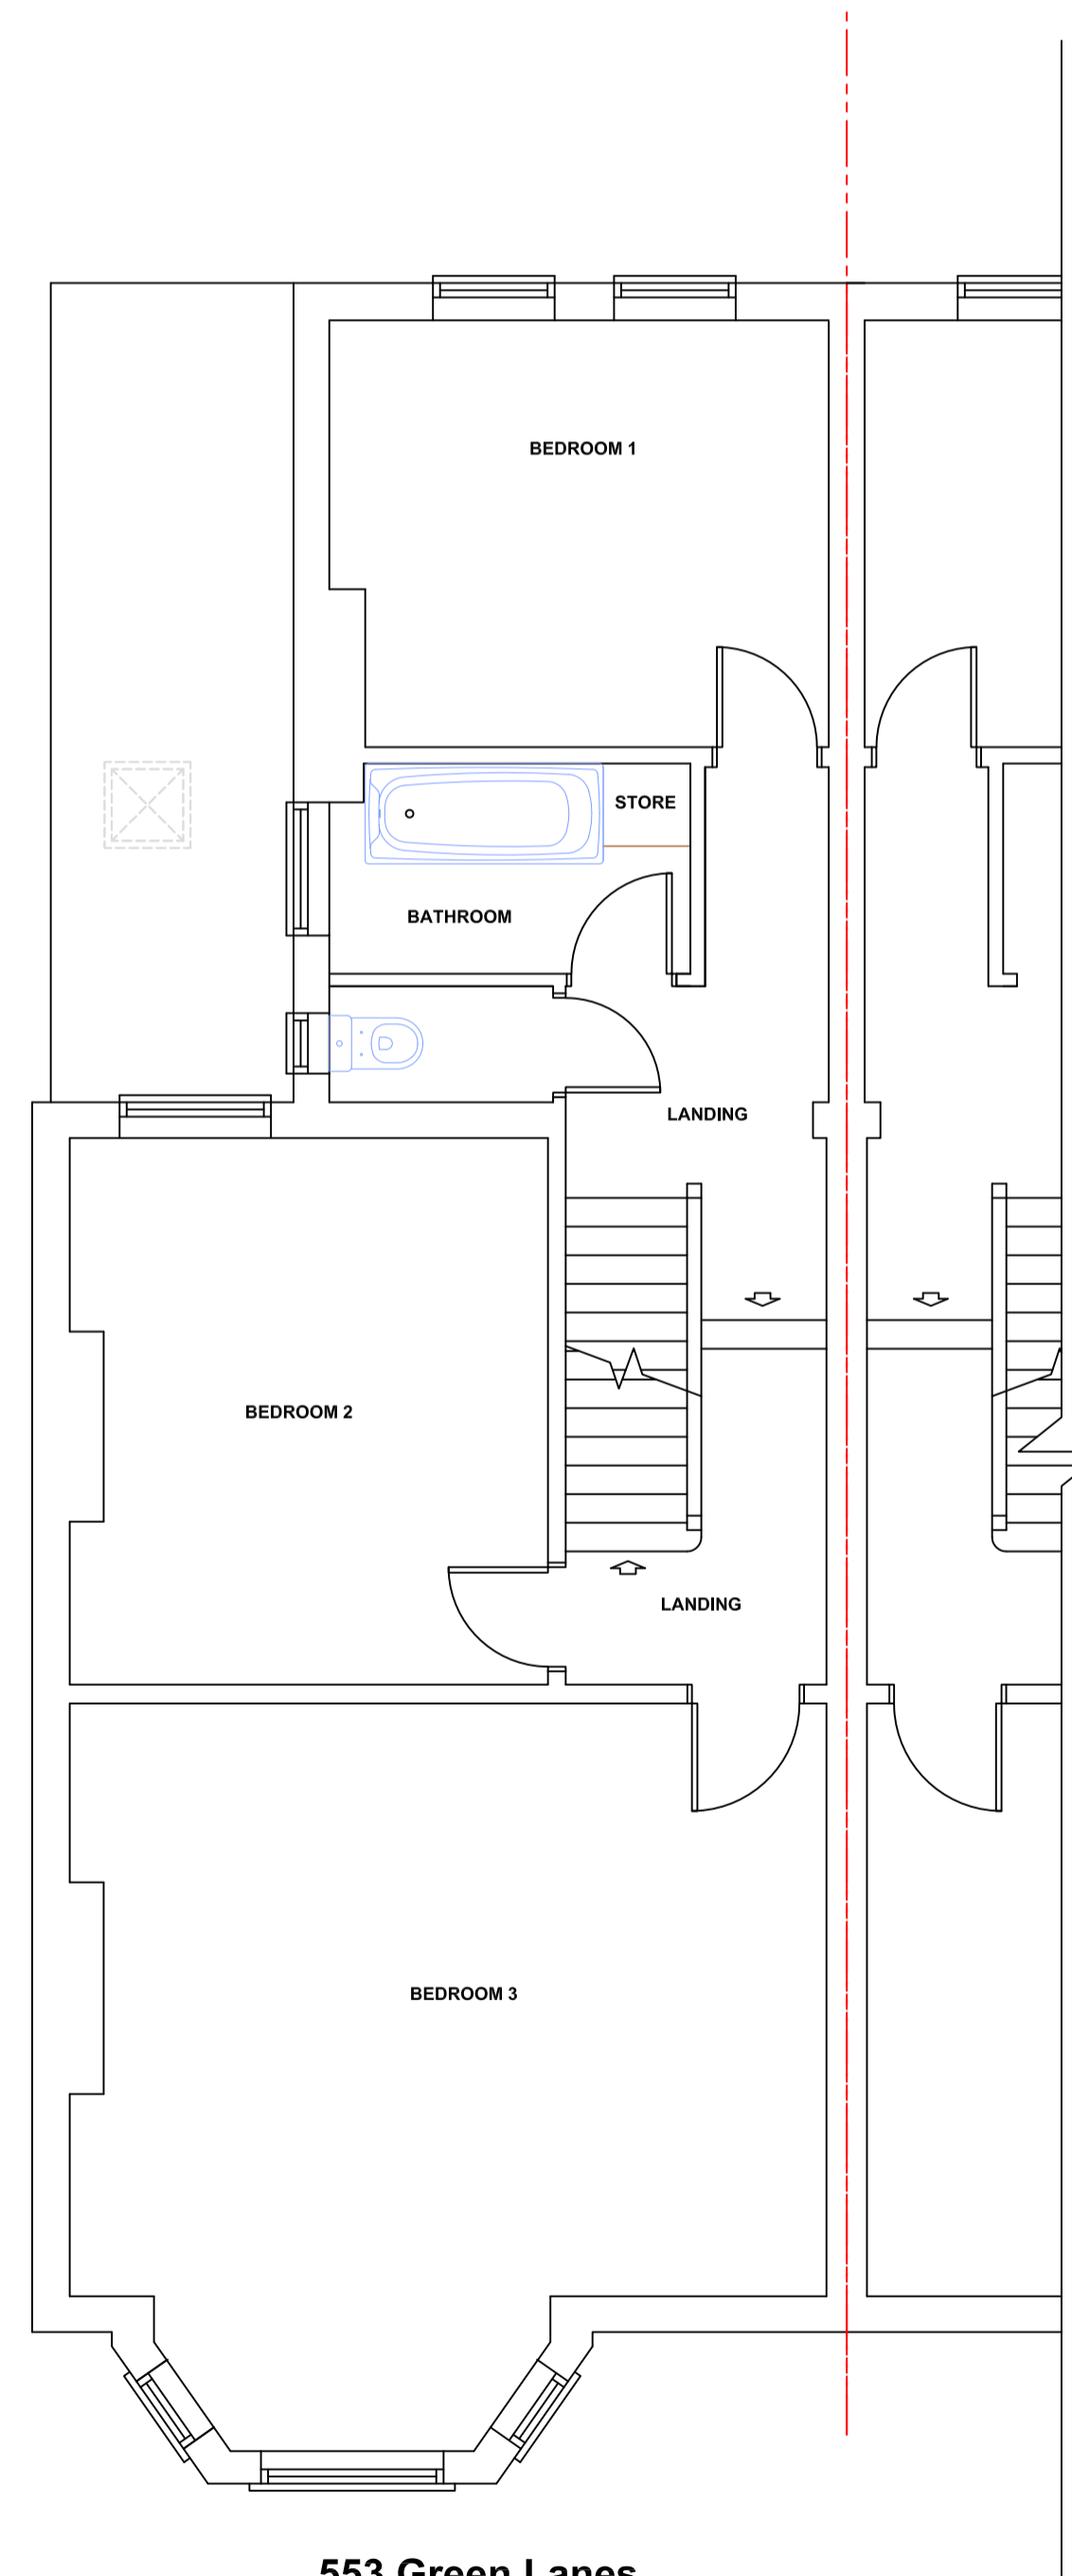


553 Green Lanes
PROPOSED FIRST FLOOR PLAN

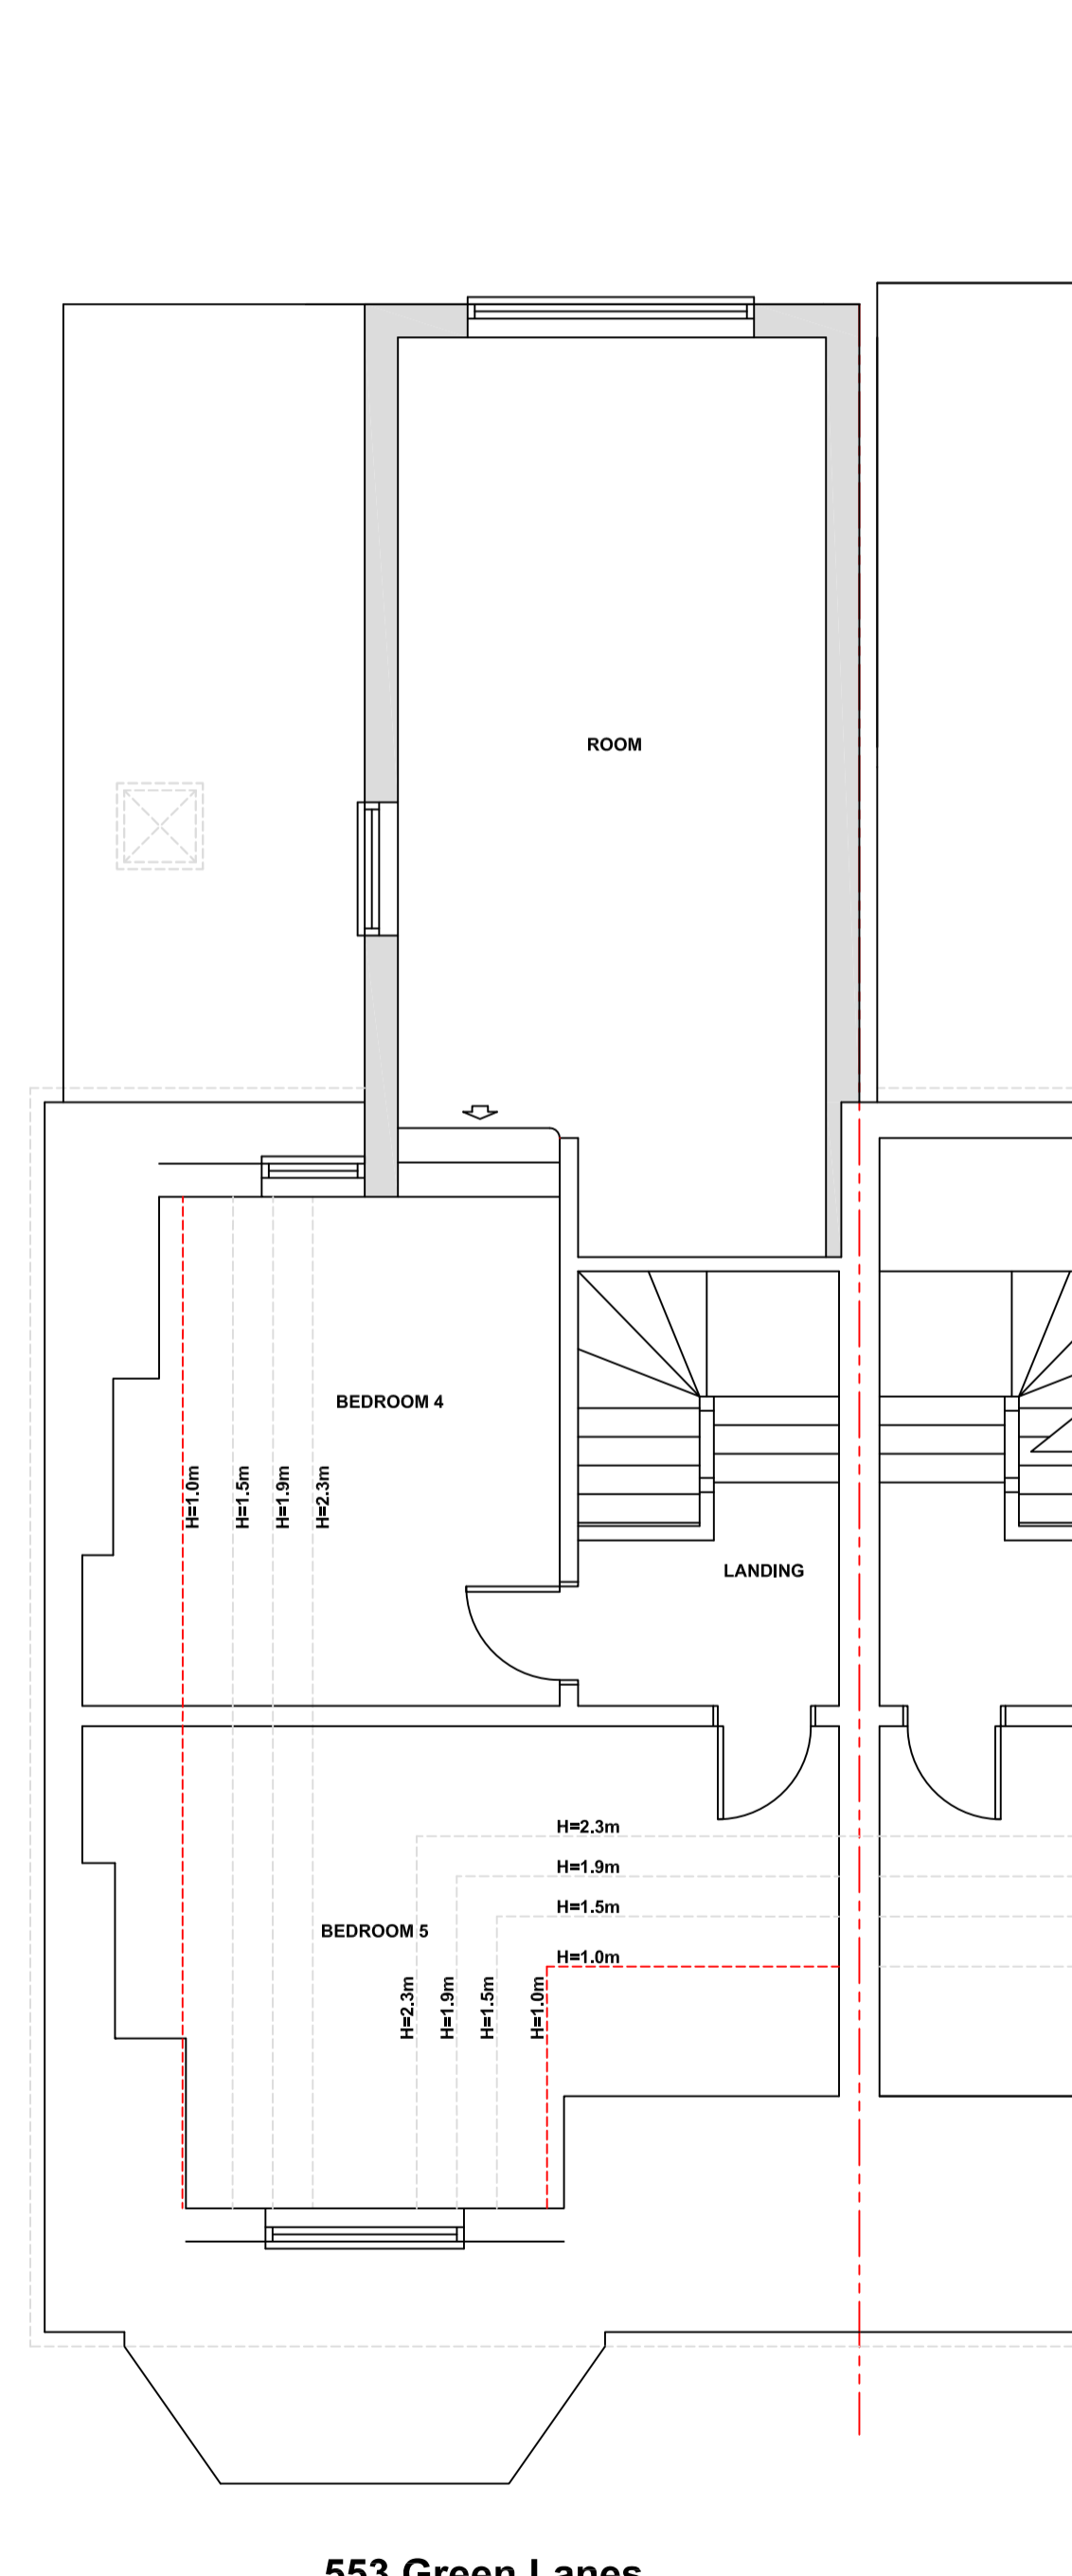

553 Green Lanes
PROPOSED SECOND FLOOR PLAN

ROOF VOLUME CALCULATION:
 $7.19m^2 \times 6.00m = 43.14m^3$
 $5.54m^2 \times 2.66m = 14.74m^3$
 $1.36m^2 \times 2.66m / 3 = 1.21m^3$
 $2.68m^2 \times 2.81m = 7.53m^3$
 $14.74m^3 - 1.21m^3 - 7.53m^3 = 6.00m^3$
TOTAL ROOF VOLUME:
 $43.14m^3 + 6.00m^3 = 49.14m^3$

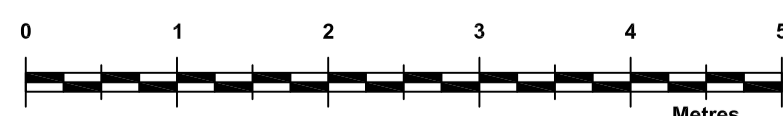

Revision	Description	Date

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 (020) 8441 4947
 13 Evelyn Road, Cockfosters, Hertfordshire EN4 9JT
 e-mail: martin@tcppltd.net

Project _____
 553 Green Lanes
 LONDON
 N13 4DR
 Ground Floor Rear Extension

Client _____
 Mr D.Moore

Proposed Plans & Elevations

Drawing No. _____
 2021/1461/5

Scale 1:50, 1:100 Drawn By: M.P.M

Sheet Size A1 Date 12 Feb 2024

IMPORTANT NOTICE
 © Copyright. Drawing to be used in conjunction with specification and structural engineers notes. All dimensions to be checked on site prior to commencement of work, differences between drawings, and between drawings and specification or structural engineers details to be referred immediately to Town and Country Planning Ltd. Work should only be undertaken from local authority approved drawings. Commencement of any work on site prior to gaining the necessary planning and or building control approvals is entirely at the client's own risk. We strongly recommend you agree the boundary lines of the property before any work commences on site it is the responsibility of the builder and the property owner to be in agreement with the definition of these lines.