

VOLUME CALCULATION


Volume of Dormer =1/2 (L x H x W)

=1/2 ((4.4 x 2.4 x 3)+(3.3 x 2.7 x 5) = 38.11 m^3


Total Volume = 38.11 m³ < Allowable Volume 40 m³

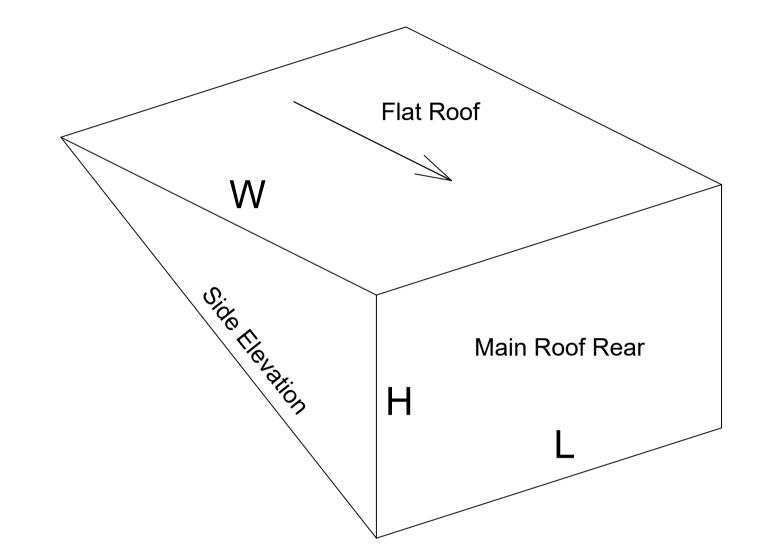

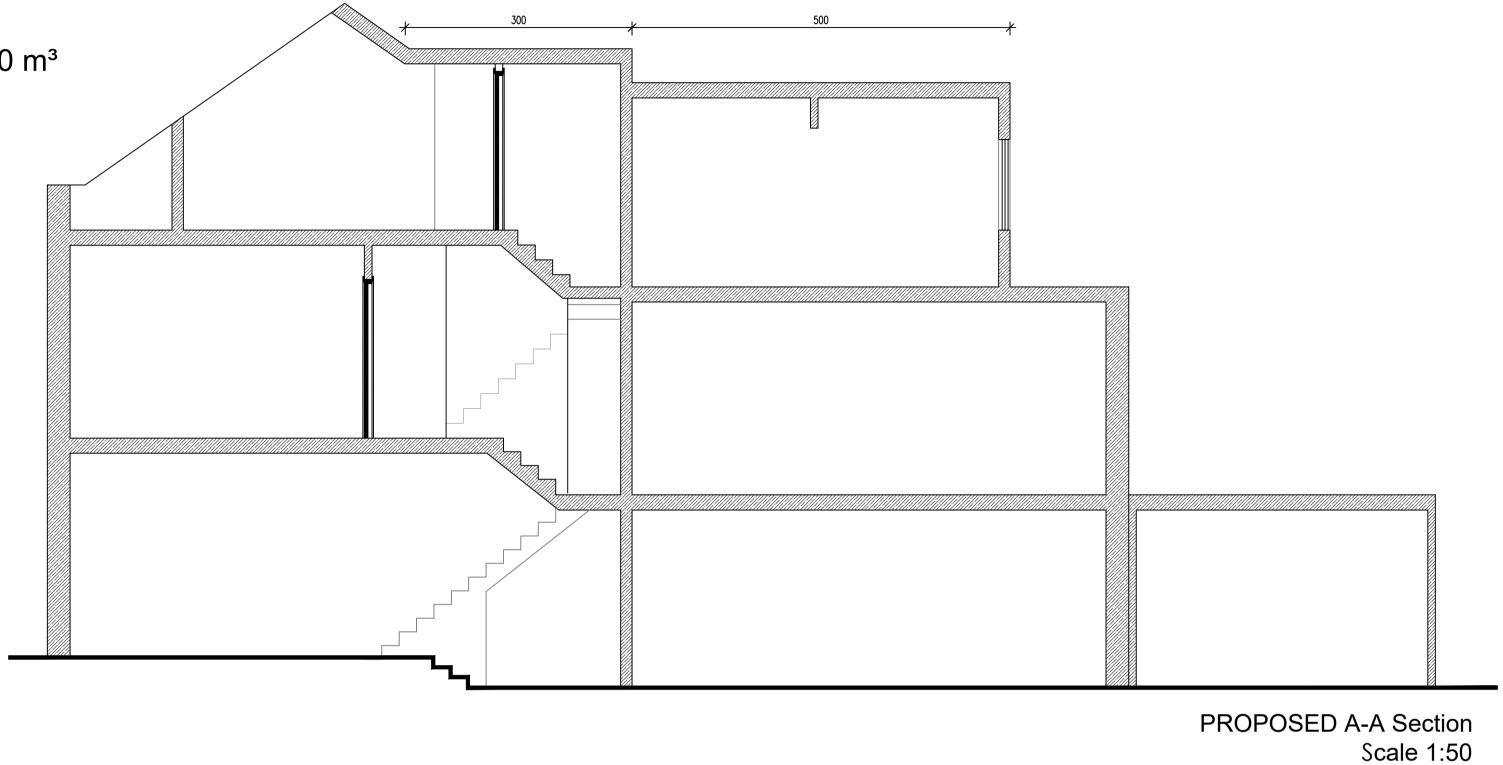

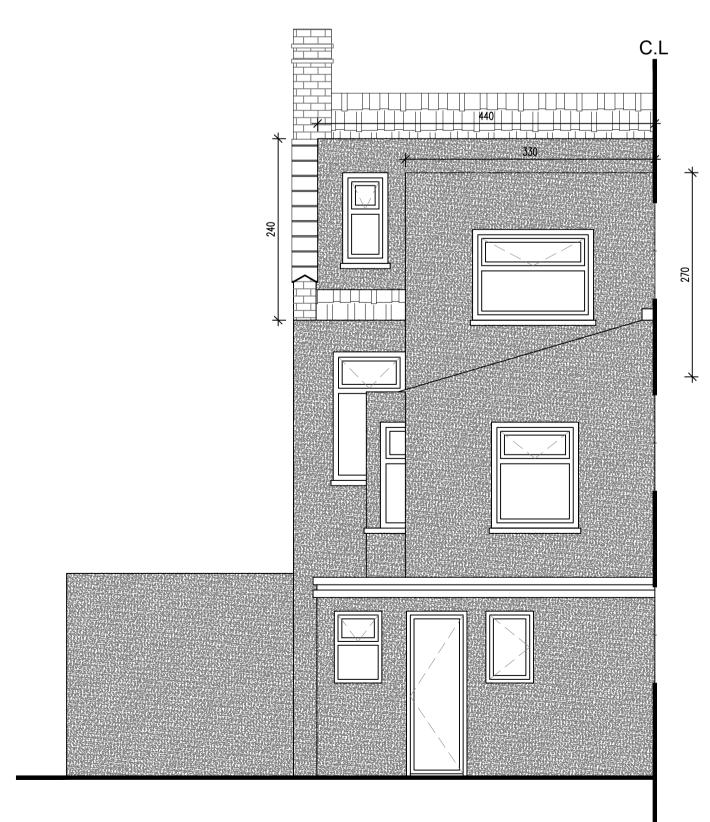

PROPOSED REAR ELEVATION Scale 1:50

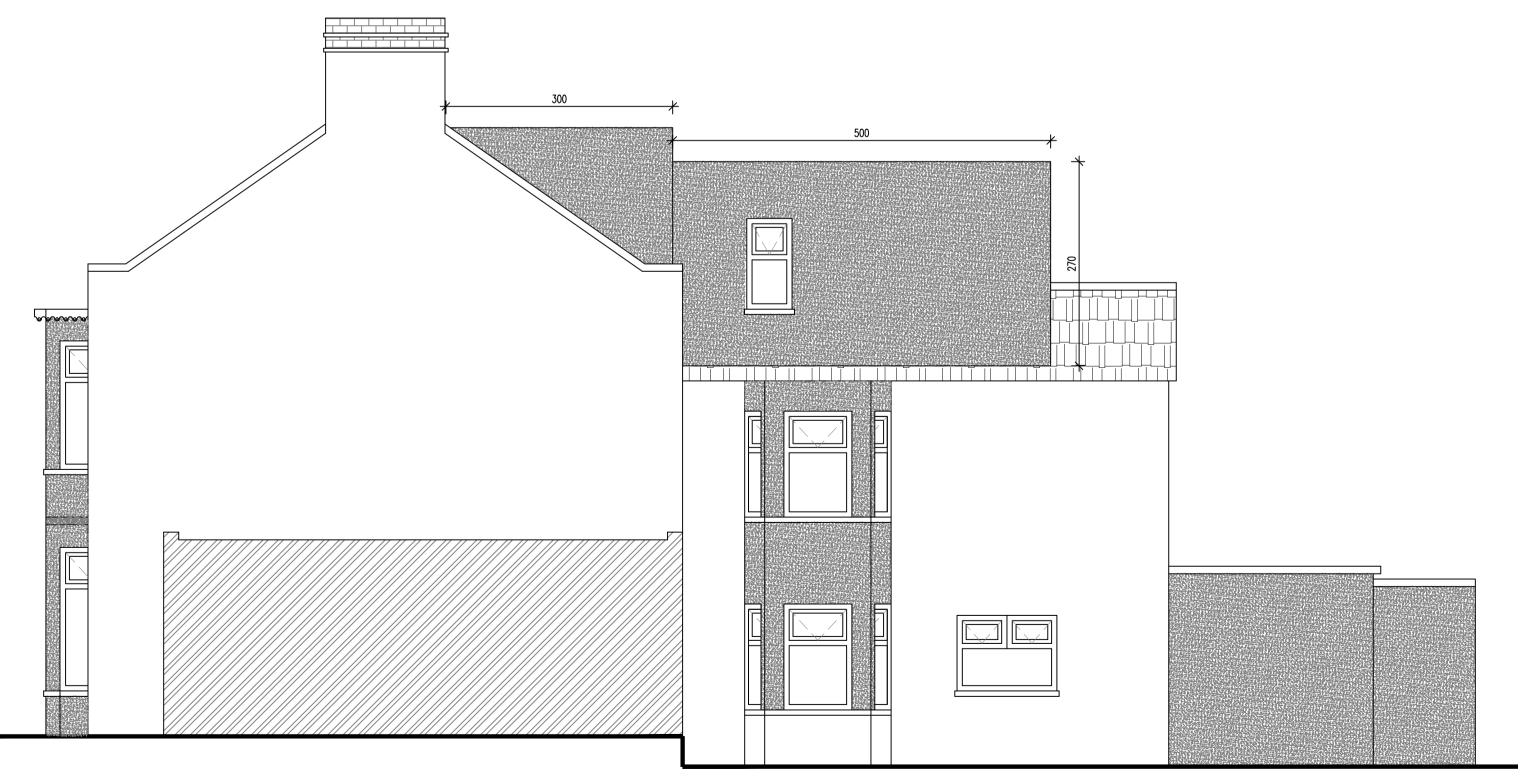

PROPOSED SIDE ELEVATION Scale 1:50

REV DATE DESCRIPTION

All dimensions and levels to be checked on site by contractor prior to preparation of shop drawings and commencement of work on site.

All dimensions are in centimetres unless stated otherwise.

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This drawing is to be read in conjunction with all relevant consultants' and/or specialists' drawings/documents and any discrepancies or variations are to be notified to the Designer before the affected work commences.

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Drawing title:

Proposed Volume Calculation

Scale:		Status:	
1/50 - A1			
Drawn by:		Date:	
G.MALKOC		FEBRUARY 2024	
Project no:	Drawing	l 1 no:	Revision:
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UZZ4/DUSK		U1	