
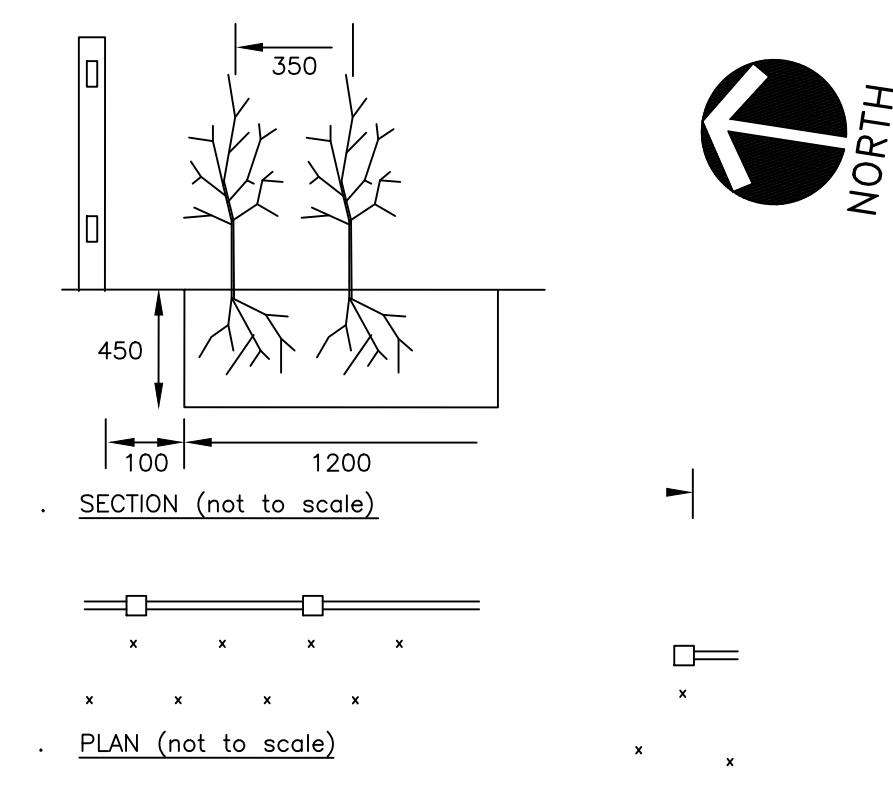


**NOTES:**  
 See Tree Protection and Report for details of Tree Protection  
 Planting Hedge and Trees  
 Soil depth- minimum required per area.  
 450mm topsoil for beds.  
 600mm topsoil for tree planting areas.  
 150mm depth for lawn areas.  
 Allow for 15m³ of soil volume for each small tree.  
 Tree Planting  
 Please see detail on Plan  
 Planting in Existing Hedge (site periphery).  
 Existing hedgerow to be protected and maintained.  
 Where planting in existing hedge use Silt Planting Method.  
 Press spade all the way into ground, then push it forward, to create a slit.  
 Keep the slit open with the spade in, place the plant into the slit, making sure that the plant is planted at the same depth as it was before being lifted.  
 Make sure the roots are in the slit and that the slit is deep enough.  
 Remove the spade, and use your foot to close the soil around the tree.  
 Tree guards should also be installed as follows:  
 All standard trees will have slimmer guards installed, with spiral rabbit guards.  
 All hedging plants will be protected by a rabbit guard/rub.  
 Tree and hedgerow planting implementation.  
 Plant between the end of November to the beginning of March, using bare root 1-1, or 1-2 transplants, during the first planting season after completion. The hedgerows and tree areas should have a weed free area of 1m² around the base of each standard tree, and a weed free strip along the hedgerows, to enable good establishment of the plants. Mulch using a 60mm deep layer of well rotted soil/ improver recycled green waste, to be approved by Landscape architect.  
 The existing hedgerow maintenance-trim hedgerow between the end of January and the beginning of March checking first that there are no nesting birds.

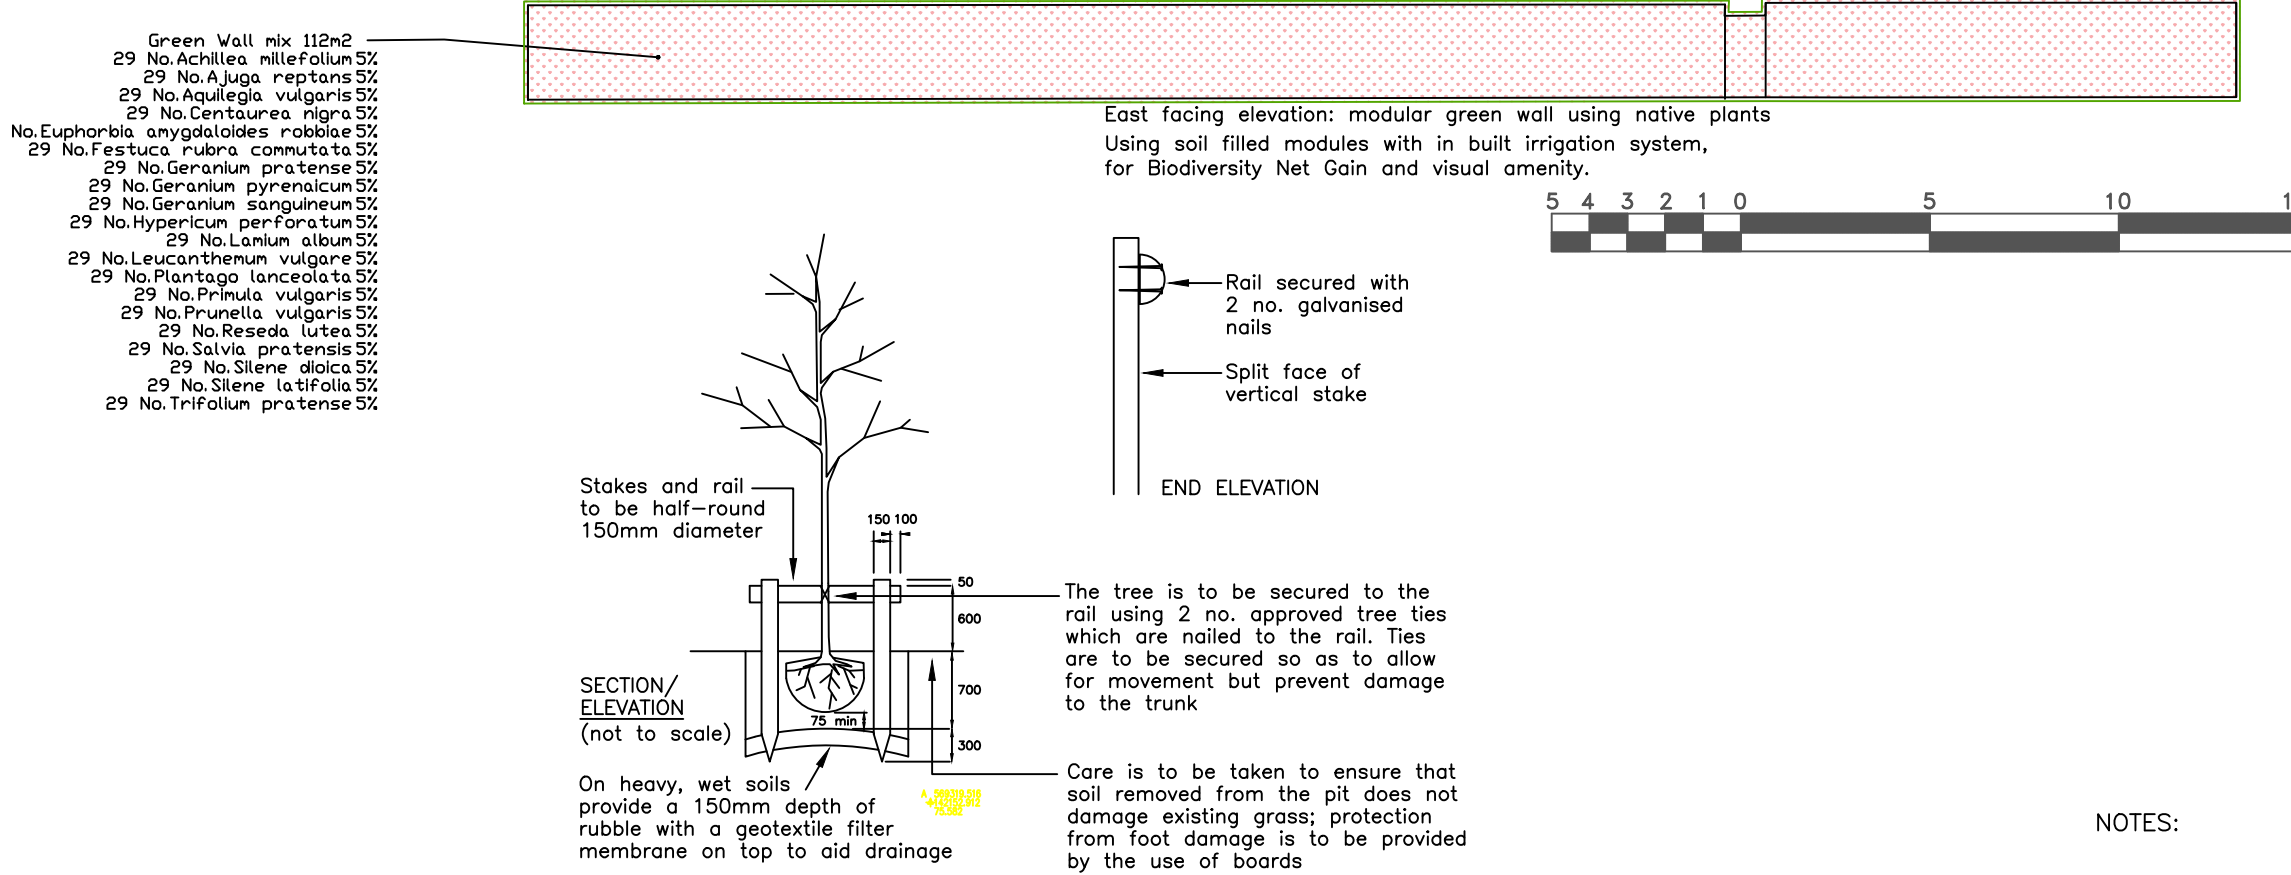

**Planting Schedule**

Trees	Number	Species	Girth	Height	Pot Size	Specification
84	-	Acer campestre	50-60cm	1.1-1.2m	H+1	OG
47	-	Carpinus betulus	50-60cm	1.1-1.2m	H+1	OG
70	-	Crataegus monogyna	40-60cm	1.1-1.2m	H+1	OG
52	-	Fagus sylvatica	40-60cm	1.1-1.2m	H+1	Transplant OG
3	-	Prunus avium	12-14cm	3.0-3.5m	Standard	Clear Stem 150-175 2x RB or CG
1	-	Malus 'Royalty'	8-8cm	1.8-2.0m	Standard	2x RB or CG
1	-	Malus 'Golden Hornet'	8-8cm	1.8-2.0m	Standard	2x RB or CG
3	-	Betula pendula	10-12cm	2.5-3.0m	Standard	Clear Stem 150-175 3x RB or CG
2	-	Quercus robur	4-6cm	2.0-2.5m	Weather TX	RB or CG
1	-	Crataegus monogyna	8-8cm	1.2-2.0m	Standard	2x RB
1	-	Tilia cordata	12-14cm	3.0-3.5m	Selected Standard	2x RB or CG

Shrubs	Number	Species	Pot Size	Height	Specification
8	-	Corylus avellana	H	40-50cm	H+1 OG
105	-	Ligustrum vulgare	80-80cm	H+1	OG
10	-	Prunus spinosa	40-60cm	H+1	OG
30	-	Euonymus fortunei 'Emerald 'n' Gold'	20-30cm	H+1	Whip

Wildflowers	Number	Species	Specification	Pot Size	Density
88	-	Achillea millefolium			
88	-	Ajuga reptans			0.5
88	-	Anulugia vulgaris			0.5
88	-	Centiurea nigra			0.5
88	-	Euphorbia amygdaloides robbiae			0.5
88	-	Festuca rubra commutata			0.5
88	-	Geranium pratense			0.5
88	-	Geranium pyrenaicum			0.5
88	-	Geranium sanguineum			0.5
88	-	Hypericum perforatum			0.5
88	-	Lamium album			0.5
88	-	Leucanthemum vulgare			0.5
88	-	Plantago lanceolata			0.5
88	-	Primula vulgaris			0.5
88	-	Prunella vulgaris			0.5
88	-	Reseda lutea			0.5
88	-	Salvia pratensis			0.5
88	-	Silene dioica			0.5
88	-	Silene latifolia			0.5
88	-	Tribulum pratense			0.5

- NOTES:**
- The hedge planting is to be carried out in a single trench dug 1200mm wide, 450mm deep and to the required length.
  - Mix the dug soil with a) a slow release fertiliser, b) a screened green waste soil ameliorant.
  - Break up the soil in the base of the trench(es).
  - Prepare the plants: a) prune back any damaged roots to healthy growth; b) place roots of waiting plants in water whilst planting; c) apply Broadleaf Root dip or similar.
  - Place the plants in the trench in a double staggered row, 350mm between the rows, 500mm between the plants in each row, as shown.
  - Backfill the trench to half its depth and firm by treading. Continue planting the trench.
  - Once planted, backfill with the remaining soil and firm as before.
  - Topdress the planting area with a 50mm depth of bark mulch.
  - In March cut the plants hard back to within 250mm of the ground to encourage bushy growth from the base.

HEDGE PLANTING: DOUBLE ROW  
 Title: \_\_\_\_\_  
 Scale: NTS  
 Ref: DET009.DWG

- Log Piles 800mm high
- Hedgehog Hole 130mm in fence at ground level
- Schweger 35 Starling nest box
- 2x 15P Schweger Sparrow Terrace North elevation only or similar nesting box 2-4 m high under eaves
- Hedgehog hole 100 on South Elevation min 3m high
- Proposed Green Wall
- Proposed Wildflower meadow
- Proposed Planting
- Proposed new tree
- New mixed native hedge

**Site**  
 29a and 29b Beech Hill  
 Hadley Wood,  
 EN4 0JN

**Client**  
 P. Tsoukka

**Drawn By**  
 Ian Noel

**Drawing name**  
 BNG and Landscape Plan

**Drawing number**  
 BEE/ENF/023/010 Rev1

**Checked By**  
 CN

**Scale**  
 1:200 @A1

**Date**  
 Oct 2023

**Landvision**  
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