	Layer Thickness (mı			kness (r	mm)	Material Description	Specification
Carriageway	Surface Course	1	50			HRA Surface Course (clause 910)	PD6691 Annex C BS EN 13108-4 SCC Table 9.2
	Binder Course	2	60			HRA Binder Course (clause 905)	PD6691 Annex B BS EN 13108-4 SCC Table 9.2
	Base	3	100			32mm Dense base course with 40/60 pen bitumen. AC 32 dense base 40/60 des	BS 594987 to SHW CL 903
	Sub-Base	4	< 2.5% 350	CBR 2 - 5% 300	> 5% 270	Permitted Type 1 well compacted unbound granular sub-base aggregate.	SHW CL 803 CD 225 Revision 0 (Formerly IAN 73/06 revision 1 (2009))
	Capping	5	ТВС	ТВС	N/A	Class 6F1 or 6F2 capping material.	MCHW 613 - Table 6/1 & 6/4
	General Fill	6	As required to raise level to sub-base or capping layer as appropriate		pping	Class 1B or 1C general fill material	MCHW 613 - Table 6/1 & 6/4
Footway	Surface Course	7	2 x 25 (50)			2No. Layered Courses of HRA 15/10 Type F Surf 100/150 Pen bitumen	PD 6691 Clause C.2.5.1.1.
	Sub-Base	8	100 (150 in driveway access areas)			Permitted Type 1 sub-base aggregate. Formation to be treated with approved weed killer prior to laying sub-base.	SHW CL 803 BS EN 13108-5
	Concrete	9	See kerb details for thickness			Concrete bed and haunch Class ST2	

• If Imprinted Thermoplastics are used , approval from overseeing authoritory's laboratory is to be gained prior to installation. The

Foundation CBR Table								
CBR (%)	Subgrade Surface	Type 1 (mm) - Clause 803, 804, 806, 807	Sub-Base Depth (mm)	Capping Depth (mm)				
. ,	Modulus	(Sub-Base Only) (Figure 3.18) (Sub-Base and Capp		oing Layer) (Figure 3.2				
2.0	27.427	Ground Stabilisation Required - Seek Engineer Advice						
2.5	31.637	410	240	410				
3.0	35.553	370	230	375				
4.0	42.740	315	220	320				
5.0	49.301	270	200	250				
6.0	55.403	260	180	240				
7.0	61.147	250	165	225				
8.0	66.602	240	160	215				
9.0	71.817	230	150	205				
10.0	76.827	225	150	195				
11.0	81.659	220	150	185				
12.0	86.335	215	150	175				


• The SMA surface course shall achieve an initial texture depth of 0.8 to 1.6mm

material is to be installed to the manufacturers specifications


• Aggregate Abrasion value (AAV) should be no greater than 14 for surface course


• Washed 1 to 3mm crushed rock shall be immediately applied to the hot SMA surface


Scale 1:10

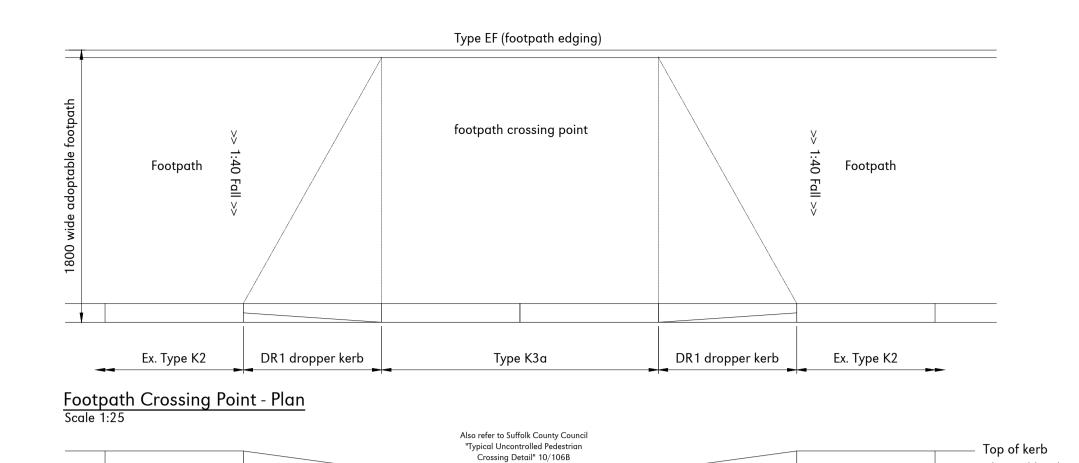

Footpath Crossing Point - Front Elevation
Scale 1:25

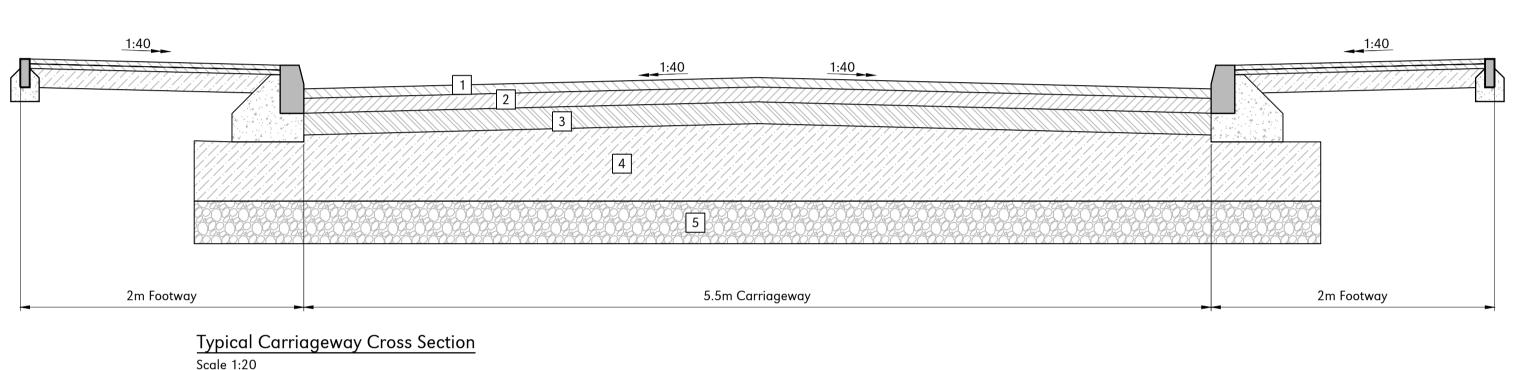


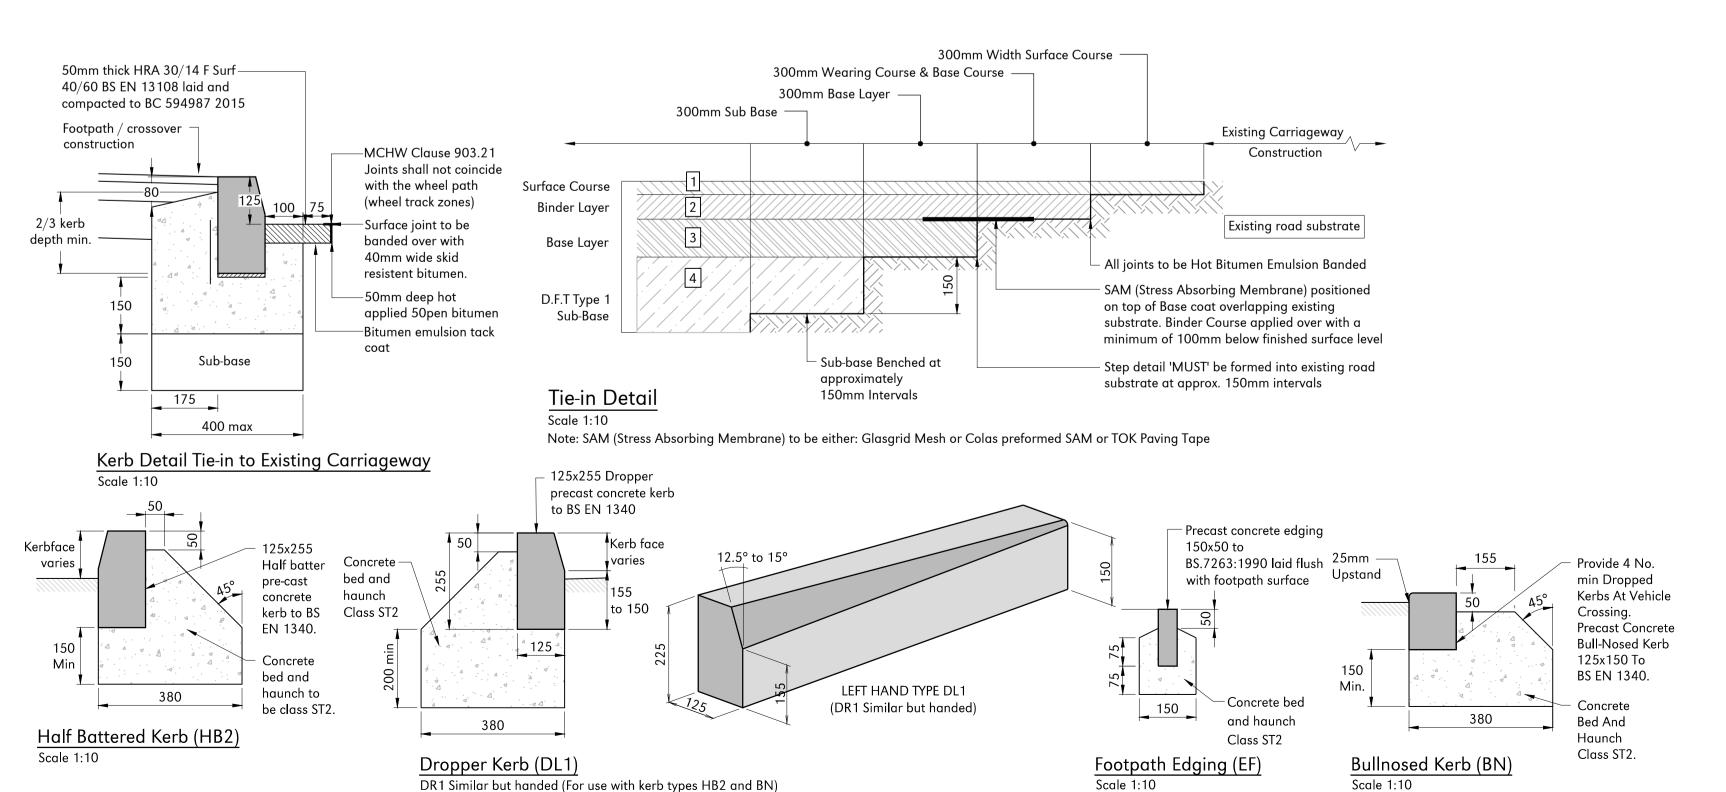

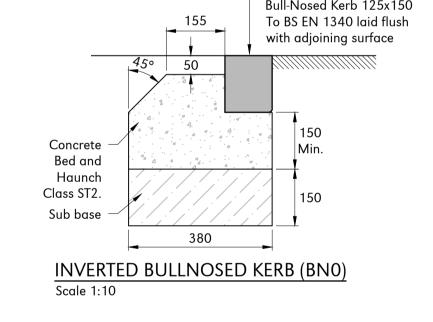

Inverted Precast Concrete

Channel level

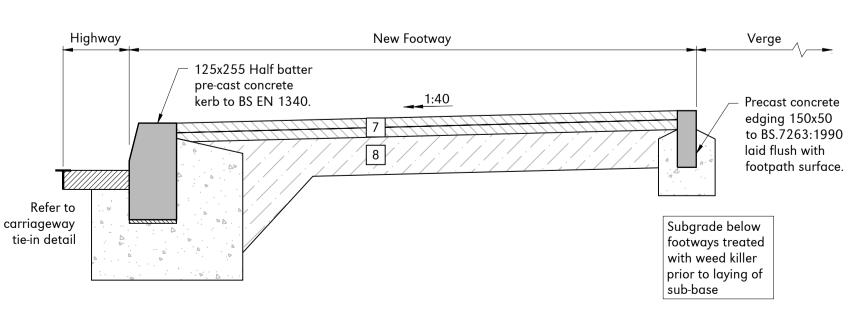

New Footway Construction Details

DRAWING TO BE READ IN CONJUNCTION WITH SUFFOLK COUNTY COUNCIL STANDARD DETAILS

- Kerbs as per 10/101B.
- Footway Construction as per 10/103B
- Tactile Paving as per 10/106B
- Trench and Bedding Details as per 7/101B
- Catchpits Detail as per 7/103B
- Access to Chambers as per 7/107
- Ramp Detail for Shared Surface road as per 10/105B

9. Until technical approval has been obtained from the relevant authorities it should be understood that all drawings issued are preliminary and not for construction. Should the contractor start

1. All dimensions noted are in metres unless stated otherwise.

for any third party uses of this document.

omissions or discrepancies.

22536/001, 002 & 003.

the manufacturer.

documents relating to the project.

contractor to suit their program.

2. Do not scale from this drawing, if dimensions are not clear ask.

3. This document has been created in accordance with Plandescil Ltd Terms & Conditions along with the scope of works provided by the client to Plandescil. Any use of this document other than

for its original purpose is prohibited, Plandescil accept no liability

Plandescil Ltd to be immediately notified of any suspected

5. This drawing is to be read in conjunction with all other relevant

6. All levels relate Plandescil Topographical Survey drawings

7. All proprietary materials to be fixed strictly in accordance with manufacturer's recommendations using materials approved by

8. Inspections by the Local Authority, shall be arranged by the


- site work prior to approval being given, it is entirely at their own risk.


 10. All existing drainage and highway tie-in details are to be
- 10. All existing drainage and highway tie-in details are to be confirmed on site prior to the commencement of the proposed works.
- 11. Road markings to be in accordance with TSRGD 2016, material to be Superimposed Thermoplastic to BS EN 1871 and BS EN 1436.
- 12. Specifications for the roadway construction is subject to CBR test details. These tests will need to be carried out prior to any road works starting.
 13. Executations close to trees/hedges to be carried out in accordance.
- 13. Excavations close to trees/hedges to be carried out in accordance with NJUG Guidelines Volume 4. In particular no roots over 25mm dia should be cut without consulting an arboriculturalist and any smaller roots that are damaged should be ct cleanly with sharp secateurs.
- 14. Any tree pruning should be carried out in accordance with BS 3998:2010 Tree Recommendations.

Works Requiring Inspection By The Highways Inspector

The Contractor shall give advance notice to Suffolk County Council to allow the Highways Inspector proper inspection and checking of the works at the following designated stages:

- Prior to the start of works a photographic record of the existing highway condition adjacent to the development is to be agreed and recorded.
 Start of the works
- 3. Before backfilling any trenches under new highway
- 4. Completion of formation
- 5. Completion of sub-base6. Arrival and planting of trees
- 7. Laying of base
- 8. Laying of binder course
- 9. Laying of surface course
- 10. All damage to existing highway resulting from construction traffic is to be repaired before the Inspector will recommend works for interim or adoption

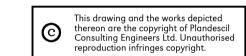

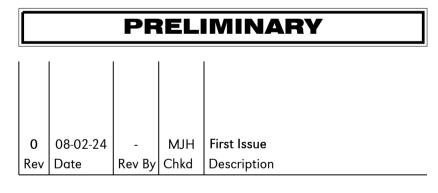



Connaught Road Attleborough Norfolk NR17 2BW Telephone: (01953) 452001 Fax: (01953) 456955 E-mail: pdc@plandescil.co.uk www.plandescil.co.uk

civil / structural / environmental / surveying

Client

Herin Property Investments LLF

Project

Willisham Hall Barns Willisham Hall Road Willisham, Ipswich, IP8 4SL

Drawing Title

Entrance Details

Scale U.N.O. Date Drawn By As Noted (A0) February 2024 CND

Drawing No. 29478/012 Rev 0