

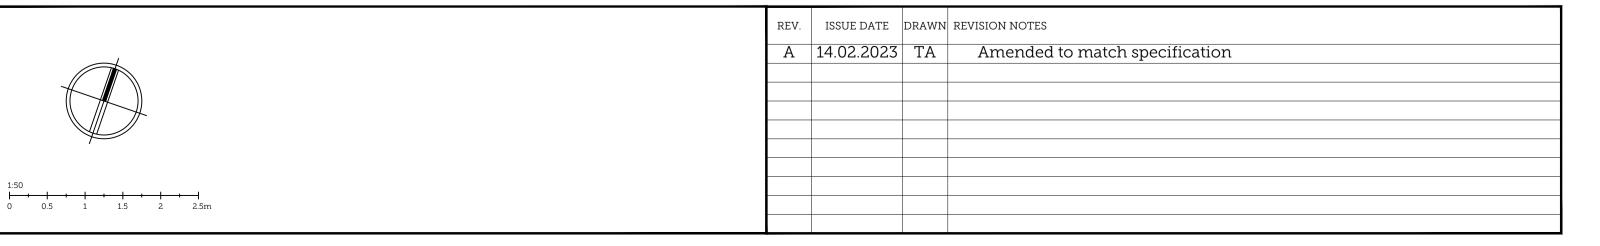
01 | PROPOSED ROOF PLAN

01 | PROPC Scale 1:50 @ A1

GENERAL NOTES

- 1. Do not scale from this drawing. All dimensions must be checked on site by the Contractor.
- 2. This drawing is to be read in conjunction with all construction information, including all relevant consultants' information. Any discrepancies must be reported to the Architect immediately.
- 3. All specified items are to be installed in accordance with their manufacturer's recommendations.
- 4. This drawings is copyright of Scorer Hawkins Architects 2022.

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15.00 ELECTRICAL SAFETY | PART P

15.01 All electrical installations to be tested upon completion by a niceic

registered electrician.

15.02 As-built electrical schematic plans to be provided upon completion

for inclusion within the building 'operation and maintenance manuals'

15.03 Electrical detailed design to be prepared by the main contractor for the architects approval.15.04 Allow for power supplies to be following kitchen appliances:

i) Fridge/freezerii) Electric ovensiii) Extractoriv) Electric hob (induction)v) Microwave oven

and room heatmiser thermostats.

vi) Washer/dryer

vii) Dishwasher

15.05 Allow for power supply and wiring to boilers, including programmer

15.06 Allow for power supply to external isolating switch to bathroom extract fans.

15.07 Allow for 1no. shaver socket to each bathroom.

15.08 All lighting to bathrooms above baths, shower and whb's to IP rated

15.09 Allow for wiring for terrestrial and cable television.

15.10 Allow for telephone wiring to hub point

15.11 100% of all lighting will incorporate a rated energy efficient luminaries.

16.00 SECURITY | PART Q

Any dwelling; andAny part of a building from which access can be gained to a flat

16.01 Reasonable provision must be made to resist unauthorised access to-

within the building

17.00 PHYSICAL INFRASTRUCTURE FOR HIGH SPEED ELECTRONIC COMMUNICATIONS NETWORKS | PART R

17.01 Building work must be carried so as to ensure that the building is equipped with a high-speed-ready in-building physical infrastructure, up to a network termination point for high-speed electronic communications

17.02 Where the work concerns a building containing more then one dwelling, the work must be carried out so as to ensure that the building is equipped in addition with a common access point for high-speed electronic communications networks.

18.00 INFRASTRUCTURE FOR THE CHARGING OF ELECTRONIC VEHICLES | PART S

18.01 A new residential building with associated parking must have access to electric vehicle charge points

18.02 The number of associated parking spaces which have access to electric vehicle charge points much be

The total number of associated parking spaces, where there are fewer associated parking spaces than there are dwellings contained

in the residential building; to

The number of associated parking spaces that is equal to the total number of dwellings contained in the residential building, where

there are the same number of associated parking spaces as, or more associated parking spaces than, there are dwellings

18.03 Cable routes for electric vehicle charge points must be installed in any associated parking spaces which do not have an electric vehicle

charge point where
- A new residential building has more than 10 associated parking

spaces; and
- There are more associated parking spaces than there are dwellings contained in the residential building

19.00 MATERIALS AND WORKMANSHIP | PART 7

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19.01 Building work shall be carried out:With adequate and proper materials which:

Are appropriate for the circumstances in which they are used
 Are adequately mixed or prepared, and

-- Are adequately mixed or prepared, and
-- Are applied, used or fixed so as adequately to perform the

functions for which they are designed; and
- In workmanlike manner

20.00 DOORS AND GLAZING

20.01 All windows to be double or triple glazed sealed units made up from minimum 4 mm planflux float clear glass with a 28mm black spacer sandwiched by 4mm planitherm float clear with an argon filled cavity, to achieve a minimum u-value of 1.6 to specialist glaziers details

20.02 All windows to be fitted with integrated overhead trickle ventilators.

20.05 Toughened glass is to be fitted to all doors and side panels between finished floor level and 1500mm above ffl. all windows between finished floor level and 800mm above ffl must also be toughened in accordance with part n and to the local authority's approval.

20.06 All opening lights and doors are to be fitted with ironmongery with integrated locks to the architects approval.

20.07 All opening lights are to be fitted with friction hinges, openable to allow external cleaning from inside.

20.08 All new external doors are to achieve a minimum u value of 1.8.

PROJECT TITLE: ALISONS, 2 - 6 LUMLEY ROAD, SKEGNESS DRAWING TITLE: PROPOSED ROOF PLAN Lodge Farm Barns Skendleby, Spilsby Lincolnshire, PE23 4QF 01754 890089 projects@scorerhawkins.co.uk www.scorerhawkins.co.uk