

33-47 Grovebury Court, London, N14 4JR

Transport Statement – Construction of 5 New Apartments

March 2024

TTP Consulting Ltd 111-113 Great Portland Street London W1W 600 Tel: 020 7100 0753

www.ttp-consulting.co.uk

Registered in England: 09931399



Contents

1	INTRODUCTION	1
2	THE EXISTING SITUATION	3
	The Site and Surrounding Area	
	Access on Foot	4
	Access by Bicycle	6
	Access by Public Transport	7
	Local Highway Network	8
	Parking Survey	9
3	POLICY	
	National Planning Policy Framework	
	The London Plan	
	Local Policy	
4	DEVELOPMENT PROPOSALS AND EFFECTS	
	Access Arrangements	
	Car Parking	
	Cycle Parking	
	Deliveries and Refuse Collection	
	Trip Generation	
5	SUMMARY AND CONCLUSION	
	Summary	
	Conclusion	

Figures

Figure 1.1	-	Location Plan
Figure 2.1	-	Existing Layout
Figure 2.2	-	Walking Isochrone
Figure 2.3	-	Cycle Isochrone
Figure 2.4	-	Local Bus Stops

Appendices

- Appendix A Application Plans
- Appendix B TfL Bus Spider Map
- Appendix C PTAL Report
- Appendix D Parking Survey Data



1 INTRODUCTION

- 1.1 TTP Consulting has been appointed to provide traffic and transport advice in relation to the proposed development at 33-47 Grovebury Court (the Site) which is located in the London Borough of Enfield (LBE).
- 1.2 The Site is located on the corner of Chase Road and Charter Way approximately 750m north of Southgate Underground Station as shown at **Figure 1.1.**



Figure 1.1: Site Location Plan

- 1.3 The Site comprises of a 3 storey building (ground plus 2) with landscaping in front and parking to the rear. There are currently a total of 15 one-bedroom apartments across the three floors.
- 1.4 In January 2023, an Appeal was allowed, and prior approval was granted for the provision of 5 additional flats in a single storey extension (21/04160/PRA). The Inspector stated that "*Notwithstanding the shortfall in available parking spaces, when measured against the maximum standard, I find that there would be sufficient on-street parking available to safely accommodate any increase in demand arising from 5 one-bedroom flats. It is therefore unlikely that the proposal would cause significant highway safety problems for vehicle users or pedestrians. Nor, taking into account the potential level and nature of vehicle movements, is it likely that there would be any materially adverse effect on the free flow of traffic."*
- 1.5 This report has been prepared to support an application to create an additional 5 apartments across one floor thereby increasing the overall number to 20 apartments, i.e. the same as currently permitted.




- 1.6 This report considers the effect of development in transport terms including accessibility, trip generation, car parking, cycle parking, deliveries and servicing. The remainder of the report is as follows:
 - Section 2 describes the existing situation;
 - Section 3 presents the proposed development and the potential effects; and,
 - Section 4 provides a summary and conclusion.



2 THE EXISTING SITUATION

The Site and Surrounding Area

2.1 The Site is situated within the cul-de-sac of Grovebury Court which is a private highway facilitating access to the Site and adjacent building.

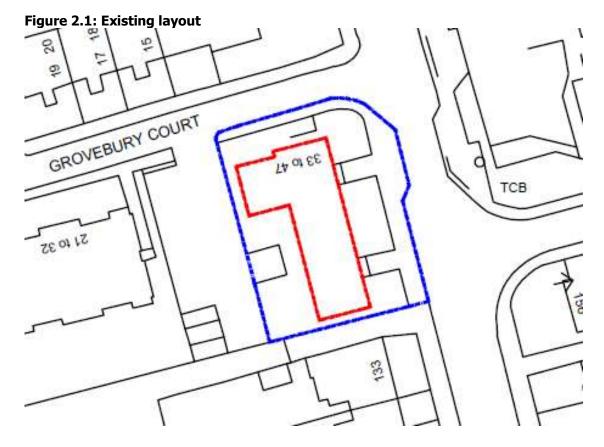

2.2 The Site is located within a predominantly residential area surrounded by residential properties to the north, south and west. The site is bound by Chase Road to the east which serves a mixture of residential and commercial developments, as well as Wolfson Hillel Primary School.



Access on Foot

- 2.3 Roughly half of all walking journeys in London are part of longer public transport journeys, for example walking to or from the bus stop or tube/train station, whilst a third of car journeys are within a 25-minute (2km) walk, suggesting there are real opportunities for active modes. Walking is considered to be an acceptable mode of transport to replace car and public transport journeys up to 2km in length with factors such as health, weather, facilities along with access to a ca and journey purpose all influencing a person's choice to walk.
- 2.4 There are footways provided on both sides of Chase Road which provide connections to the wider pedestrian network that serve public transport facilities and amenities.
- 2.5 **Figure 2.2** provides details of an 800m (10-minute) and 2km (25-minute) catchment zone surrounding the Site. Within a 20-minute walking distance the site benefits from access to destinations such as Arnos Grove, Osidge, Oakwood and Grovelands Park.



Figure 2.2: 800m and 2km Walking Isochrone



- 2.6 The Site is within an acceptable walking distance from a range of local amenities in the form of retail facilities, schools and local amenities.
 - **Table 2.1** shows approximate distances between the Site and nearby public transport stops. This illustrates that there are a number of public transport facilities within a short walking distance given an assumed average walking speed of 80 metres per minute.
 - **Table 2.2** sets out the approximate distances and walk times to local facilities and amenities which includes a school, banks, a post office, convenience stores and cafes

Stop / Station	Location	Distance	Approximate Walk Time*				
Bus Stops							
Charter Way	Chase Road	80m	1 minute				
West Grove Primary School	Chase Road	350m	4 minutes				
Southgate	Chase Road	810m	10 minutes				
Stations							
Southgate	Chase Side	800m	10 minutes				
*Based on a walking speed of 80 metres per minute							

Amenity	Location	Distance	Approximate Walk Time*
Wolfson Hillel Primary School	Chase Road	80m	1 minute
Gym	Winchmore Hill Road	750m	10 minutes
Asda	Chase Road	900m	11 minutes
Post Office	Chase Road	900m	11 minutes
Southgate Leisure Centre	Winchmore Hill Road	900m	12 minutes
Library	High Street	1km	12 minutes
Oakwood Park	Oakwood Park	1.1km	15 minutes
*Based on 80m per minute			


1



Access by Bicycle

2.7

It is generally accepted that cycling is a sustainable mode of travel for journeys up to 8km in length, although in London, longer journeys are more commonplace. **Figure 2.3** shows a 5km and 8km cycling catchment from the site. The map shows that a number of residential areas are within a 5km cycle of the site including Southgate, Barnet, Enfield and Frien Barnet. Additionally, Edmonton, Wood Green, Tottenham, Hornsey and Finchley are within an 8km cycle of the site.

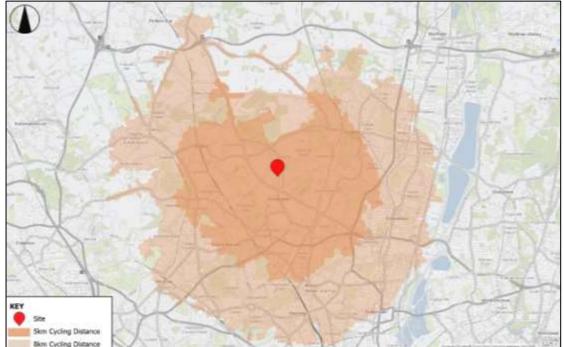



- 2.8 The Site benefits from being in proximity to a number of TfL cycle routes which facilitate access to areas such as Enfield and Edmonton. Cycle Superhighway 8 can be accessed via the High Street approximately a 7-minute cycle south of the Site.
- 2.9 TfL's Journey Planner tool allows for cycle route planning dependent on the difficulty of the route, being fast, moderate, or easy. From the Site the following destinations can be reached within various journey times:
 - Enfield (5.5km) 15min / 20min / 27min.
 - Tottenham (7.4km) 21min / 27min / 36min.
 - Finchley (9.7km) 25min/ 36min/ 50min.



Access by Public Transport

Bus Services

2.10 The Site is well served by buses with the nearest bus stops located to the northeast on Chase Road (Charter Way Bus Stops); both northbound and southbound bus stops are located within a minute's walk of the Site. A summary of the services available from the bus stops available within walking distance of the site is shown in **Table 2.3.** The relevant TfL bus route map is included at **Appendix B** and a plan showing stops is shown in **Figure 2.4**.



Figure 2.4: Map of Local Bus Stops

Table 2.3: Summary of Local Bus Services							
Bus Stop	No.	Route	Frequency (every 'x' minutes)				
Bus Stop	NO.	Route	Mon-Fri	Saturday	Sunday		
Chase Road	Turnnike Lane Station		9 – 10	13 – 14			
Chase Rodu	N91	Cockfosters Station - Whitehall / Trafalgar Square	30	30	30		
	299	Queens Avenue / Cockfosters Station	13 – 14	14 – 20	30		
Southgate		Station Road - Colindale Station	10 – 14	10 – 13	16 – 20		
(Stop G & H)	298	Arnos Grove Station - Potters Bar Station	20	20	30		
	382	Southgate Station - Millbrook Park	20	20	30		



Underground/Rail Services

2.11 Southgate station is located 750m (10-minute walk) south of the Site and offers a Piccadilly Line service between Uxbridge, Heathrow and Cockfosters with approximately 24 trains per hour operating in both directions. The Piccadilly line also offers a night tube service between Heathrow Terminal 5 and Cockfosters with a service operating every 10 minutes.

Public Transport Accessibility Level

- 2.12 Public Transport Accessibility Levels (PTAL) are a theoretical measure of the accessibility of a given point to the public transport network, considering walk access time and service availability. The method is essentially a way of measuring the density of the public transport network at a given point, up to 960m from the site.
- 2.13 The PTAL is categorised in six levels, 1 to 6, where 6 represents a high level of accessibility and 1 a low level of accessibility. The TfL output identifies that the Site has a PTAL rating of 3, demonstrating that it has moderate levels of accessibility to public transport. The PTAL report is included at **Appendix C.**

Local Highway Network

- 2.14 Grovebury Court which is a private highway runs in a broadly east to west orientation joining with Chase Road in the east and is a no through road to the west. Grovebury Court offers two-way traffic flow subject to a shared single carriageway. Additionally, the carriageway along Grovebury Court is shared with on-street residential parking which reduces the effective width of the carriageway.
- 2.15 Chase Road operates in a broadly north to south orientation joining with the A110 Bramley Road in the north and Winchmore Hill Road in the south. Chase Road offers two-way traffic flow operating on single carriageways in both directions and is a regular bus route. The highway network serves a mostly residential community with some commercial developments and is subject to a speed limit of 30mph. Both sides of the carriageway accommodate on-street residential parking at intermittent locations.



Parking Survey

- 2.16 The parking surveys undertaken in September 2021 with the previous application / appeal revealed a total of 70 spaces available with 200m of the Site.
- 2.17 Updated parking surveys have been undertaken to support this application; a Lambeth Methodology parking survey was undertaken at 0200 on Friday 1st December and again at 0445 on Tuesday 5th December 2023 to cover a the area within approximately 200m distance of the Site.
- 2.18 The survey identified a total of 118 on-street parking opportunities excluding along Grovebury Court, with 83 cars (70%) parked on the 1st December 2023 and 81 cars (69%) parked on the 5th December 2023; the survey picked up 1 car parked on double yellow lines and 2 cars across dropped kerbs on the 1st December. Generally there was good availability in the unrestricted areas. The survey identified parking for approximately 39 cars along Grovebury Court with 30 cars parked on the 1st and 27 cars parked on the 5th December; the numbers include 10 space on the Site, with 7 cars parked on the 1st and 5 cars on the 5th December 2023.
- 2.19 **Table 2.4** provides a summary of the survey with the full parking survey data provided at **Appendix D** for reference.

Table 2	Table 2.4: Summary of December 2023 Parking Surveys					
		1 st De	c 2023	5 th De	c 2023	
		(02	200)	(04	45)	
		Occ.	Free	Occ.	Free	
	Disabled	1	0	1	0	
	Double Yellow Lines	1	-	-	-	
ىد	Dropped Kerbs	2	-	0	-	
ee	Lay-By	0	3	0	3	
On-Street	Nose in Parking	8	1	8	1	
-hC	Off Road Parking Bays	12	5	12	5	
0	Unrestricted	59	29	58	30	
	Total	83	38	81	40	
>	Grovebury Court	15	6	15	6	
n L L	21 – 32 Parking Court	8	0	7	1	
ovebu Court	33 – 47 Parking Court	7	3	5	5	
Grovebury Court	Total	30	9	27	12	



3 POLICY

National Planning Policy Framework

- 3.1 The National Planning Policy Framework (NPPF) sets out the Government's planning policies for England and how these are expected to be applied.
- 3.2 When considering the transport effects of a development, NPPF states at paragraph 117 that:

"All developments that will generate significant amounts of movement should be required to provide a travel plan, and the application should be supported by a transport statement or transport assessment so that the likely impacts of the proposal can be assessed."

3.3 Paragraph 115 advises that:

"Development should only be prevented or refused on highways grounds if there would be an unacceptable impact on highway safety, or the residual cumulative impacts on the road network would be severe."

The London Plan

- 3.4 The London Plan was published in March 2021 and is the Spatial Development Strategy which forms the overall strategic plan for London. It sets out an integrated economic, environmental, transport and social framework for the development of London over the next 20-25 years.
- 3.5 Policy T1' Strategic approach to transport', states that:
 - A. "Development Plans should support, and development proposals should facilitate:
 - 1) The Delivery of the Mayor's strategic target of 80% of all trips in London to be made by foot, cycle or public transport by 2041.
- 3.6 Policy T5 'Cycling' describes that development proposals should help remove barriers to cycling and create a healthy environment in which people choose to cycle by supporting the delivery of London-wide cycle networks and secure cycle parking should be provided.

Table 10.2 of the London Plan summarises the minimum cycle standards for different land uses.

Table 3.1: Minimum Cycle Parking Standards					
Use Class	Long-stay	Short-stay			
Residential Use (all dwellings)	1 space per studio or 1 person 1 bedroom dwelling; 1.5 spaces per 2-person 1 bedroom dwelling; 2 spaces per all other dwellings	5 to 40 dwellings: 2 spaces Thereafter: 1 space per 40 dwellings			

٦



- 3.7 Policy T6 'Car Parking' outlines that car parking should be restricted to existing and future public transport accessibility and connectivity levels. Moreover, car-free development should be the starting point for all development proposals in places that are (or planned to be) well-connected by public transport, and car parking should follow the maximum standards set out in Policy 6.1 and Policy 6.5 relating to residential and disabled parking, respectively.
- 3.8 Policy T6.1 'Residential Parking' outlines that new residential developments should not exceed the maximum parking standards set out in Table 10.3, which states that residential developments of PTAL 5 – 6 should be car free.

Local Policy

The Enfield Plan Core Strategy 2010 – 2025

- 3.9 The Enfield Local Plan Core Strategy sets out a spatial planning framework for the long-term development of the Borough. It provides a broad strategy for the scale and distribution of development and the provision of supporting infrastructure to ensure development is sustainable.
- 3.10 Paragraph 7.45 in relation to the council's policies on Transport states that "*The underlying* approach is to ensure that travel choices across the Borough are enhanced so as to provide everyone with the opportunity to decide how they choose to travel, be that by car, public transport or walking and cycling."
- 3.11 Paragraph 7.46 notes that the Core Strategy seeks to address a number of key transport issues including "*The need for good access to the strategic road network to support the needs of business and industry away from residential neighbourhoods*"
- 3.12 Core Policy 25 Pedestrians and Cyclists states that the council will seek to provide safe, convenient, and accessible routes for pedestrians, cyclists and other non-motorised modes by:
 - "Developing and implementing improvements to strategic and local walking and cycle routes in the Borough;'
 - 'Improving the quality and safety of the public realm, implementing streetscape improvements to be outlined in the Enfield Design Guide and relevant area action plans, fostering road safety, and implementing 'Streets for People' initiatives;' and
 - 'Working with Department for Transport, Network Rail and Transport for London to ensure that West Anglia rail line improvements address the barrier to east-west movements for pedestrians and cyclists caused by the line in the east of the Borough, including the identification of alternative crossing points."



Enfield Development Management Document (2014)

3.13 The Enfield Development Management Document builds on the Core Strategy's objectives and policies and sets out the council's policies to ensure sufficient quality affordable homes for families, supporting healthy living, and tackling climate change.

Policy DMD 45 sets out the council's parking standards. It states that car parking standards will be considered against the standards set out in the London Plan and:

- The scale and nature of the development;
- The public transport accessibility (PTAL) of the site;
- Existing parking pressures in the locality;
- Accessibility to local amenities, and the needs of the future occupants of the developments.
- 3.14 In regard to cycle parking the document states that new developments should make provision for cyclists and powered two wheelers in accordance with the standards set out in the London Plan.
- 3.15 Policy DMD 48 Transport Assessments states that all major development proposals should be accompanied by a transport assessment and that for minor developments a transport statement may be required. A Travel Plan will be required where the transport assessment or transport statement identifies the need to improve modal choice, pedestrian accessibility, minimise congestion or reduce pollution. Given the scale of the proposed development, no Travel Plan is deemed necessary.



4 DEVELOPMENT PROPOSALS AND EFFECTS

4.1 The proposal seeks to provide an additional storey at No. 33 – 47 Grovebury Court to accommodate an additional 5 one bedroom apartments (3 x 1 bed 1 person and 2 x 1 bed 2 person) under the Permitted Developments right Class AA. The proposed layout plans are included at **Appendix A.**

Access Arrangements

4.2 The proposals do not include any changes to the access arrangements.

Car Parking

- 4.3 The results of the parking surveys revealed that there were 30 cars parked on Grovebury Court on the 1st December 2023 including 7 on the Site, with a further 83 cars parked on-street. The material submitted with the application for the consented scheme suggested that at most the additional 5 units would generate a demand for 3 cars; adopting the same approach for this application would suggest a demand for an additional 6 spaces when compared to the existing demand.
- 4.4 Notwithstanding the above, we have undertaken a further review of the Census data taking into account the location along with the size and type of dwelling, i.e. small apartments with a summary provided in **Table 4.1**; the data shows that whereas car ownership in the immediate area is circa 0.92 cars per household, data for the borough as a whole demonstrates that apartments and in particular smaller apartments having lower car ownership.

Table 4.1: Summary of Census Data (Enfield)						
No 1 car 2 cars 3 + Ca					Cars per HH	
	vans		vans	vans		
Overall (Houses and Apartments)	32%	43%	18%	6%	0.98	
Overall (Houses)	22%	44%	25%	9%	1.22	
Overall (Apartments)	50%	42%	7%	1%	0.59	
1 – 3 Room Apartments	59%	37%	4%	0%	0.46	

4.5 Based on the above, the potential unfettered demand of the proposed additional 5 units could generate a demand for 2 to 3 spaces. **Table 4.2** provides a summary of the Observed, Consented and Proposed Development anticipated demand for car parking based on Census data, with the figures suggesting that the anticipated level of increase could be accommodated along Grovebury Court, with further available capacity in the immediate area.



	Demand on Grovebury Cour 1 st Dec 2023 (0200)		5 th Dec (04	c 2023 45)
	Occ.	Free	Occ.	Free
Observed Scenario	30	9	27	12
Consented 5 Apartments Demand	3 sp	3 spaces		aces
Observed + Consented Scenario	33	6	30	9
Proposed 5 Apartments Demand	3 sp	3 spaces		aces
Observed + Development Scenario	33	6	30	9

Cycle Parking

4.6 The proposals associated with this application include the construction of 5 one bedroom apartments with 3 by 1 bedroom / 1 person apartments and 2 by 1 bedroom / 2 person apartments; as such, parking will be required for 6 bicycles. It is proposed to provide parking for 6 bicycles in a secure shelter in close proximity to the building as illustrated on the plans in **Appendix A**.

Deliveries and Refuse Collection

- 4.7 The proposals do not include making any changes to the delivery strategy for the Site the majority of which currently take place from Grovebury Court with vehicles able to exit and enter the adopted highway in forward gear using the parking courts to turn around; the vast majority of deliveries are likely to take place using a transit or similar sized vehicle, and associated with on-line purchases.
- 4.8 Residential developments usually typically generate of the order of 0.12 deliveries per unit per day, i.e. on average 1 per week per unit. This suggests that the 5 units would generate on average 1 delivery per day, some of which would be linked with a delivery to an existing dwelling in the local area. Overall, the anticipated increase in the number of deliveries is considered negligible and not impact on the operation of the local or wide highway network.
- 4.9 The proposals includes increasing the size of the existing bin storage, located external to the building to accommodate a total of 6 bins with 5 by 1,100ltr Eurobins with 3 for recyclables and 2 for general waste, plus one by 360ltr bin for food waste.
- 4.10 The bins will collected by the council as per existing.



Trip Generation

4.11

The 5 apartments would have capacity for up to 7 people with occupancy levels most likely to be between 5 and 6 persons assuming all of the units were occupied. As such, it is anticipated that there could be 5 - 6 departures during the morning peak period (7 - 10am) and 5 - 6 arrivals in the weekday evening peak period (4 - 7pm) with on average 2 - 3 arrivals or departures in any one hour; fewer movements are anticipated through the day. This number of trips is considered to be negligible and will fall within the daily fluctuation of trips and not impact on the surrounding highway or transport network with most residents expected to travel by sustainable modes.



5 SUMMARY AND CONCLUSION

Summary


- 5.1 TTP Consulting has been appointed to provide traffic and transport advice in relation to the proposed development at No.33-47 Grovebury Court.
- 5.2 In summary:
 - The Site currently comprises of a 3 storey (ground plus 2) apartment block; there are a total of 15 one-bedroom apartments. It achieves a PTAL rating of 3 and located within walking distance of a number of local amenities and public transport services.
 - Consented has been granted at Appeal to permit an extension to create a further 5 one bedroom apartments with associated cycle parking and refuse storage, with no additional car parking.
 - The proposals associated with this application seek permission to construct 5 new one bedroom apartments, i.e. the same as consented.
 - Cycle parking will be provided in accordance with the London Plan with parking provided for up to 6 bicycles. The cycle parking will be located external to the building at ground floor level in a safe and secure cycle store.
 - The proposed 5 one bedroom apartments are expected to generate a demand for 2 to 3 parking spaces based on census data. Parking surveys demonstrate that capacity exists to accommodate any potential demand without impacting on the availability of parking in the wide area.
 - Deliveries and refuse collection will be undertaken as per the existing situation, making use of the available space on-street the forecourt area of the cul-de-sac;
 - The resultant number of trips would not impact on the highway of public transport network.

Conclusion

5.3 The proposed scheme is consistent with relevant transport planning policy guidance and will not give rise to any material transport related impacts, and as such should not be refused on highways and transport grounds.

Appendix A (Application Plans)

PURPOSES BACK TO TH OF BROOKS ALL RIGHTS IN WRITING THESE DRA	ED DIMENSIONS ON Y, DO NOT SCALE FROM THIS DR ALL DIMENSIONS MIST BE DEEXED ON STEE AND M 44 ARCHTECT, THIS DRAWNG AND ANY DESIGNS INCO 16 JURDAY ANCHTECTS. 5 ARE RESERVED, NO PART OF THIS WORK MAY BE PR FROM BROCKS I AUGUNY ARCHTECTS. WINGS ARE INTERED FOR PLANNING FURIODES ON NUCLE THEY ARE, THIS WILL BE A BREACH OF BROCKS.	CONSISTENCIES MUST ICATED THEREON ARE 1 IODUCED WITHOUT PRI LY, THEY ARE NOT TO E	BE REPORTED THE COPYRIGHT OR PERMISSION IE USED FOR
REV.	AMENDMENT	BY:	DATE

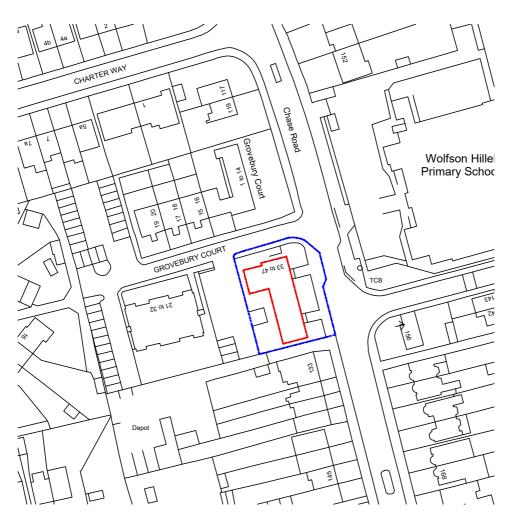





Brooks Murray Architects 41 Tobernacle Street, London, EC2A 4AA




CLIENT: Grovebury Southgate LTD


JOB: Grovebury Court London N14 4JR

DRAWING TITLE: Site Location Plan




Site Location Plan 1:1250 @ A4

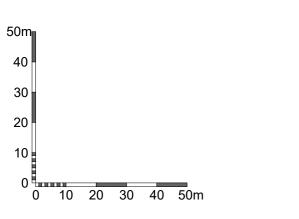

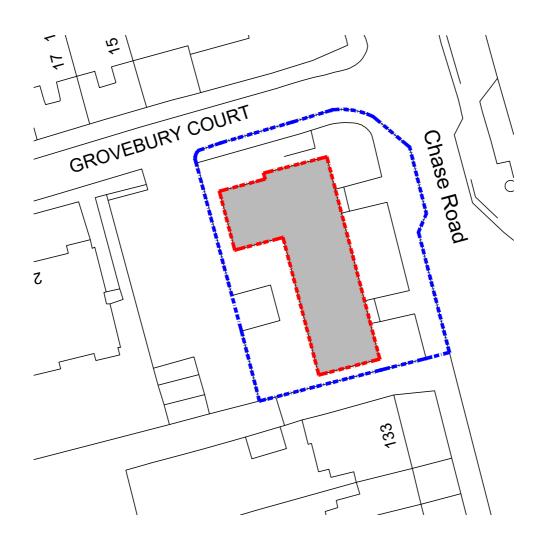



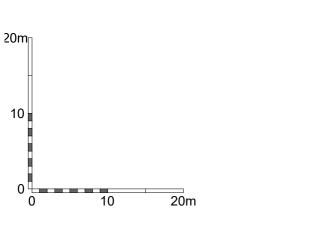




Brooks Murray Architects 41 Tabernacle Street, London, EC2A 4AA



CLIENT: Grovebury Southgate LTD

JOB: Grovebury Court London N14 4JR

DRAWING TITLE: Existing Block Plan

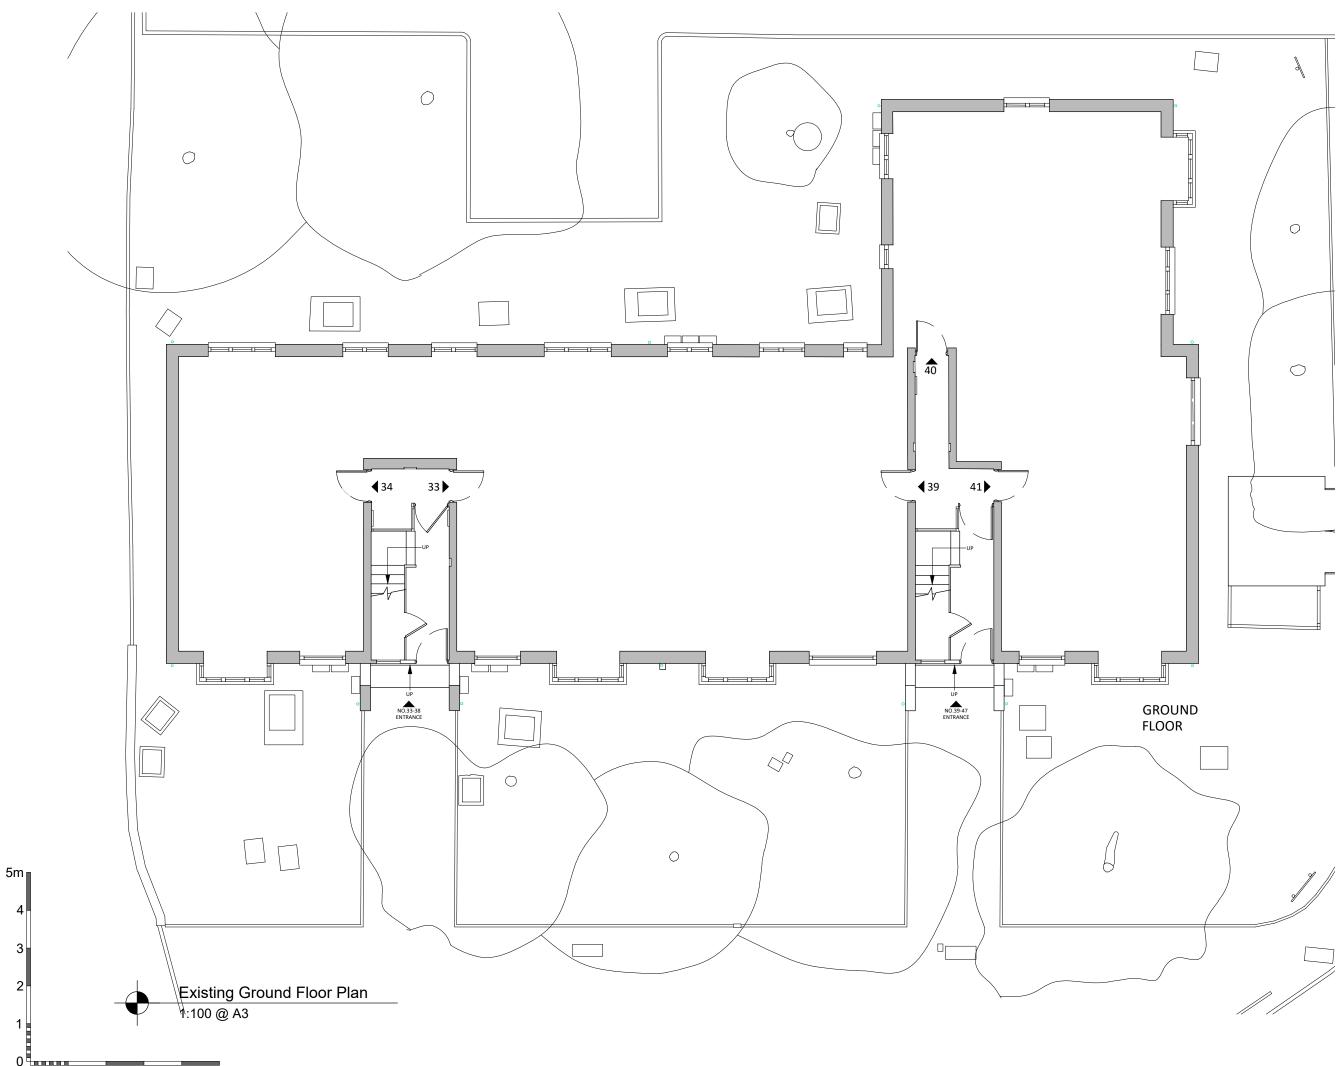

USE FIGURED DIMENSIONS ONLY. DO NOT SCALE FROM THIS DRAVING EXCEPT FOR PLANNING PURPOSES. ALL DIMENSIONS MIST BE CHECKED ON SITE ANY INCOMSISTENCES MILIST BE REPORTED BACKTO THE ARCHITECT. THIS BROWING MAD ANY DESIGNS INDICATED THEREON ARE THE COPYRIGHT OF BROOKS MURRAY ARCHITECTS.

ALL RIGHTS ARE RESERVED. NO PART OF THIS WORK MAY BE PRODUCED WITHOUT PRIOR PERMISSION IN WRITING FROM BROOKS AUBLAN ARCHITECTS THESE DRAWINGS ARE INTENDED FOR PLANNING PURPOSES ONLY. THEY ARE NOT TO BE USED FOR BUILDING, AND IF THEY ARE, THIS WILL BE IN BREACH OF BROOKS MURRAY'S COPYRIGHT.

REV. AMENDMENT BY: DATI	-
-------------------------	---



Brooks Murray Architects 41 Tabernacle Street, London, EC2A 4AA


+44 (0)2077399955 architects@brooksmurray.com




CLIENT:	
-	

Grovebury Southgate LTD

JOB:		
Grovebury Cour	rt	
London		
N14 4JR		
DRAWING TITLE:		
Existing Ground	Floor	
Plan		
SCALE:		
1:100@A3		
DATE:		
Febuary 2024		
STATUS:		
Permitted Deve	lopmer	nt
DRAWING NUMBER:	REV:	ISSUED BY:
1357.01.010		TS

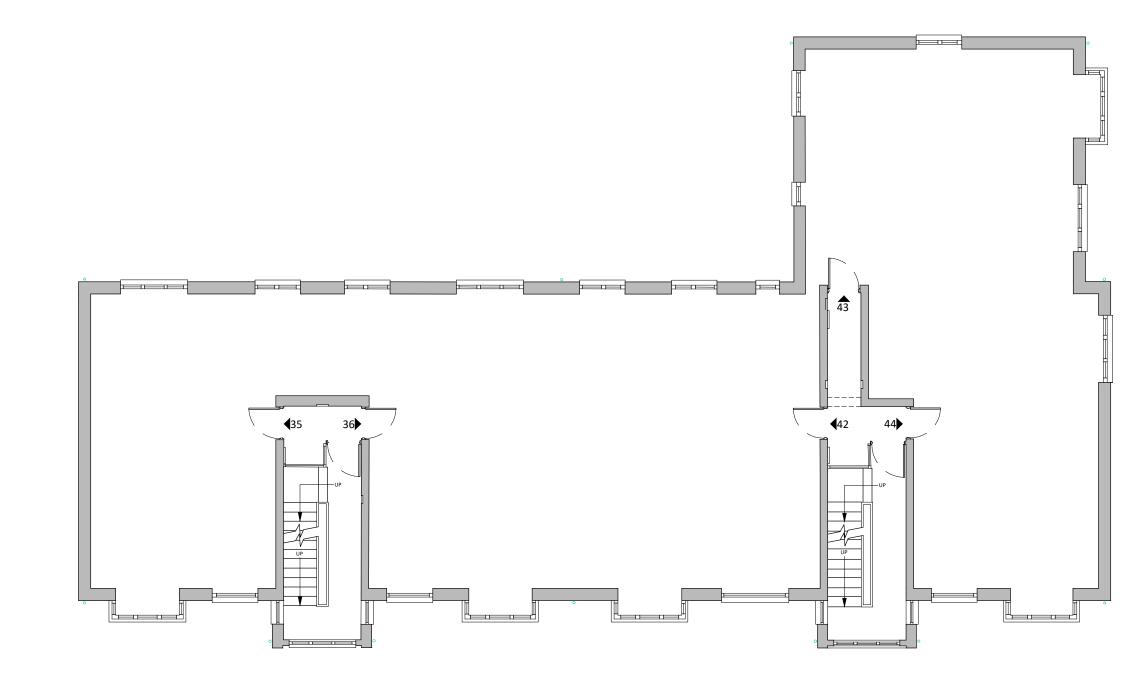

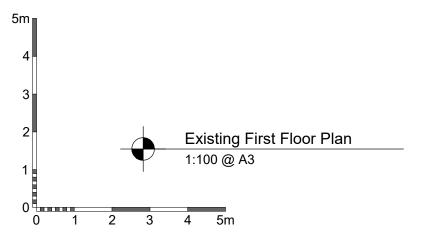

DARDOSE ALL LINERROVANTE DE LA LENA DE LA LE BY: DATE

REV. AMENDMENT

GROVEBURY COURT




Brooks Murray Architects 41 Tabernacle Street, London, EC2A 4AA




CLIENT: Grovebury Southgate LTD

Grovebury Court London N14 4JR DRAWING TITLE Existing First Floor Plan SCALE: 1:100@A3 DATE: Febuary 2024 STATUS: Permitted Development
DRAWING NUMBER: REV: ISSUED BY: 1357.01.011 TS

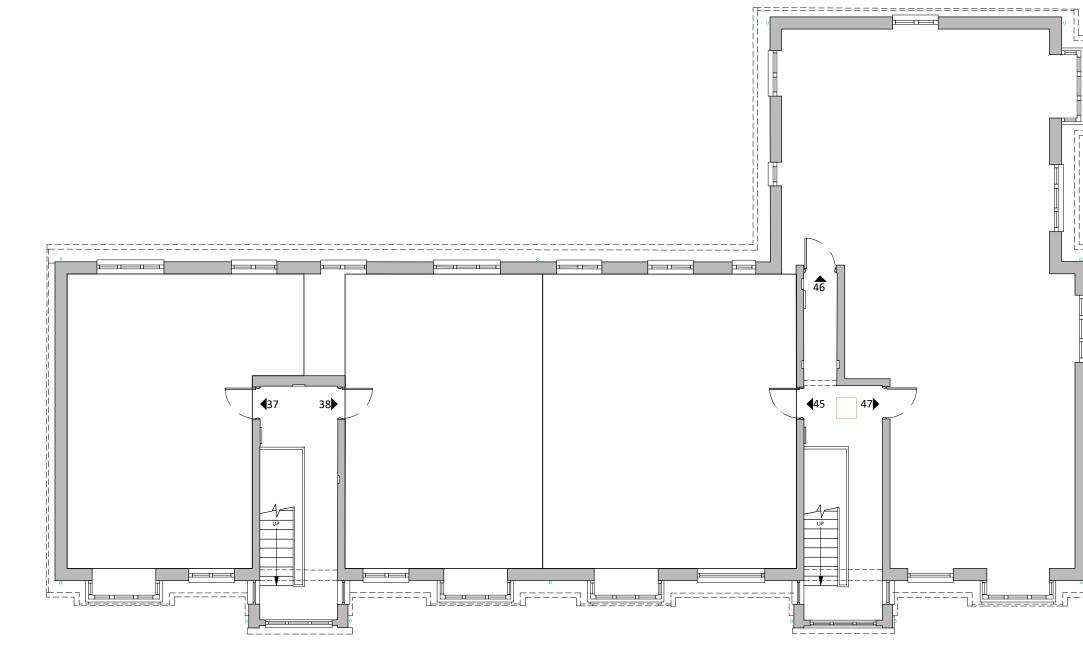

CHASE ROAD

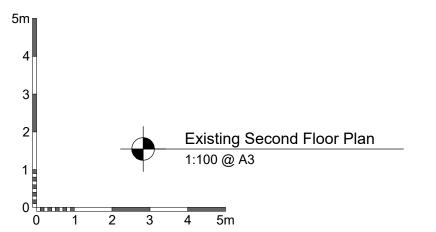

IN WRITING FROM BROOKS / MURRAY ARCHITECTS. THESE DRAWINGS ARE INTENDED FOR PLANING PURPOSES ONLY. THEY ARE NOT TO BE USED FOR BUILDING, AND IF THEY ARE, THIS WILL BE IN BREACH OF BROOKS MURRAY'S COPYRIGHT. BY: DATE



REV. AMENDMENT



GROVEBURY COURT




Brooks Murray Architects 41 Tabernacle Street, London, EC2A 4AA

brooks

CLIENT: Grovebury Southgate LTD JOB:

Grovebury Court

London N14 4JR DRAWING TITLE: Existing Second Floor Plan 1:100@A3 DATE: Febuary 2024 STATUS: Permitted Development DRAWING NUMBER: REV: ISSUED BY: 1357.01.012 TS

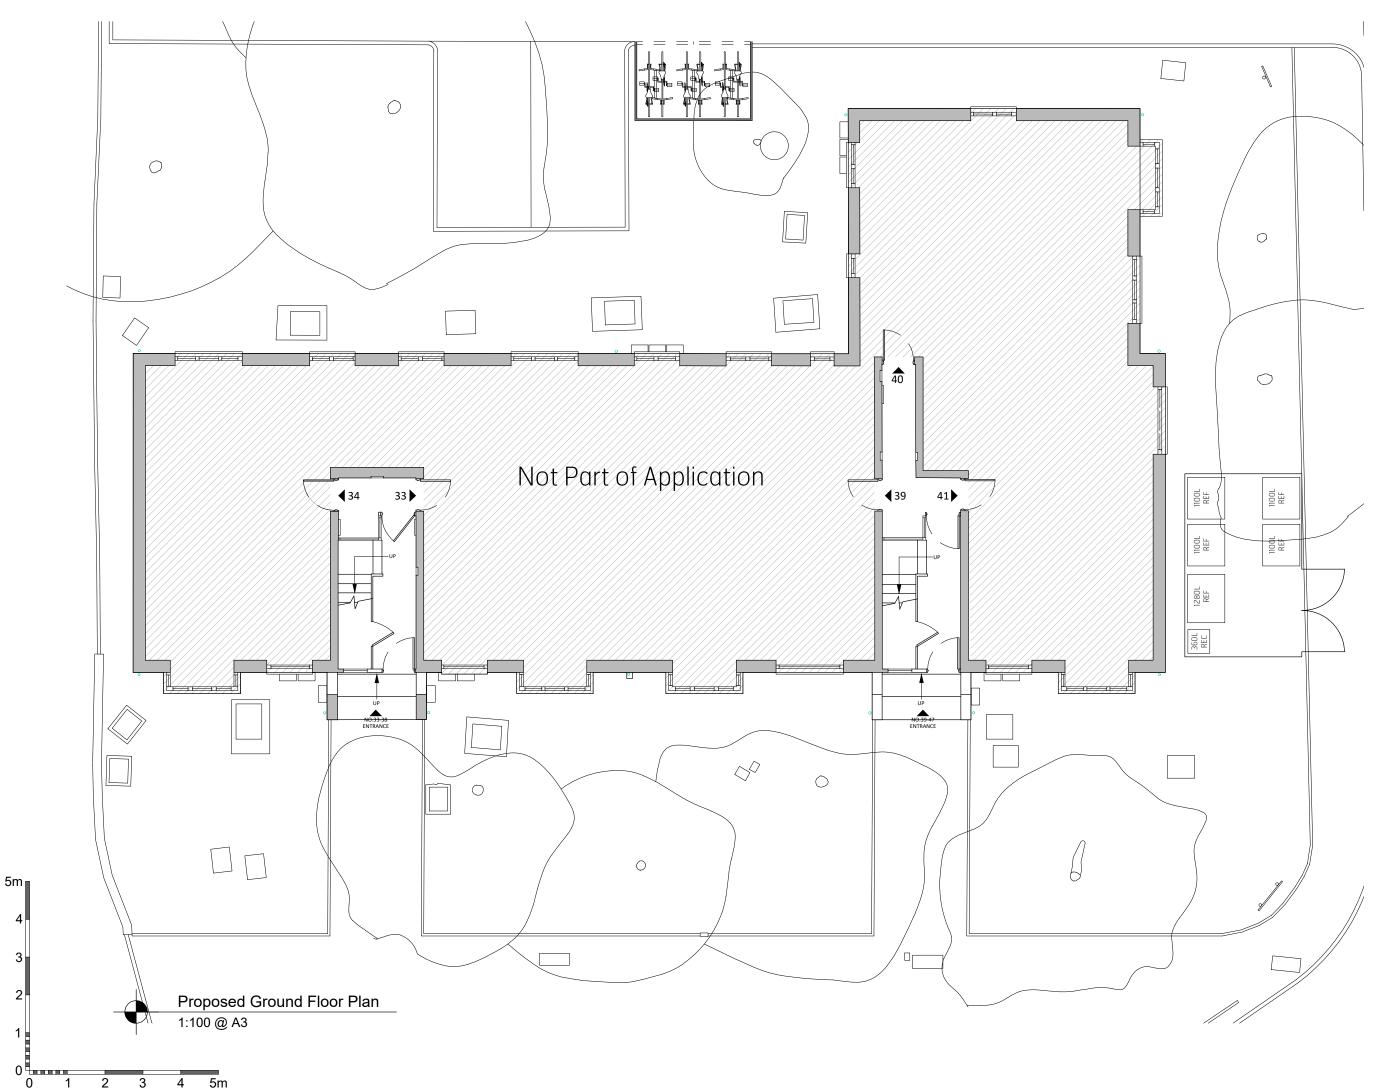

USE FIGURED DIMENSIONS ONLY. DO NOT SCALE FROM THIS DRAWING EXCEPTFOR PLANNING	
PURPOSES. ALL DIMENSIONS MUST BE CHECKED ON SITE ANY INCONSISTENCIES MUST BE REPORTED	
BACK TO THE ARCHITECT. THIS DRAWING AND ANY DESIGNS INDICATED THEREON ARE THE COPYRIGHT	
OF BROOKS / MURRAY ARCHITECTS.	
ALL RIGHTS ARE RESERVED. NO PART OF THIS WORK MAY BE PRODUCED WITHOUT PRIOR PERMISSION	
IN WRITING FROM BROOKS / MURRAY ARCHITECTS.	
THESE DRAWINGS ARE INTENDED FOR PLANNING PURPOSES ONLY. THEY ARE NOT TO BE USED FOR	

BY: DATE REV. AMENDMENT



Brooks Murray Architects 41 Tabernacle Street, London, EC2A 4AA




CLIENT: Grovebury Southgate LTD JOB: Grovebury Court London N14 4JR DRAWING TITLE: Proposed Ground Floor Plan 1:100@A3 DATE: Febuary 2024


STATUS:

Permitted Development

DRAWING NUMBER: REV: ISSUED BY: 1357.01.100

TS

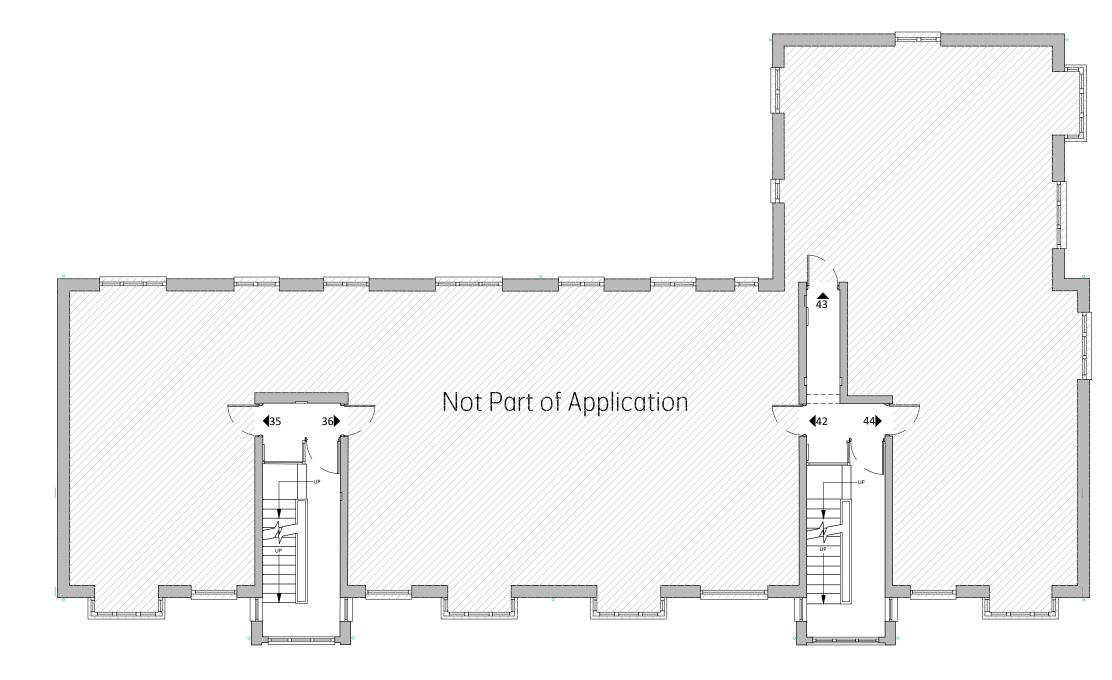

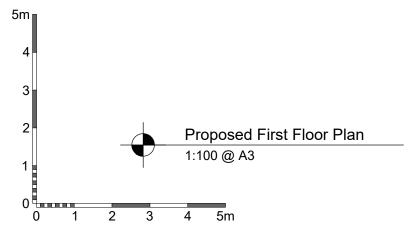

ALL RIGHTS ARE RESERVED. NO PART OF THIS WORK MAY BE PRODUCED IN TRUCT PRIME PERMISSIO IN WRITING FROM BROOKS' AMERIKAN ARCHITECTS. THESE DRAWINGS ARE INTENDED FOR PLANNING PURPOSES ONLY. THEY ARE NOT TO BE USED FOR BULLDING, AND IF THEY ARE, THIS WILL BE IN BREACH OF BROOKS MURRAY'S COPYRIGHT.

BY: DATE


REV. AMENDMENT




Brooks Murray Architects 41 Tabernacle Street, London, EC2A 4AA

brooks

CLIENT: Grovebury Southgate LTD JOB: Grovebury Court London N14 4JR DRAWING TITLE Proposed First Floor Plan scale: 1:100@A3 Date: Febuary 2024 STATUS: Permitted Development
DRAWING NUMBER: REV: ISSUED BY: 1357.01.101 TS

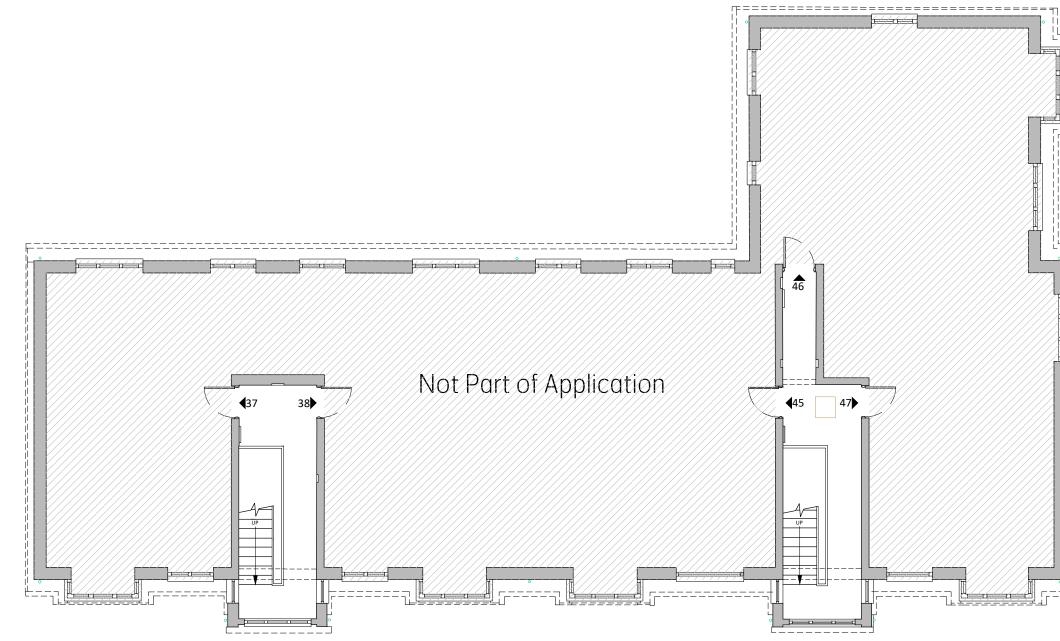

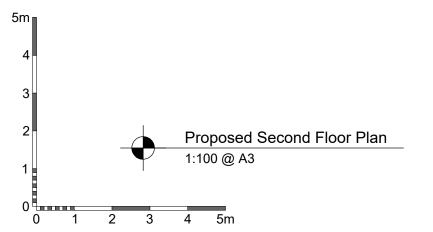

RPOSES ONLY. THEY ARE NOT TO BE USED FOR THESE DRAWINGS ARE INTENDED FOR PLANNING BUILDING, AND IF THEY ARE, THIS WILL BE IN BREA

BY: DATE

REV. AMENDMENT

GROVEBURY COURT





Brooks Murray Architects 41 Tabernacle Street, London, EC2A 4AA

'noks hr

CLIENT: Grovebury Southgate LTD JOB:


Grovebury Court London N14 4JR DRAWING TITLE: Proposed Second Floor Plan SCALE: 1:100@A3 DATE: Febuary 2024 STATUS: Permitted Development DRAWING NUMBER: REV: ISSUED BY: 1357.01.102 TS

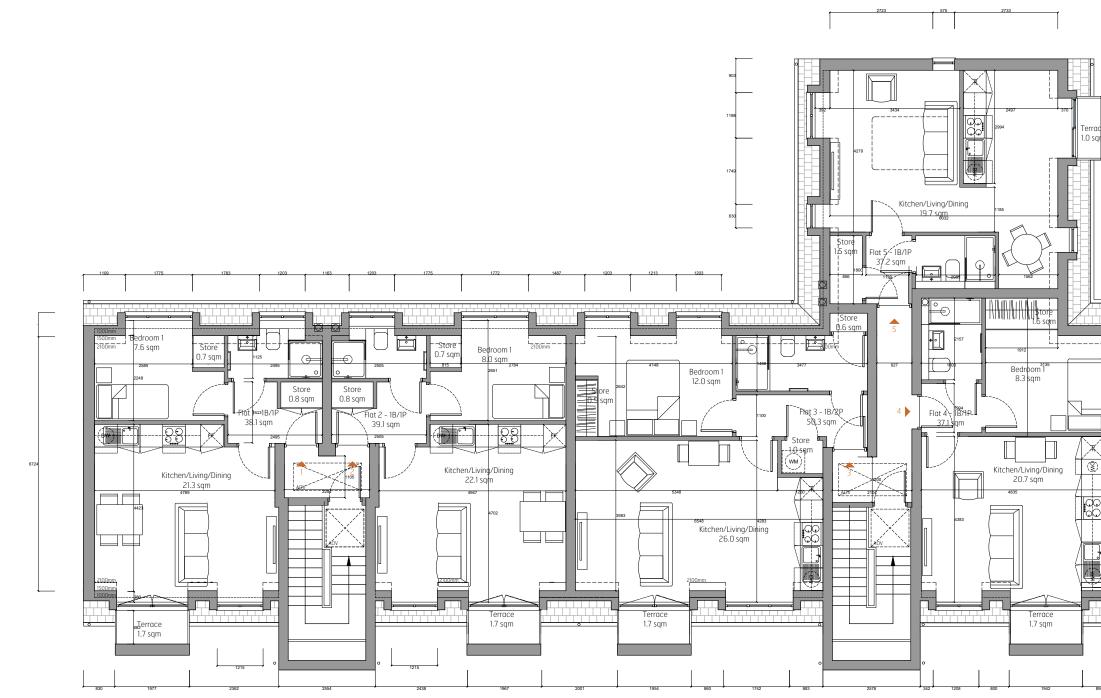

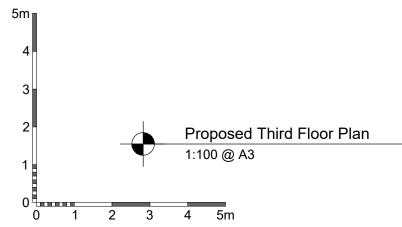



BUILDING,	AND IF THET ARE, THIS WILL BE IN BREACH OF BROOKS WORKAT S C	OFINIOR	
REV.	AMENDMENT	BY:	DATE

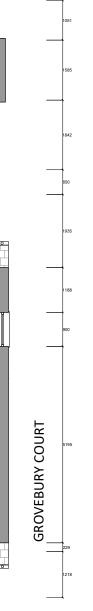



Brooks Murray Architects 41 Tabernacle Street, London, EC2A 4AA

(S

CLIENT: Grovebury Southgate LTD JOB:

London N14 4JR DRAWING TITLE: Proposed Third Floor Plan SCALE: 1:100@A3 DATE: Febuary 2024 STATUS: Permitted Development	Grovebury Cour	+	
DRAWING TITLE: Proposed Third Floor Plan SCALE: 1:100@A3 DATE: Febuary 2024 STATUS: Permitted Development	London	L	
1:100@A3 DATE: Febuary 2024 STATUS: Permitted Development	DRAWING TITLE: Proposed Third	Floor	
Febuary 2024 ^{STATUS:} Permitted Development			
Permitted Development			
		lopmer	nt
DRAWING NUMBER: REV: ISSUED BY: 1357.01.103 TS	DRAWING NUMBER: 1357.01.103	REV:	ISSUED BY: TS

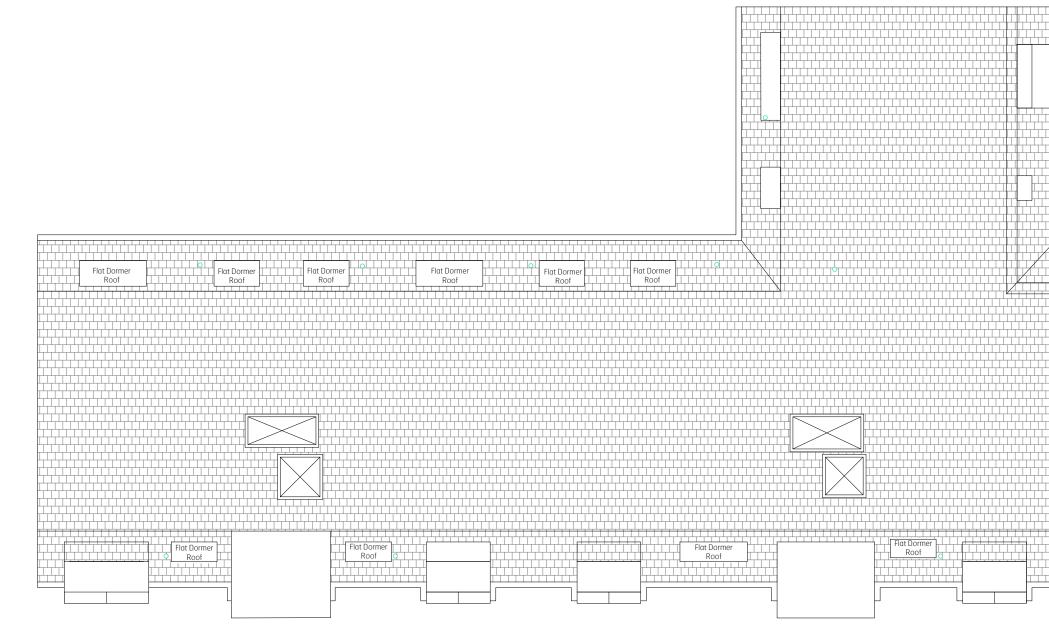

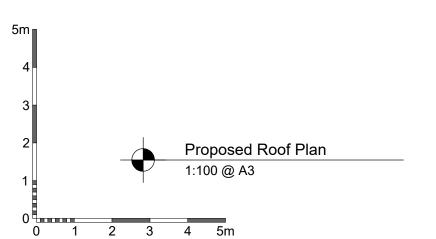

REV. AMENDMENT BY: DATE



GROVEBURY COURT




Brooks Murray Architects 41 Tabernacle Street, London, EC2A 4AA


brooks Π ЗY


CLIENT: Grovebury Southgate LTD JOB:

Grovebury Cour	t	
London		
N14 4JR		
DRAWING TITLE:		
Proposed Roof		
Plan		
SCALE:		
1:100@A3		
DATE:		
Febuary 2024		
STATUS:		
Permitted Devel	opmer	nt
DRAWING NUMBER:	REV:	ISSUED BY:
1357.01.104		TS

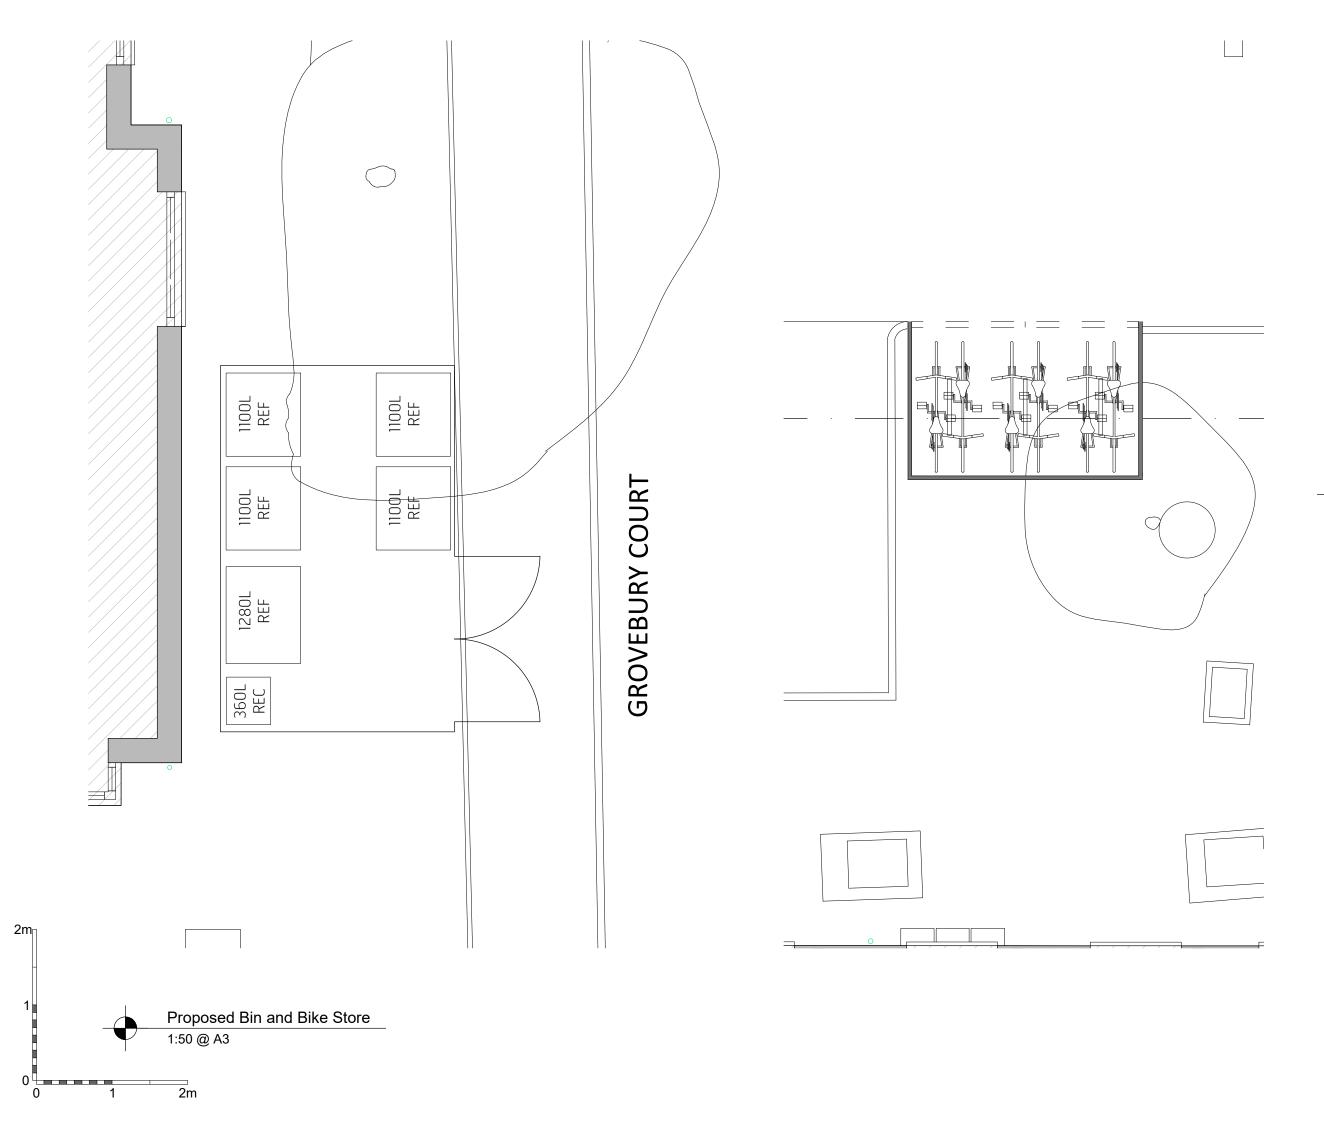

	REV.	AMENDMENT	BY:	DATE
--	------	-----------	-----	------

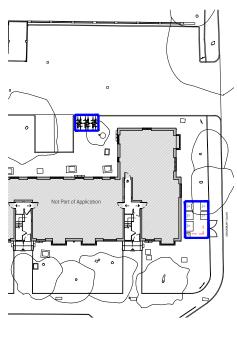

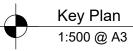



Brooks Murray Architects 41 Tabernacle Street, London, EC2A 4AA

brooks murray

CLIENT: Grovebury Southgate LTD JOB: Grovebury Court London N14 4JR DRAWING TITLE: Dropped Dip and Dike Store


Proposed Bin and Bike Store

SCALE:		
1:50 @A3		
DATE:		
February 2024		
STATUS:		
Permitted Deve	lopmer	nt
DRAWING NUMBER:	REV:	ISSUED BY:
1357.01.105		TS

Appendix B

(Bus Map)

Buses from Southgate (The Green and Broomfield Park)

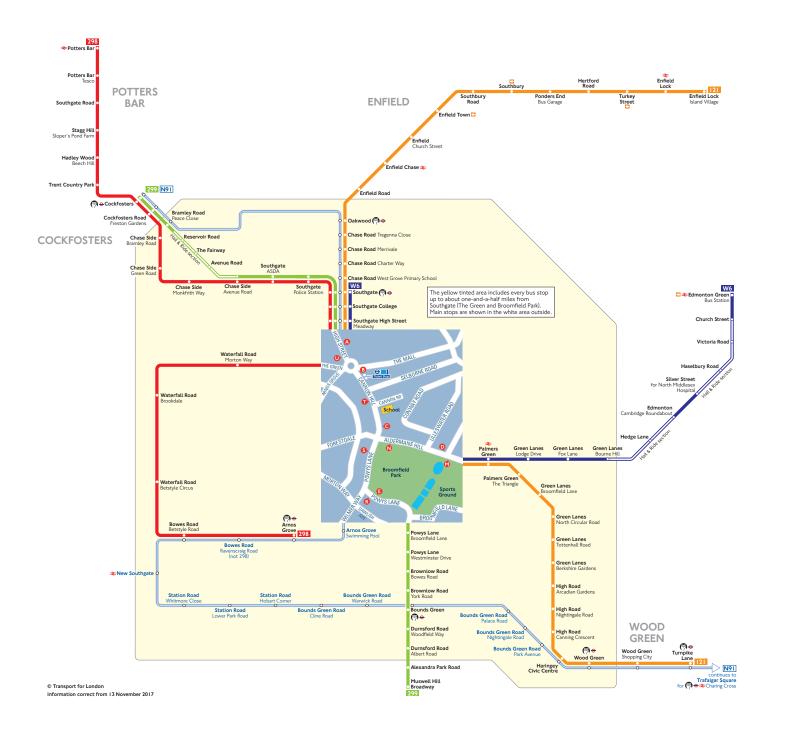

Route finder

Bus route	Towards	Bus stops
121	Enfield Lock	
	Turnpike Lane	
298	Arnos Grove	
	Potters Bar	0
299	Cockfosters	0000
	Muswell Hill Broadway	
W6	Edmonton Green	
	Southgate	

Night buses

Bus route	Towards	Bus stops
N91	Cockfosters	600
	Trafalgar Square	

Other buses

Bus route	Towards	Bus stops
616 Sch	Edmonton Green	
	Winchmore Hill	

Key

N91 Night buses in blue	121	Day buses in black
Connections with London Overground Connections with National Rail Tube station with 24-hour service Friday an	N91	Night buses in blue
そ Connections with National Rail ■ Tube station with 24-hour service Friday and	0	Connections with London Underground
Tube station with 24-hour service Friday an	Ð	Connections with London Overground
	₹	Connections with National Rail
	(?) 0	Tube station with 24-hour service Friday and Saturday nights
Sch School journeys	Sch	School journeys

Ways to pay



Appendix C (PTAL Output)

WebCAT PTAL Report _____ Site Details _ _ _ _ _ _ _ _ _ _ _ _ _ _ _ Grid Cell: 151848 Easting: 529645 Northing: 194952 Report Date: 31/01/2024 Scenario: Base Year Calculation Parameters -----Day of Week: M-F Time Period: AM Peak Walk Speed: 4.8 kph Bus Node Max Walk Access Time (mins): 8 Bus Reliability Factor: 2.0 LU Station Max Walk Access Time (mins): 12 LU Reliability Factor: 0.75 National Rail Station Max Walk Access Time (mins): 12 National Rail Reliability Factor: 0.75 Mode Stop Route Distance (metres) Frequency (vph) Walk Time (mins) SWT (mins) Weight TAT (mins) EDF ΑI CHASE ROAD CHARTER WAY 1.98 7 8.98 Bus 121 158.42 6 3.34 3.34 1 Bus AVENUE ROAD ORCHARD AVE 299 635.07 4 7.94 9.5 17.44 1.72 0.5 0.86 'Cockfosters-LHRT4LT ' 782.69 4.67 LUL Southgate 9.78 7.17 16.96 1.77 0.88 0.5 'RayLane-Cockfosters ' 782.69 3.67 9.78 8.92 LUL Southgate 18.71 1.6 0.5 0.8 'Oakwood-RayLane • 782.69 0.33 9.78 91.66 LUL Southgate 101.44 0.3 0.5 0.15 'Nthfields-Cockfoster' LUL Southgate 782.69 1 9.78 30.75 40.53 0.74 0.5 0.37 Southgate 'LHRT5-Cockfosters 782.69 6 9.78 5.75 LUL 15.53 1.93 1 1.93 'Uxbridge-Cockfosters' 782.69 3.67 LUL Southgate 9.78 8.92 18.71 1.6 0.5 0.8 LUL Southgate 'Ruislip-Cockfosters ' 782.69 2.33 9.78 13.63 23.41 1.28 0.5 0.64 'Oakwood-Uxbridge 91.66 LUL Southgate • 782.69 0.33 9.78 101.44 0.3 0.5 0.15 • LUL Southgate 'Oakwood-Ruislip 782.69 0.33 9.78 91.66 101.44 0.3 0.5 0.15


Total Grid Cell AI: 10.07 PTAL: 3

Appendix D (Parking survey)

K&M TRAFFIC SURVEYS

DATE: 1st & 5th DECEMBER 2023

DAY: FRIDAY & TUESDAY

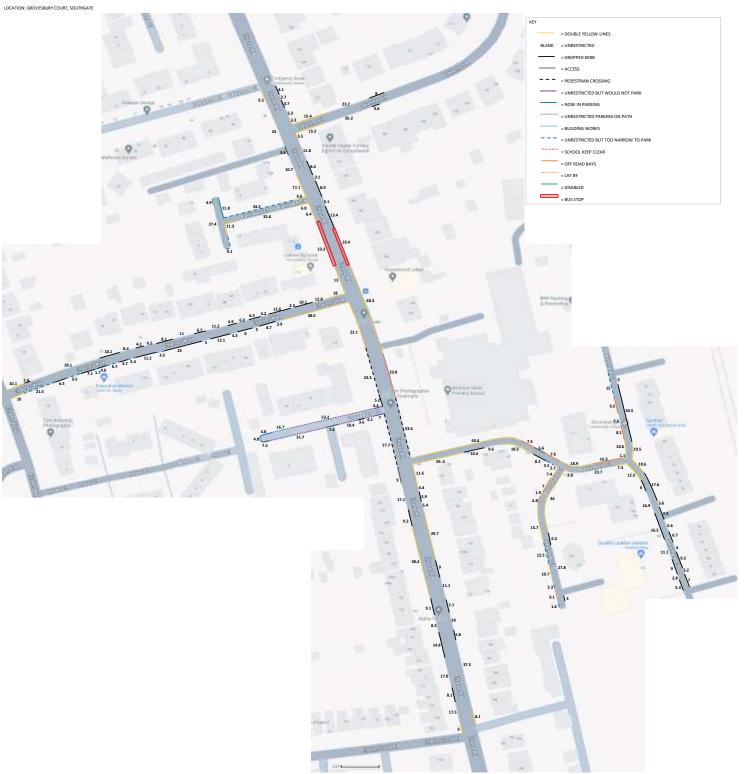

K&M TRAFFIC SURVEYS

DATE: 1st & 5th DECEMBER 2023

DAY: FRIDAY & TUESDAY



K&M TRAFFIC SURVEYS

DATE: 1st & 5th DECEMBER 2023


DAY: FRIDAY & TUESDAY

OCATION: GROVESBUR	1 0001, 300				TIME : 0200		
ROAD NAME	ZONE	RESTRICTION	METRES	5 METRES = 1 SPACE	PARKED	OBSERVED SPACES	%RESTRICTION STRESS
CHASE RD		DOUBLE YELLOW LINES	44.4				
	1	UNRESTRICTED DROPPED KERB	60.7 41.2	10	9	1	90.0%
		ACCESS	9				
		PEDESTRIAN CROSSING UNRESTRICTED BUT WOULD NOT PARK	27.7		1		
	2	UNRESTRICTED BOT WOOLD NOT PARK	16.8	3	2	0	100.0%
	2	DROPPED KERB ACCESS	3.6				
		UNRESTRICTED PARKING ON PATH	31.7	6	4	0	100.0%
	3	ACCESS	7.5				400.00/
		NOSE IN PARKING NOSE IN PARKING	4.8	1	1	0	100.0%
	4	BUILDING WORKS	16.7				
		UNRESTRICTED PARKING ON PATH UNRESTRICTED BUT WOULD NOT PARK	53.2 4.4	10	6	2	75.0%
CHASE RD		DROPPED KERB	5.2				
	5	PEDESTRIAN CROSSING DOUBLE YELLOW LINES	23.3 22.1				
CHARTER WAY		DOUBLE YELLOW LINES	48.5				
	6	UNRESTRICTED DROPPED KERB	18.2 84.9	2	1	1	50.0%
		UNRESTRICTED BUT TOO NARROW TO PARK	46.3				
		DOUBLE YELLOW LINES	28.1				
	7	DROPPED KERB UNRESTRICTED	66.9 101.8	16	1 10	5	66.7%
CHASE RD	8	DOUBLE YELLOW LINES	19.4				
0100210	-	BUS STOP DOUBLE YELLOW LINES	23.3				
FAIRLAWN CLOSE	9	UNRESTRICTED	33.6	6	6	0	100.0%
		UNRESTRICTED BUT TOO NARROW TO PARK	9.1	F	2		100.0%
	10	UNRESTRICTED DISABLED	27.4 4.9	5	5	0	100.0% 100.0%
	11	NOSE IN PARKING	11.8	3	3	0	100.0%
	12	UNRESTRICTED BUT TOO NARROW TO PARK DOUBLE YELLOW LINES	34.3 6.6				
		DOUBLE YELLOW LINES	20.3			Ì	
	13	UNRESTRICTED ACCESS	34.7 5.6	6	5	1	83.3%
CHASE RD		DROPPED KERB	7.8				
	14	UNRESTRICTED	8	1	0	1	0.0%
		DOUBLE YELLOW LINES DOUBLE YELLOW LINES	3.3				
LAKEHEATH	15	UNRESTRICTED	23.7	4	1	3	25.0%
		DROPPED KERB DROPPED KERB	8				
	16	UNRESTRICTED	26.2	5	1	3	25.0%
		DOUBLE YELLOW LINES DOUBLE YELLOW LINES	15.2 51.8				
		UNRESTRICTED	20	3	1	2	33.3%
CHASE RD	17	DROPPED KERB BUS STOP	30.7 23.4				
		SCHOOL KEEP CLEAR	23.4				
		PEDESTRIAN CROSSING	33.6				
	18	DOUBLE YELLOW LINES OFF ROAD PARKING - BAYS	83.4 31.8	12	8	2	80.0%
		ACCESS	6.6				
DALRYMPLE CLOSE		DOUBLE YELLOW LINES OFF ROAD PARKING - BAYS	10.6 17.6	5	4	0	100.0%
	19	UNRESTRICTED	7.5	1	1	0	100.0%
		UNRESTRICTED BUT TOO NARROW TO PARK UNRESTRICTED	15	1	0	1	0.0%
	20	DROPPED KERB	34.5			_	
		DOUBLE YELLOW LINES DOUBLE YELLOW LINES	10.5				
	21	DROPPED KERB	48				
		UNRESTRICTED	16.4	1	2	0	100.0%
	22	DROPPED KERB UNRESTRICTED	36.8 30.8	5	0	5	0.0%
		DOUBLE YELLOW LINES	12.3				
	23	DOUBLE YELLOW LINES UNRESTRICTED	10.1 23.7	4	3	0	100.0%
		DOUBLE YELLOW LINES	34			-	
	24	DROPPED KERB UNRESTRICTED	9.3 27.8	5	3	1	75.0%
		UNRESTRICTED BUT TOO NARROW TO PARK	17.4			_	
	25	LAY BY DOUBLE YELLOW LINES	19.8 25	3	0	3	0.0%
		DOUBLE YELLOW LINES OFF ROAD PARKING	11.8	4	3	0	100.0%
		DOUBLE YELLOW LINES	50.5		1		
	26	UNRESTRICTED BUT TOO NARROW TO PARK DROPPED KERB	3.5 18.7	╞───┨			
		UNRESTRICTED	9.6	1	1	1	50.0%
CHASE RD	27	DOUBLE YELLOW LINES UNRESTRICTED	49.4 68.4	12	7	4	63.6%
0		DROPPED KERB	28.4		<u> </u>		55.076
	A	UNRESTRICTED PARKING AREA		X 10 BAYS	7	3	70.0%
	B C	UNRESTRICTED PARKING AREA UNRESTRICTED PARKING AREA		X 8 BAYS X 12 BAYS	8	0 7	100.0% 41.7%
SEE MAP OF ZONES	D	UNRESTRICTED PARKING AREA	APPRO	X 12 BAYS	5	7	41.7%
	E	UNRESTRICTED PARKING AREA	APPRC	X 8 BAYS	4	4	50.0% 45.5%

TIME : 0445 %RESTRICTION STRESS PARKED OBSERVED SPACES 100.0% 0 5 66.7% 100.0% Δ 100.0% 1 100.0% 1 0 87.5% 50.0% 80.0% 12 100.0% n 2 100.0% 100.0% 100.0% 5 0 1 0 3 6 0 100.0% 0 100.0% 1 66.7% 2 1 50.0% 2 66.7% 80.0% 100.0% 0 100.0% 1 0.0% 0 1 100.0% 0 2 0.0% 0 100.0% Δ 50.0% 2 0.0% 0 100.0% 3 50.0% ZONE 27 : Tuesday 5th December, a set of temporary roadworks/lights were in place during the am beat survey 75.0% 6 50.0% 87.5% 7 1 8 4 66.7% 41.7% 5 7 62.5% 45.5%

TUESDAY 5th DECEMBER 2023

ZONE 1 : Tuesday 5th December, a set of temporary roadworks/lights were in place during the am beat survey

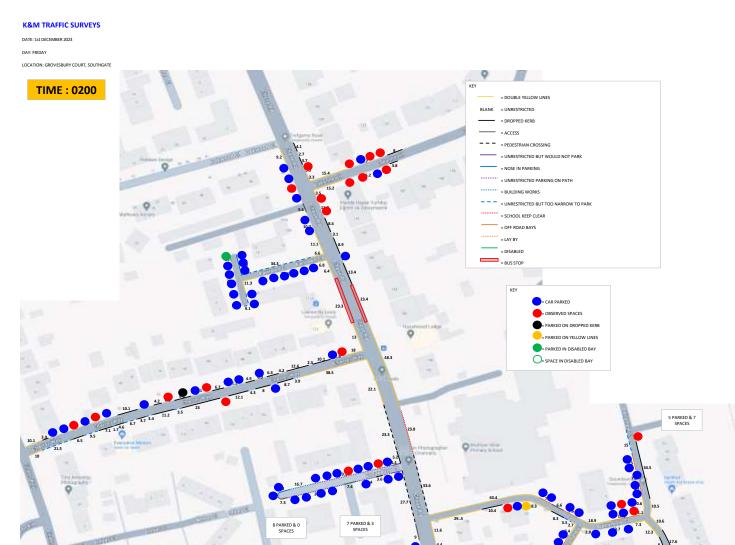

5 PARKED & 7 SPACES

4 PARKED & 4 SPACES

> 5 PARKED & 6 SPACES

