



Geotechnical Survey Report

FSI Ref: 25787
Issue Date: January 2023

Risk Address: 25 Kingston Hill
Kingston upon Thames
Surrey
KT2 7PW

Engineer: [REDACTED]

Company: Claims Consortium Group
Claim Ref: KH21292818

Managing Director: [REDACTED]
Finance Director: [REDACTED]

Geotechnical Compliance & Logistics Supervisor: [REDACTED]

Laboratory Manager: [REDACTED]


Senior Geologist: [REDACTED]
Assistant Geologist: [REDACTED]
Geotechnical Assistant: [REDACTED]










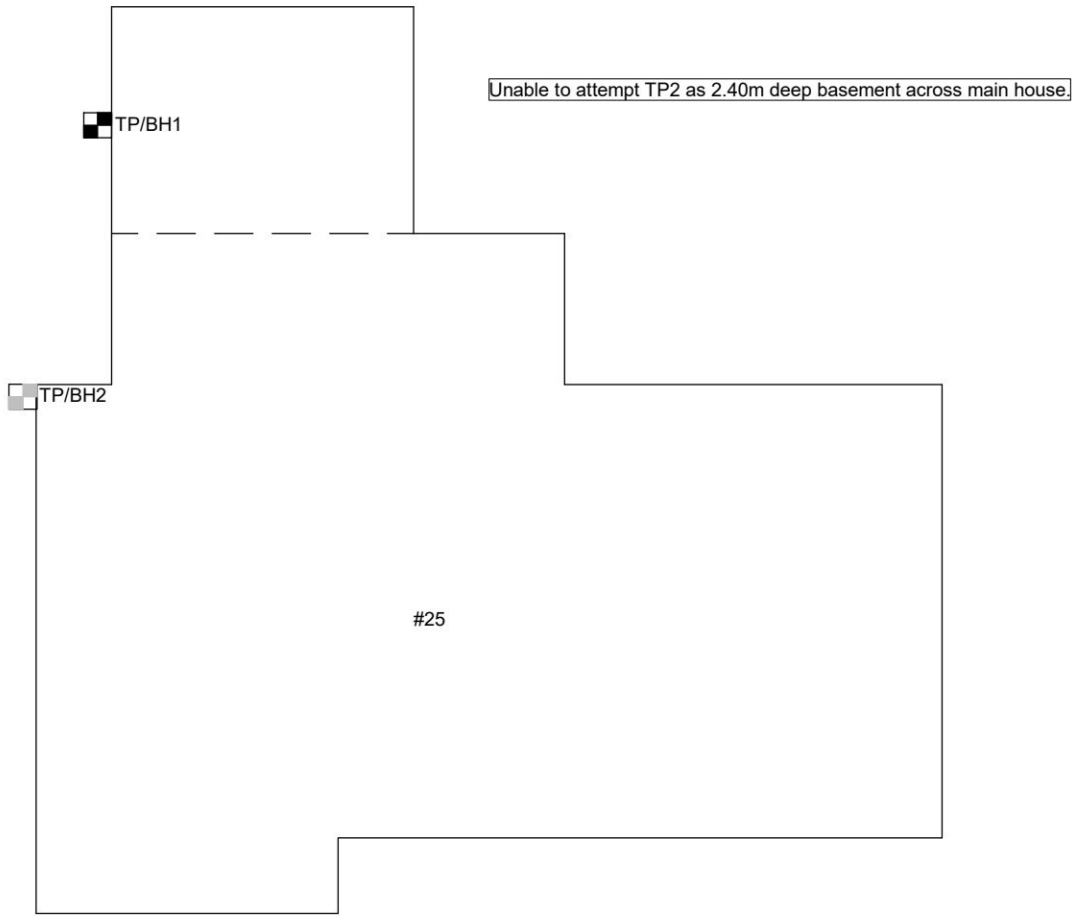

SITE PLAN

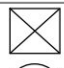Property Address: 25 Kingston Hill, Kingston upon Thames, Surrey, KT2 7PW

Client Claim Ref: KH21292818

Survey date: 03/01/2023

Operative: SE1


Scale: NTS	Drawn by: BW	Key:	 Trial Pit  Borehole	 Manholes  Soil & Vent Pipe	 Rain Water Pipe  Soil & Vent Pipe	 Surface Water Gully  Foul Water Gully	 Shrub	 Tree (Conifer)	 Tree (Deciduous)
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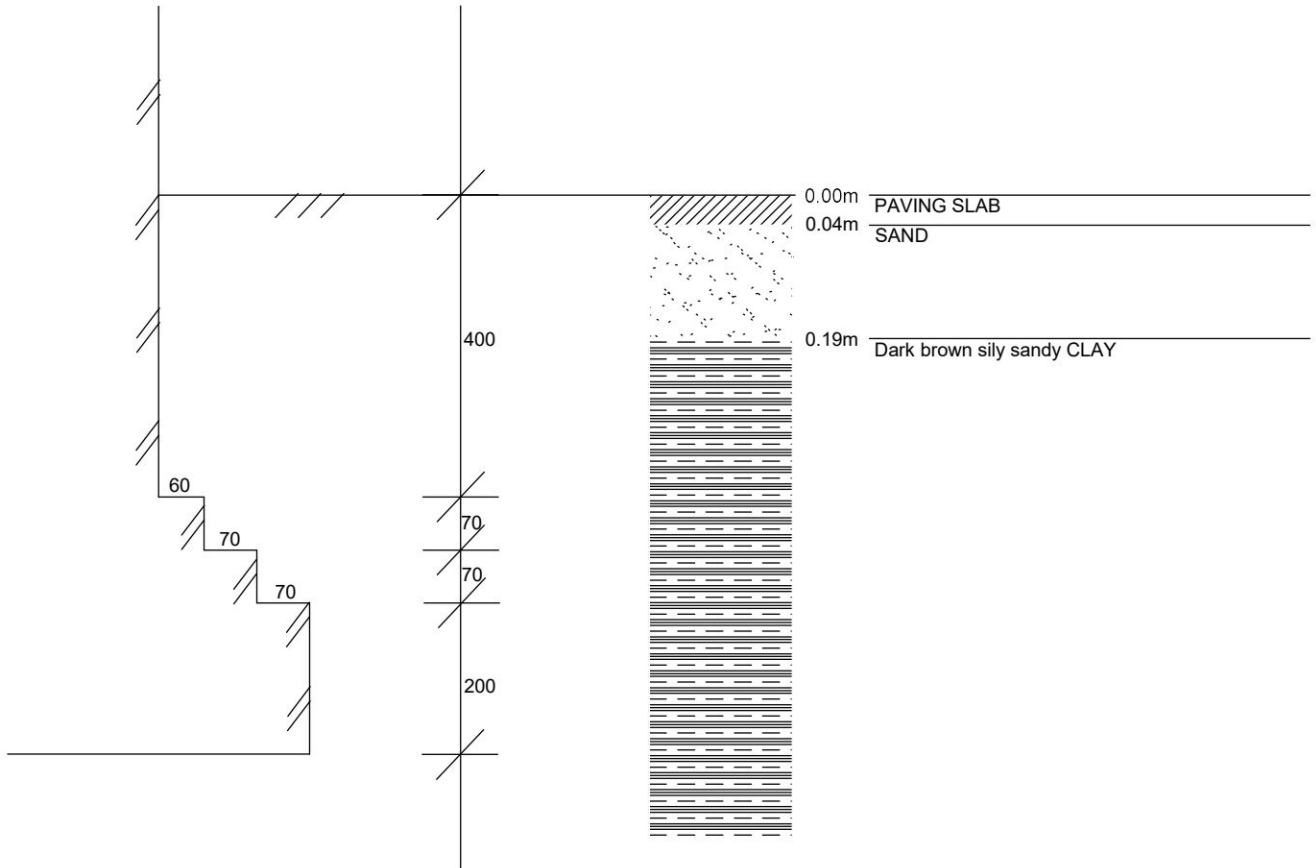
TRIAL PIT 1

Property Address: 25 Kingston Hill, Kingston upon Thames, Surrey, KT2 7PW


Client Claim Ref: KH21292818

Survey date: 03/01/2023

Operative: SE1



D1 @ F.L. (0.74m)
V = 94-100kPa
Founding strata: Dark brown silty sandy CLAY
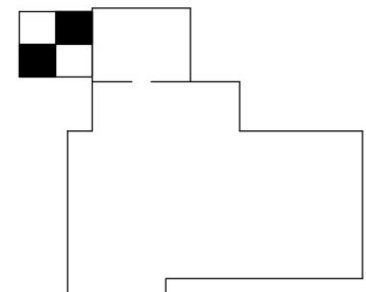
<p>Trial Pit Location:</p> 	<p>Drawn by:</p> <p style="text-align: center;">BW</p> <hr/> <p>Scale:</p> <p style="text-align: center;">1:10</p>
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D= small disturbed sample, B= large bulk sample, U= undisturbed sample,
MP= mackintosh probe blow counts, V= shear vane reading (kPa)



Fastrack Site Investigations Ltd
Unit 9, Tyndales Farm
Southend Road
Maldon CM9 6TQ

Borehole Log

Borehole No.

BH1

Sheet 1 of 1

Project Name: KH21292818

Project No.
25787

Site Date: 03/01/2023

Hole Type
BH

Location: 25 Kingston Hill, Kingston upon Thames, Surrey, KT2 7PW

Scale
1:17

Client: Claims Consortium Group

Logged By
SE1

Water Strikes	Sample and In Situ Testing			Depth (m)	Legend	Stratum Description
	Depth (m)	Type	Results			
				0.04	PAVING SLAB	
					SAND	
				0.19	Dark brown silty sandy CLAY	
					Foundation top-0.40m (multiple brick constructs projecting 60mm 70mm and 70mm with thicknesses of 70mm 70mm and 200mm respectively)	
	0.74	D	V (kPa) = 100 V (kPa) = 94	0.80	Foundation level-0.74m Roots noted at F/L	
					Mid brown/orange CLAY	
					CLAY noted to be mid brown in colour and contain grey mottle and scattered sand pockets by 1.20m	
	1.50	D	V (kPa) = 118 V (kPa) = 120		Roots noted at 1.50m	
					CLAY noted to contain grey mottles by 2.10m	
	2.00	D	V (kPa) = 120 V (kPa) = 122		Roots noted at 2.00m	
					CLAY noted to contain grey mottles by 2.10m	
	2.50	D	V (kPa) = 128 V (kPa) = 130			
	3.00	D	V (kPa) = 140	3.00		End of Borehole at 3.000m

Key: D - Disturbed Sample V - Insitu Vane Test MP - Mackintosh Probe Test

Remarks: Borehole closed at 3.00m on completion.
Borehole noted to be dry on completion.



LABORATORY RESULTS

Property Address: 25 Kingston Hill, Kingston Upon Thames, Surrey, KT2 7PW
Client Claim Ref: KH21292818 **Client:** Claims Consortium Group

SAMPLE DETAILS	ANALYSIS REQUESTED
Investigation date: 03/01/2023	Moisture Content <input checked="" type="checkbox"/> PSD <input type="checkbox"/>
Sample details: Bags as received	Liquid Limit <input checked="" type="checkbox"/> Soil Suction <input type="checkbox"/>
Samples received: 05/01/2023	Plastic Limit <input checked="" type="checkbox"/> Shear Strength <input type="checkbox"/>
Schedule recieved: 05/01/2023	Plasticity Index <input checked="" type="checkbox"/> Contamination <input type="checkbox"/>
Samples tested: 09/01/2023-12/01/2023	Root ID <input checked="" type="checkbox"/> Root/Tree DNA <input type="checkbox"/>
Results reported: 12/01/2023	Other (please state) _____ <input type="checkbox"/>

TEST DETAILS

General

Sample descriptions were written in accordance with BS 5930:1999.

Samples were prepared in accordance with BS 1377: Part 1: 1990, section 7

Samples from this contract will be retained for 1 calendar month following the issue of this report unless otherwise notified

Written approval is required from Fastrack Site Investigations Limited to reproduce report in full. The results shown within this report only relate to the samples tested

Moisture Content

Samples were tested in accordance with BS 1377: Part 2: 1990, section 3.2 (Oven drying method)

In accordance with Note 1 to paragraph 3.2.4 of BS 1377 Part 2 1990; these moisture contents have been corrected to give the equivalent moisture content of the fraction passing the 425µm sieve, to enable comparison with the liquid & plastic limits. (If condition of test is 'natural' the retained percentage is an estimated value, if condition is 'washed' the percentage is a measured value).

Samples are dried at 105-110°C unless otherwise stated.

Atterberg Limits

Samples were tested in accordance with BS 1377: Part 2: 1990, section 4.3 (4 drop LL), 4.4 (1 drop LL), 5.3 (PL) and 5.4 (PI)

Test results on samples with a sand content, may show less accurate results. If condition of test is 'washed' results relate to the fraction passing the 425µm sieve only.

* *Driscoll's rules deem the soil to be desiccated where the moisture content is less than the value calculated using driscoll's rule 1 and/or 2*

Particle Size Distribution

Samples were tested in accordance with BS 1377: Part 2: 1990 section 9.2 (Wet sieving method)

Undrained Shear Strength

Samples were prepared in accordance with BS 1377: Part 7: 1990 section 8.3 and testing in accordance with BS 1377: Part 7: 1990: section 8.4 (undrained shear strength in triaxial compression without measurement of pore pressure (UU))

Soil Suction



Samples were prepared and tested based on the BRE digest No:IP4/93 (Corrected). 'A method of determining the state of desiccation in clay soils.' (Filter paper method).

Test results on samples with a sand or silt content, may show less accurate results. Deviation to standard procedure - Polythene bags are not used from weighing filter papers.

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BOREHOLE 1

Depth (m)	MC (%)	Corr. MC (%)	LL (%)	PL (%)	PI (%)	Class	% Retained (425µm)	Soil Suction (kPa)	Condition of test	Soil Description
0.74	24.3	24.91	54	28	26	CH	2.44		Natural	Brown silty, sandy CLAY containing orange mottle
1.50	25.7	25.7					0		Natural	Brown silty, sandy CLAY containing orange mottle
2.00	29	29	68	28	40	CH	0		Natural	Brown silty CLAY containing grey and orange mottle
2.50	29.6	29.6					0		Natural	Brown silty CLAY containing grey and orange mottle
3.00	31.6	31.6	75	29	46	CV	0		Natural	Brown silty CLAY containing grey and orange mottle

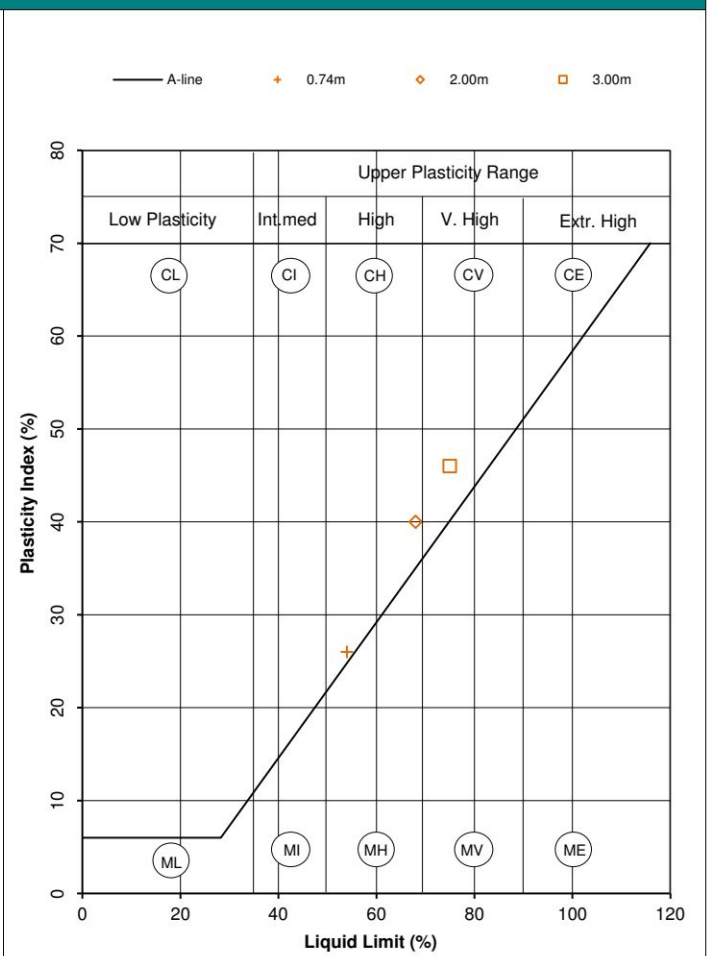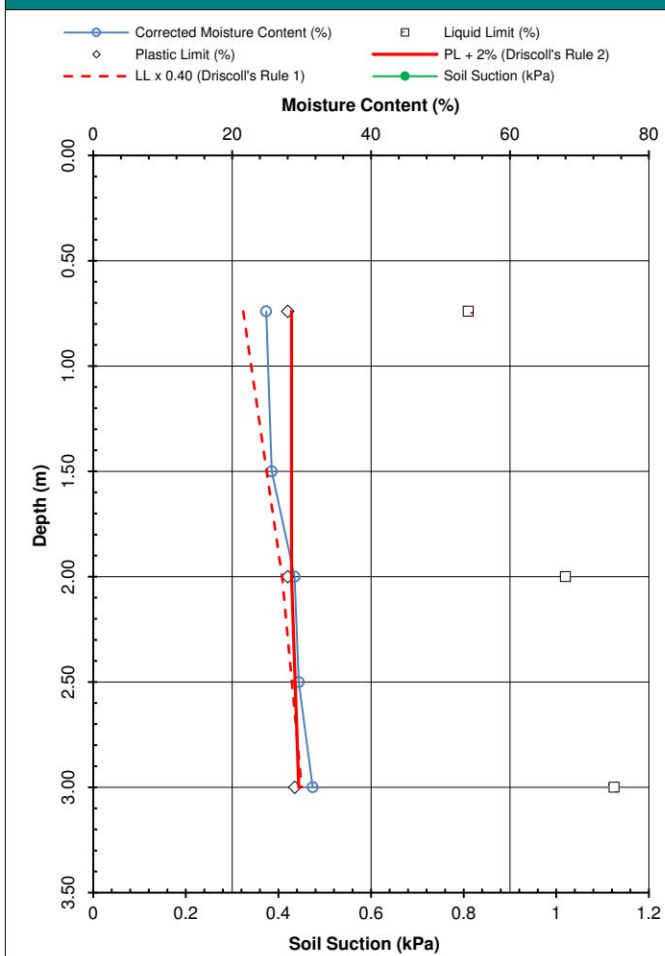

Comments:

Issued by: Jade McLellan (Laboratory Manager) Ted Smith (Laboratory Technician)
 Isabella Acerbis (Laboratory Supervisor)

Fastrack Site Investigations Ltd
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ROOT IDENTIFICATION

25 Kingston Hill,

Client Reference: 25787
Report Date: 13 January 2023
Our Ref: R49925

Sub Sample	Species Identified		Root Diameter	Starch
BH1:				
FL	<i>Sambucus</i> spp.	1	1 mm	Abundant
1.5m	<i>Sambucus</i> spp.	2	1 mm	Abundant
2m	<i>Sambucus</i> spp.	3	<1 mm	Low

Comments:

- 1 - Plus 1 other also identified as *Sambucus* spp.
- 2 - Plus 2 others also identified as *Sambucus* spp.
- 3 - Plus 1 other also identified as *Sambucus* spp.

Sambucus spp. are elders.

Signed: M D Mitchell

Unless we are otherwise instructed in writing, the above sample material will normally be disposed of 6 years after the date of this report.

