



NOTES:


1. This drawing is to be read in conjunction with all relevant contract documentation from the design team, with any conflicting information to be brought to the attention of PolarDesign Architecture in writing before commencing on site.
2. The contractor is to check and verify all levels and dimensions before construction. Any discrepancies are to be brought to the attention of PolarDesign Architecture
3. All dimensions in mm, unless otherwise stated.
4. Do not scale from this drawing.
5. All sub base and concrete design and specification to engineer's details. All diagrams provided here are purely indicative.
6. Waterproofing of any element to be specified by others.
7. All proprietary products shall be installed in accordance with manufacturers written instructions.

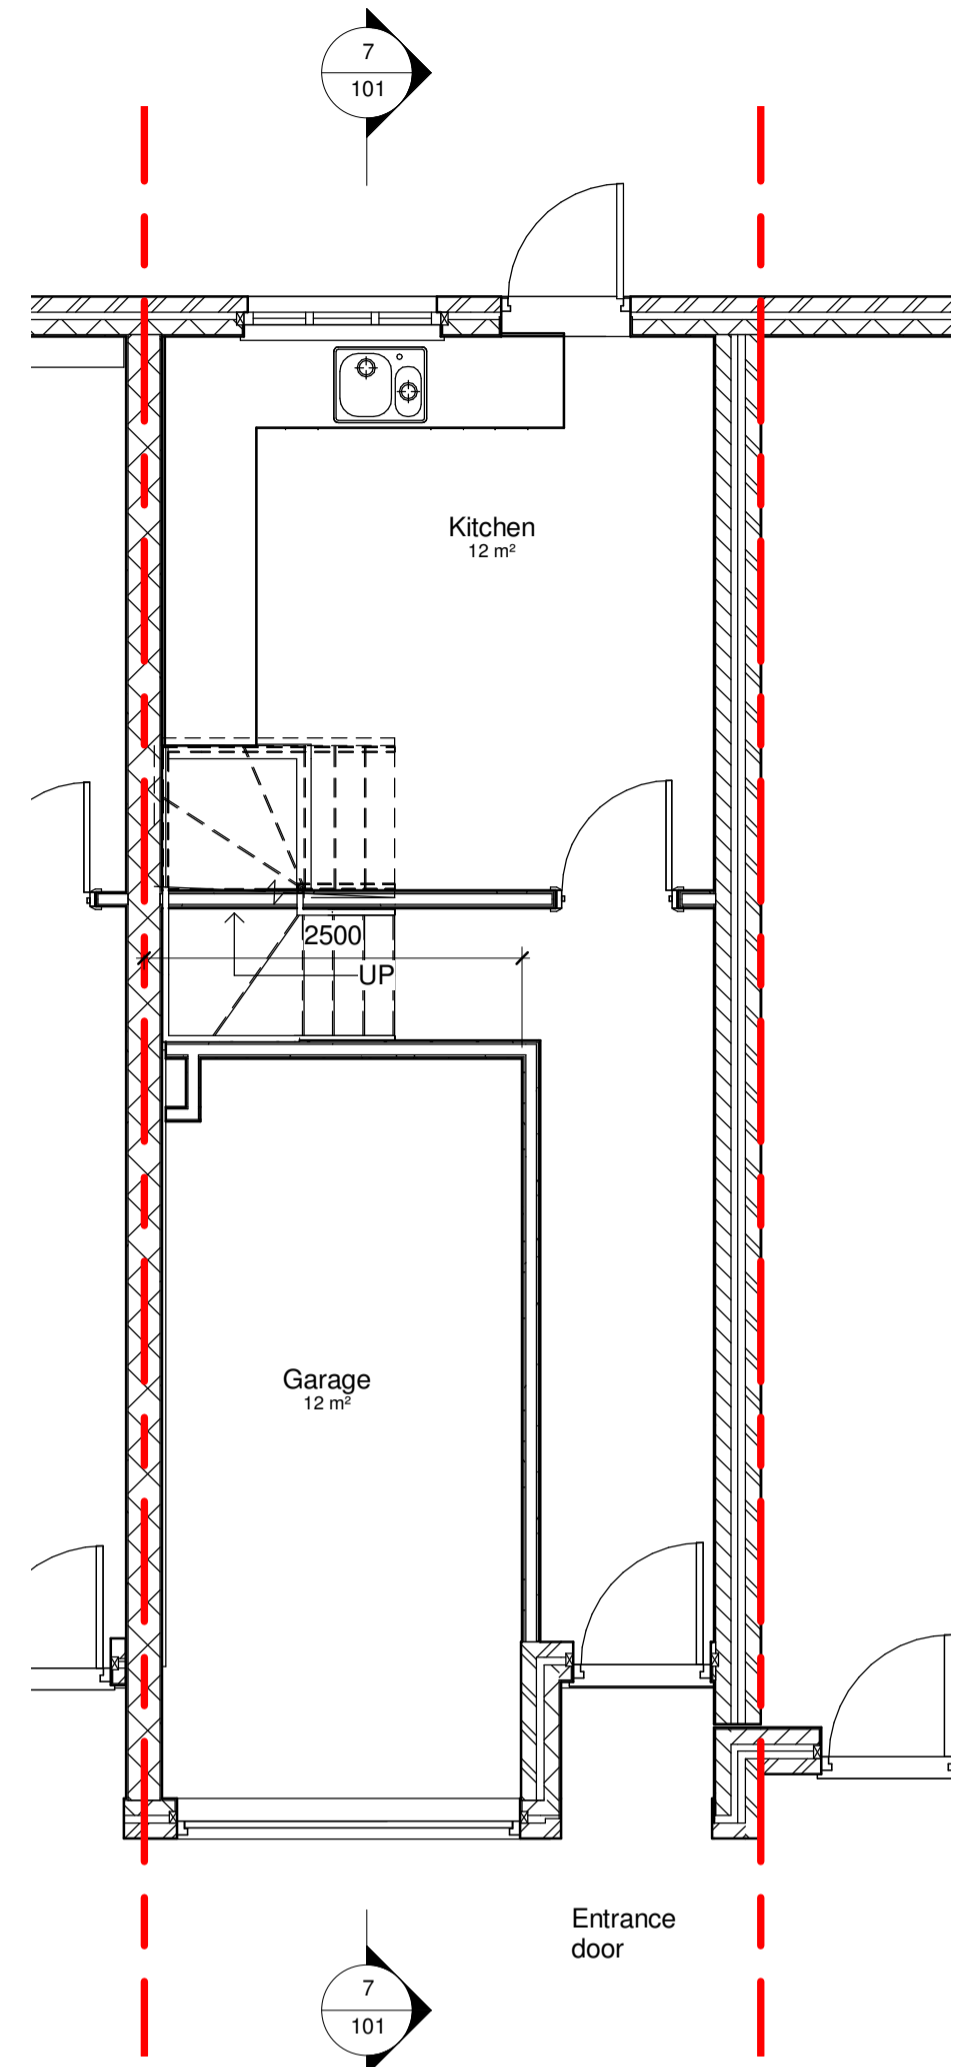


1 00 Existing Ground Floor
1 : 50

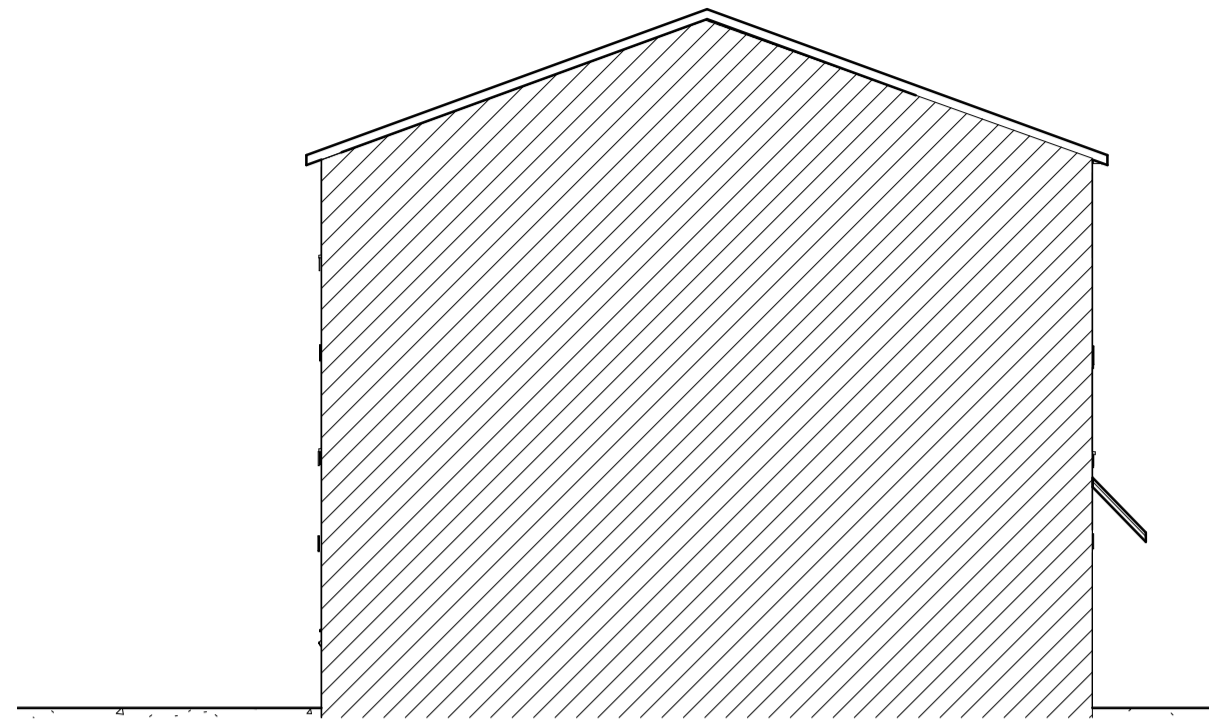

6 Existing Party Wall Elevation
1 : 100

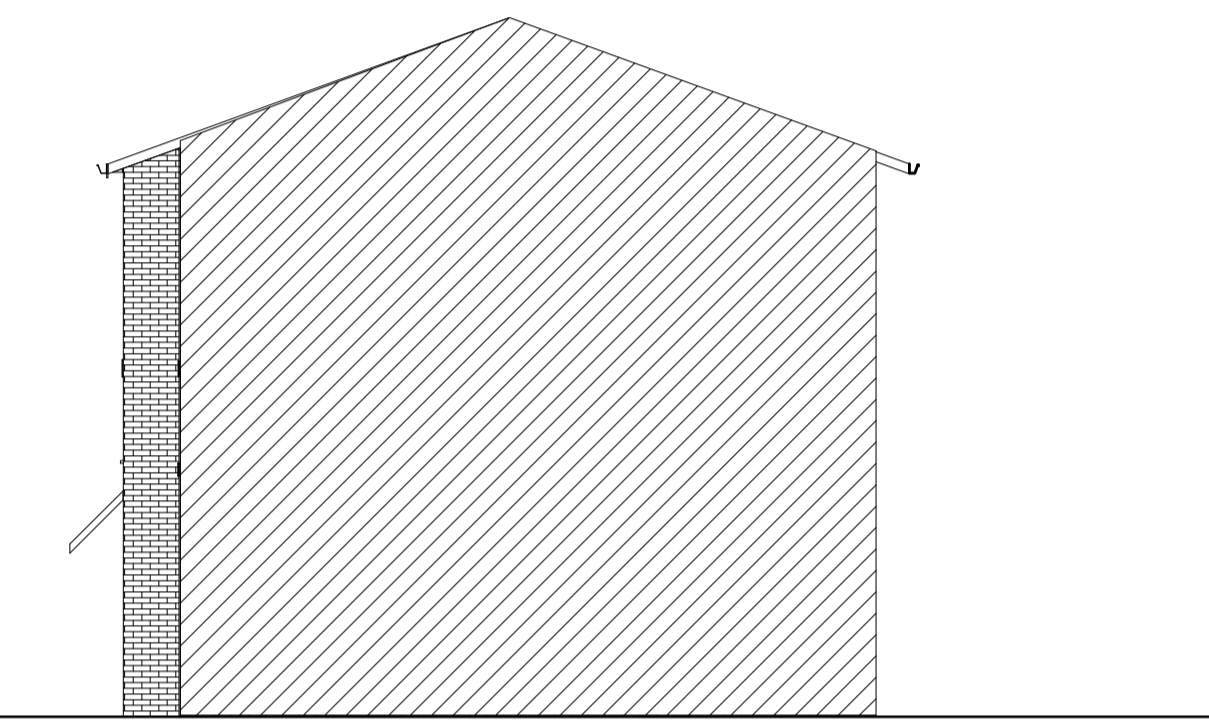


5 Existing Flank Elevation
1 : 100

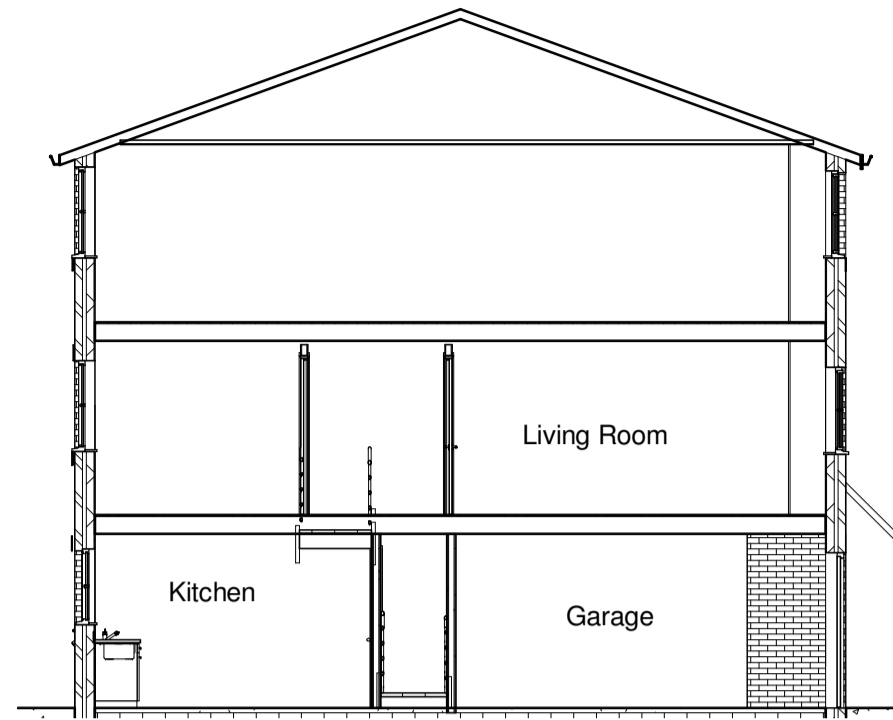



7 Section 1
1 : 100




VISUAL SCALE 1:100 @ A1

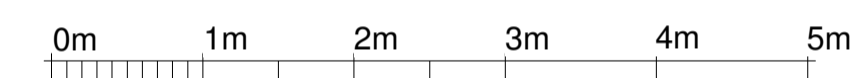


VISUAL SCALE 1:50 @ A1

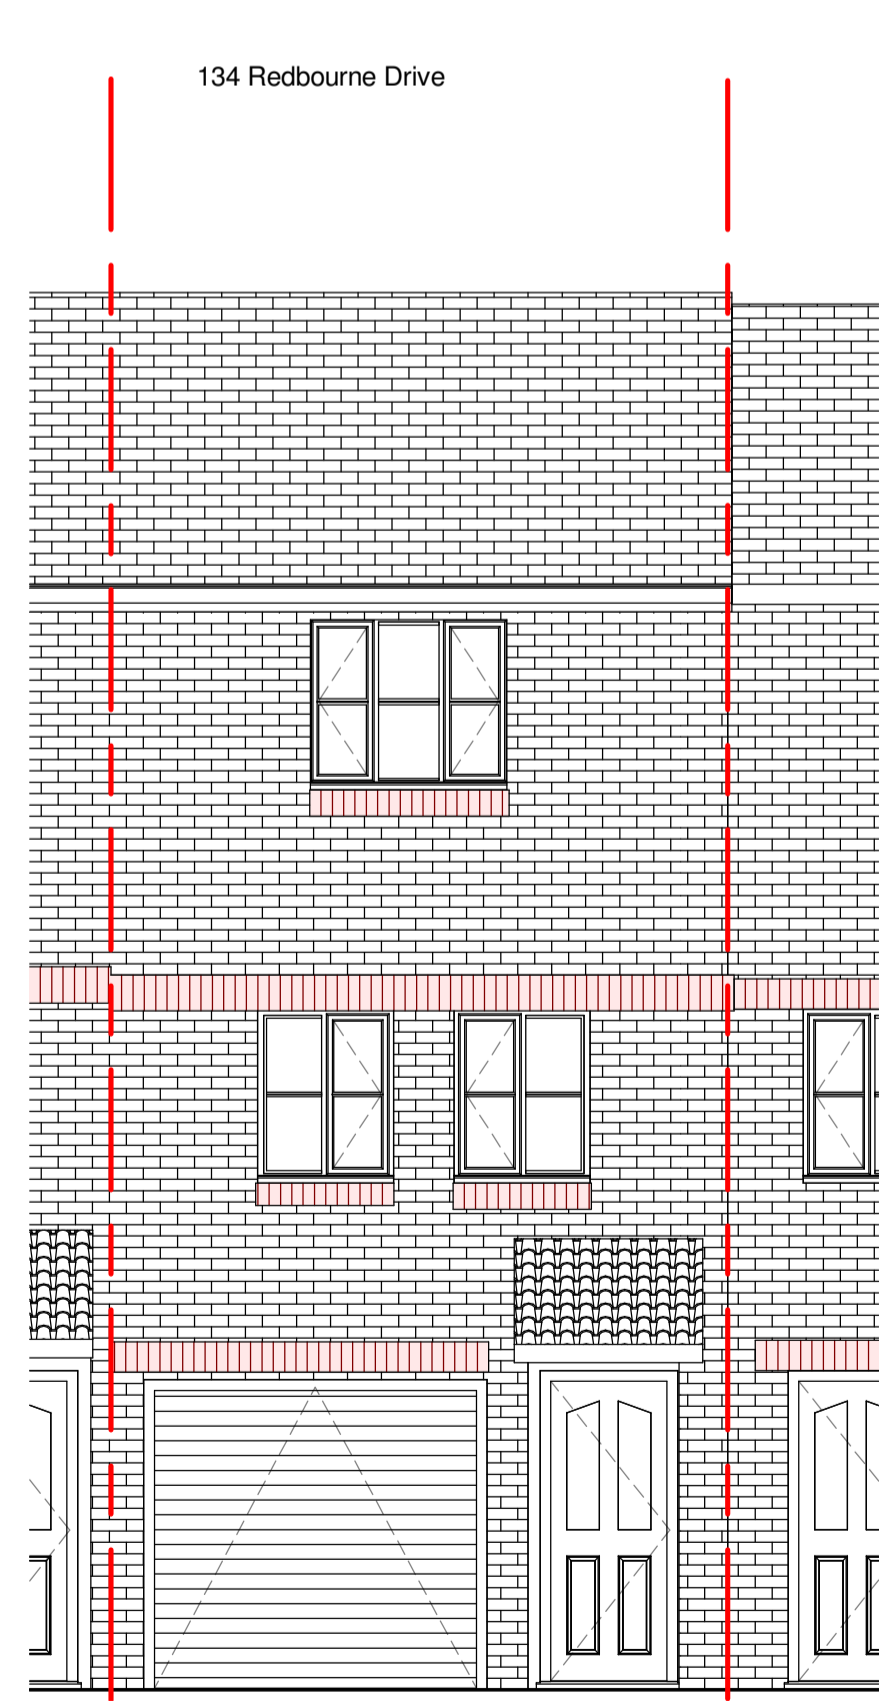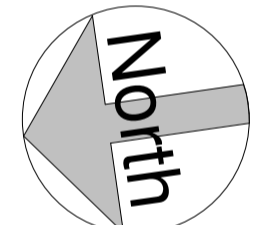

3 Existing Front Elevation
1 : 50

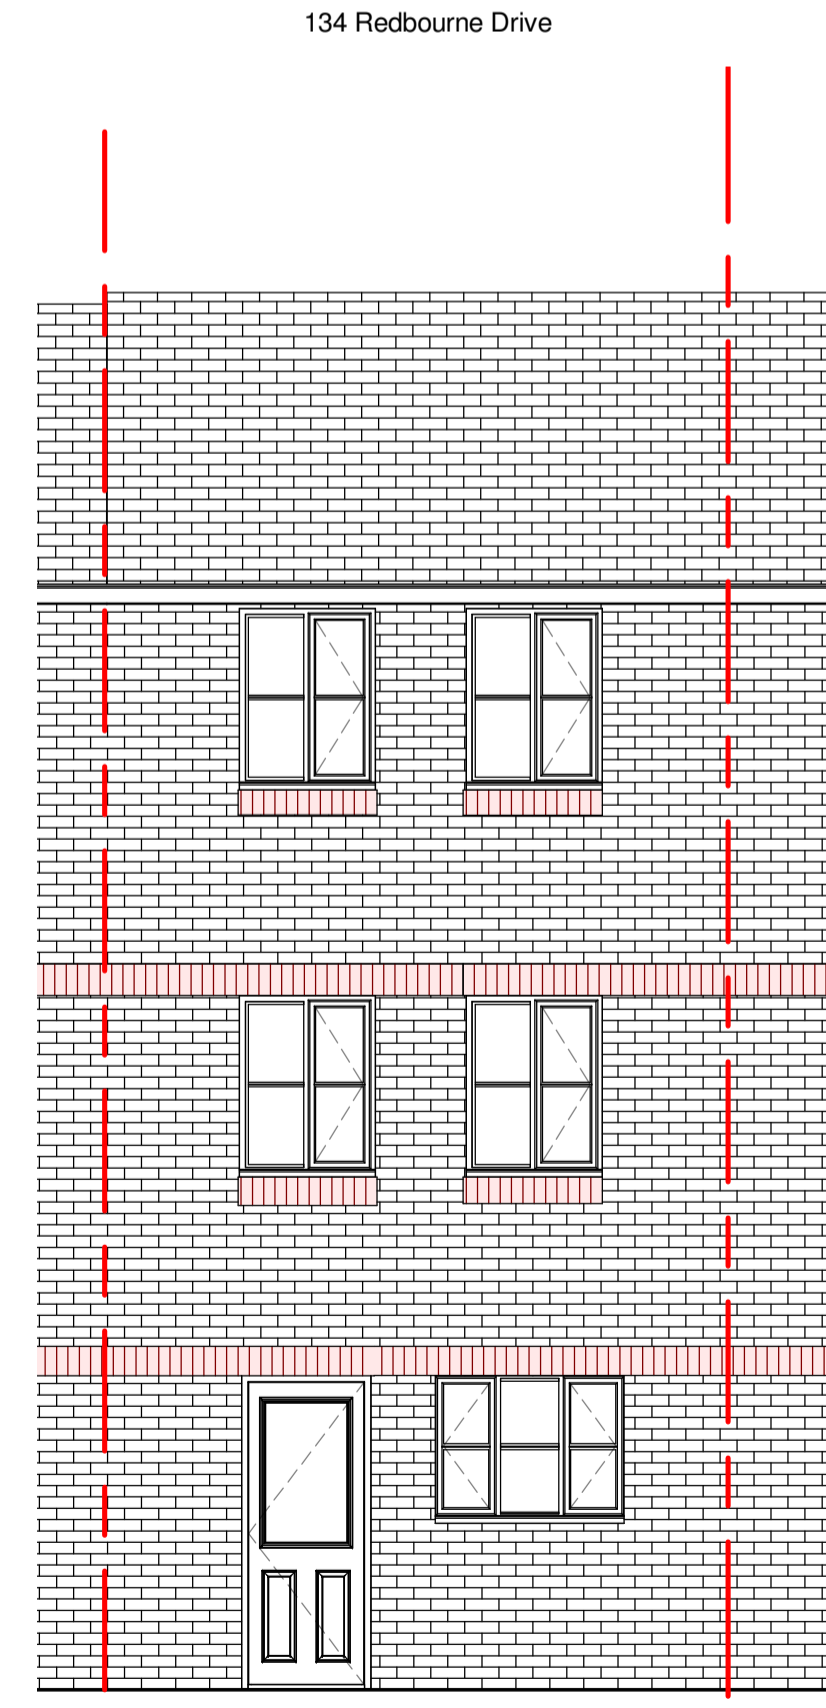

4 Existing Rear Elevation
1 : 50

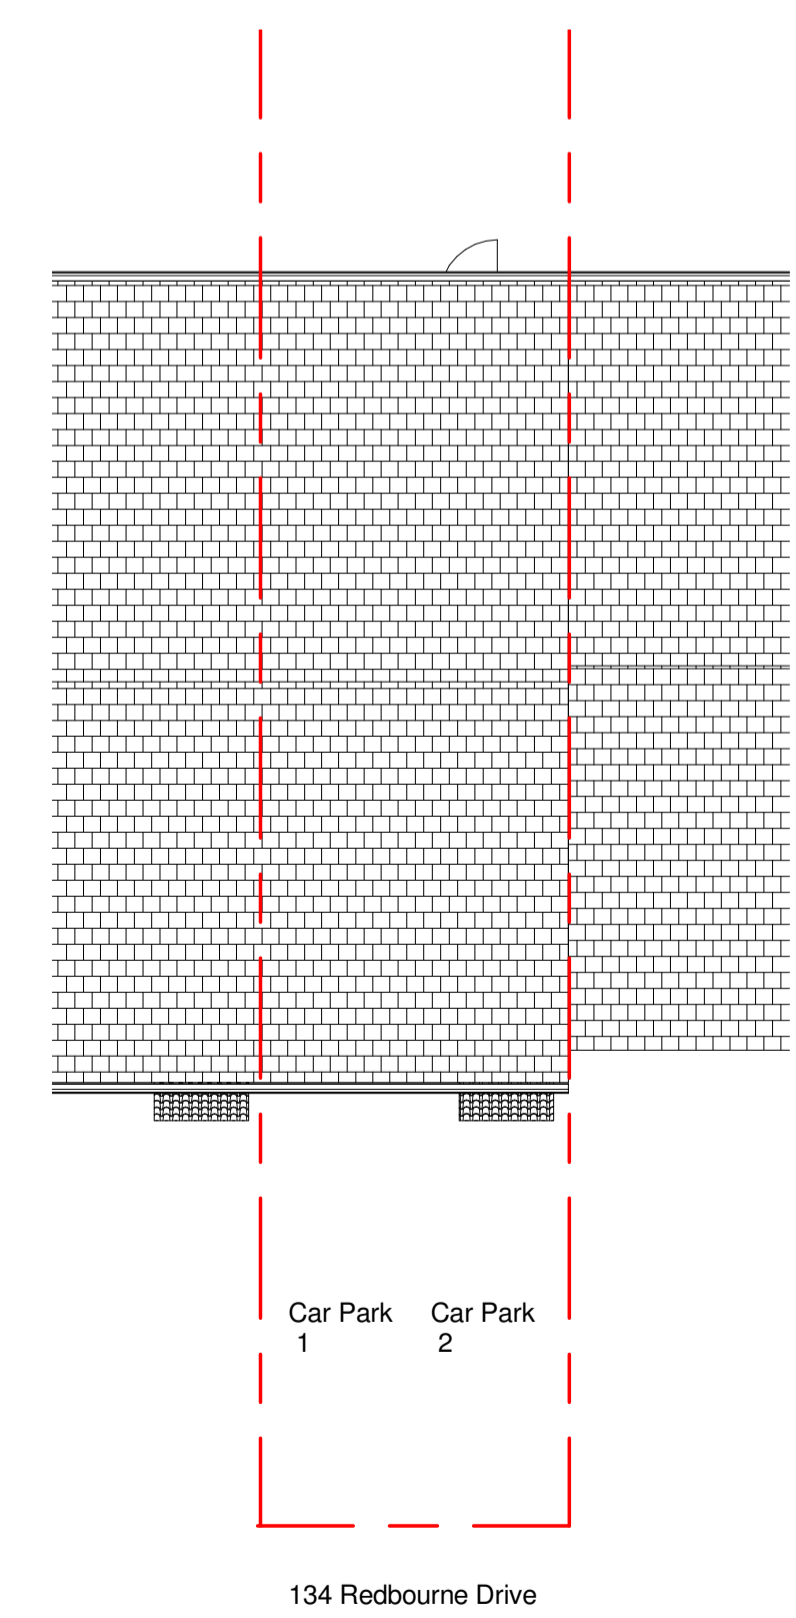

2 Roof Plan
1 : 100

Conversion of existing integrated garage into habitable room at 134 Redbourne Drive SE28 8RX

TITLE
Existing Plans and Elevations

CLIENT

DRAWN BY: Ivar Selter
CHECKED BY: IS
DATE: 15/03/2024

SCALE (@ A1): As indicated
PROJECT NUMBER: 134REDB/24

DRAWING NUMBER: 101
REV