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Mansard roof additional volume calculation: **Lower section of Mansard-Pitch 70 degrees** Mansard length=7.670m Projection at knuckle=1.175m Rafter length, wallplate to knuckle=2.056m

Volume calc=7.670x2.056x1.175=18.530/2=9.264cu m


Upper section of Mansard-Pitch 22 degrees Mansard length=7.670m Projection at knuckle=1.175m Rafter length, wallplate to knuckle=2.784m Volume calc=7.670x2.784x1.175=25.090/2=12.545cu m


Therefore additional volume added to existing roof=9.264+12.545=21.809cu m per side


Total additional volume=21.809x2 sides=43.618cu m


Allowance=50cu m

Therefore proposed increase=87.23% of allowance

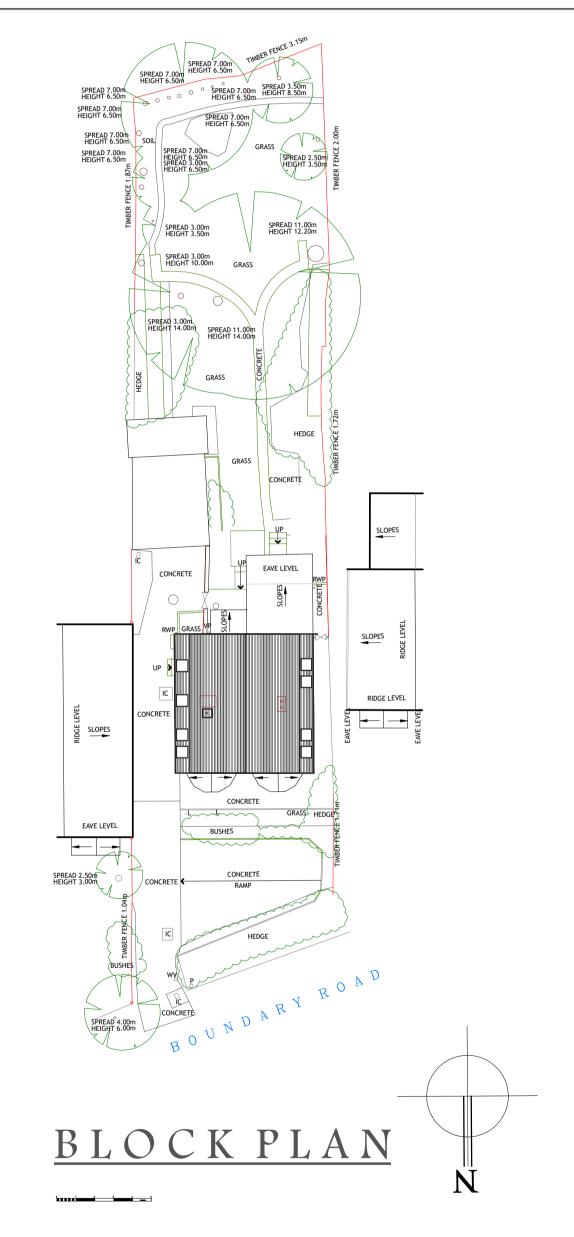

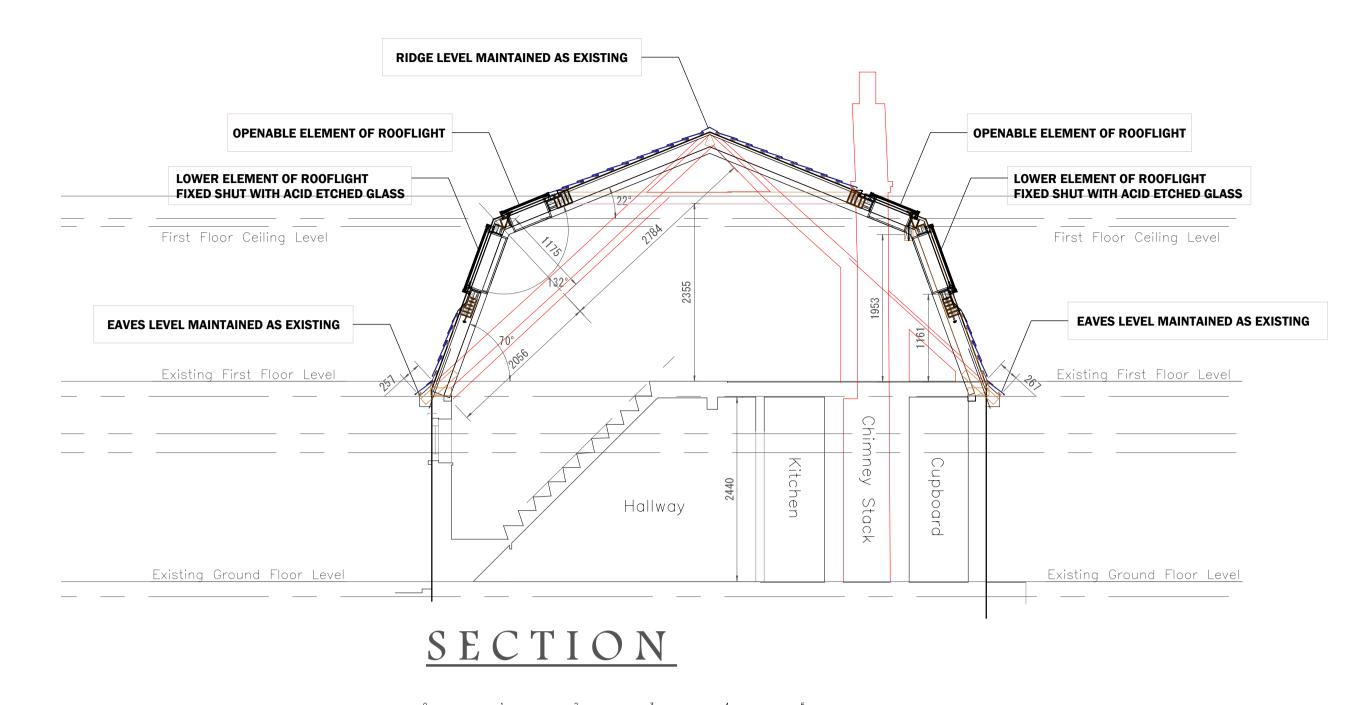

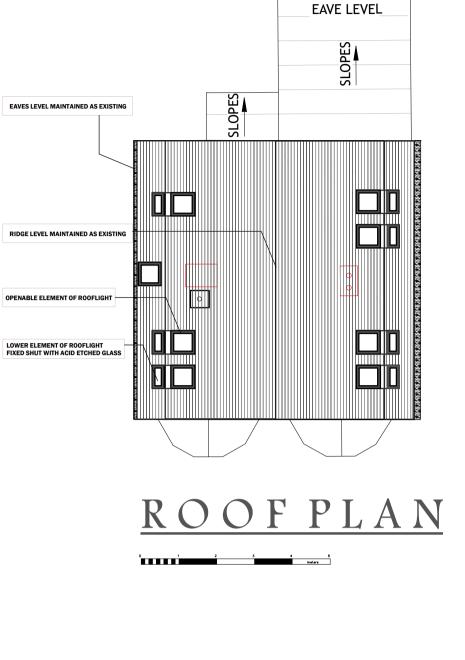

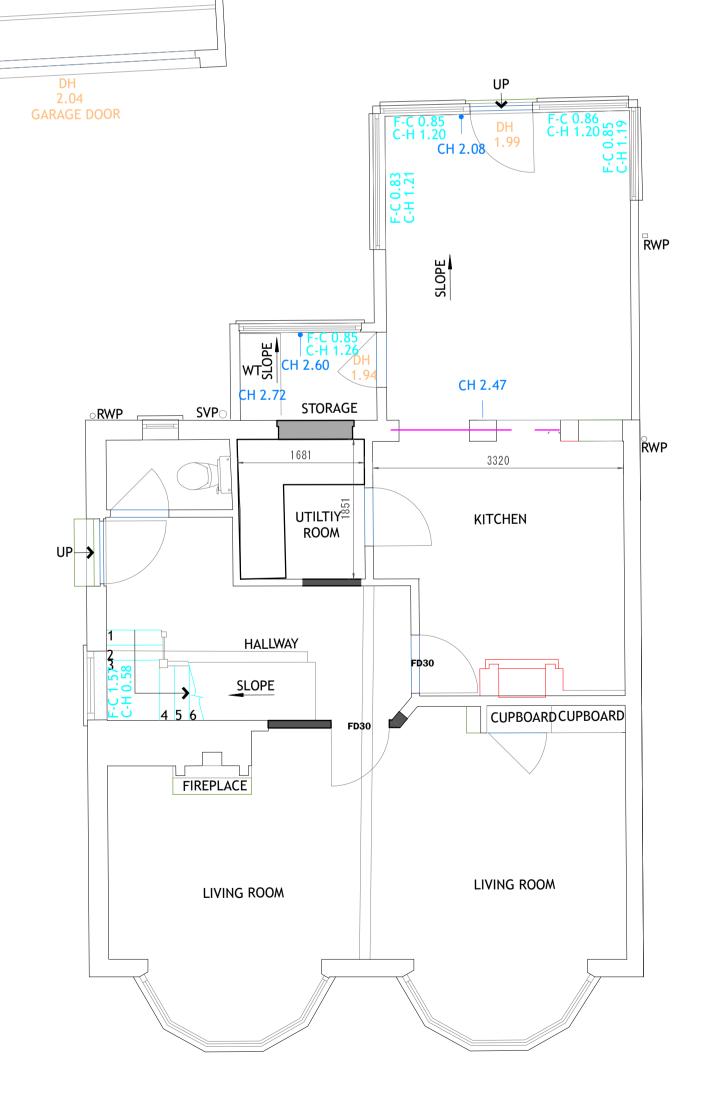

GARAGE

SLOPE

SLOPE

FIRST FLOOR PLAN

SPIXED SHUT
OBSCURE GLAZED BEDROOM 1 7 8 9 1011121314 BEDROOM 2 BEDROOM :

PROPOSED LAYOUTS

5 BOUNDARY ROAD,

BISHOP'S STORTFORD,

Project title:

HERTS

Drawing title:

CM23 5LE

Date: FEB 2022	Project No:	596
Scale: 1 : 50/1 : 100 & 1 : 200 @ A1	Drawing No:	001E



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GROUND FLOOR PLAN