





Location Plan (Scale - 1:1250)

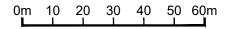

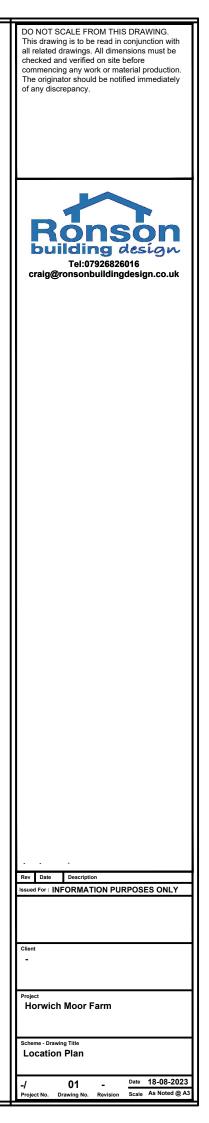





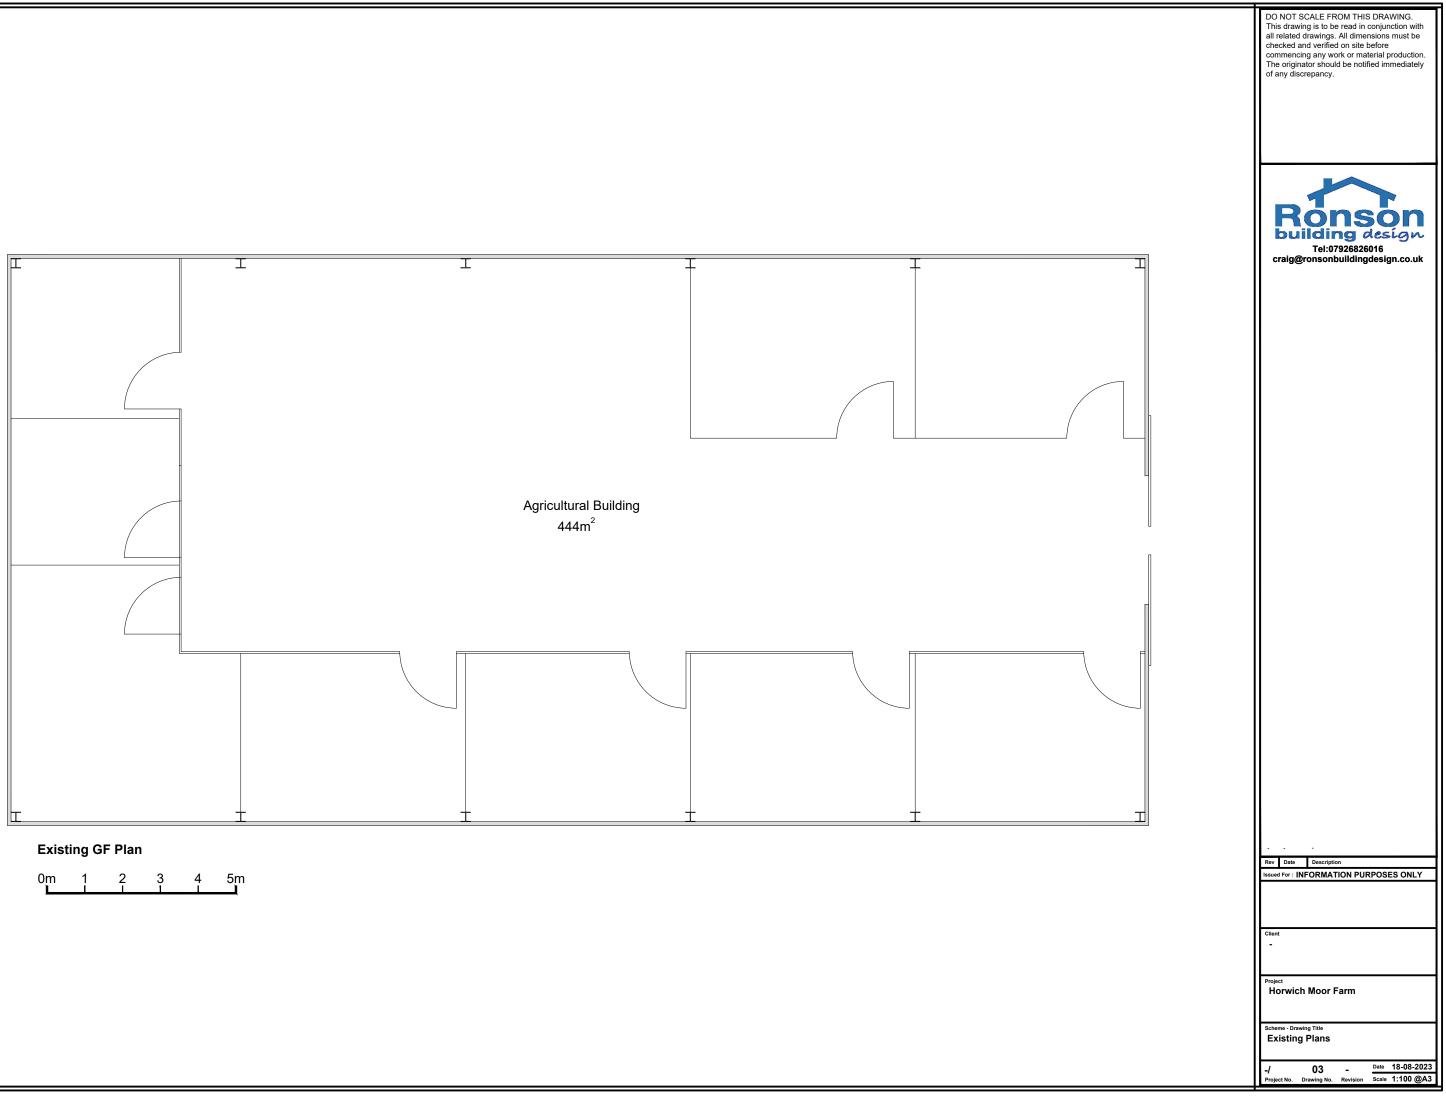

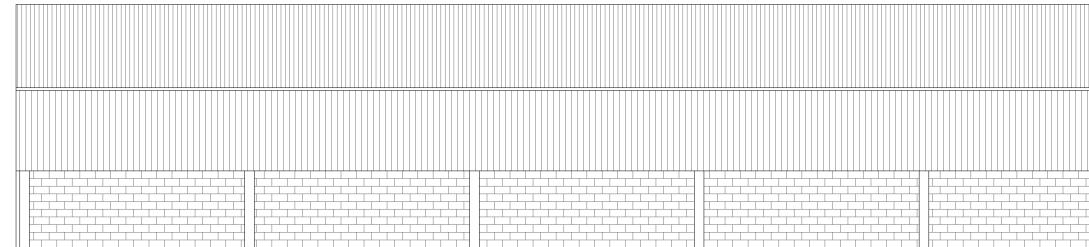


Front Elevation

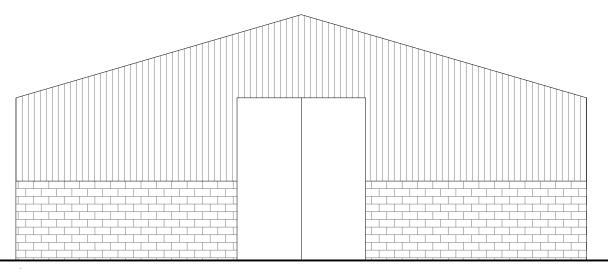


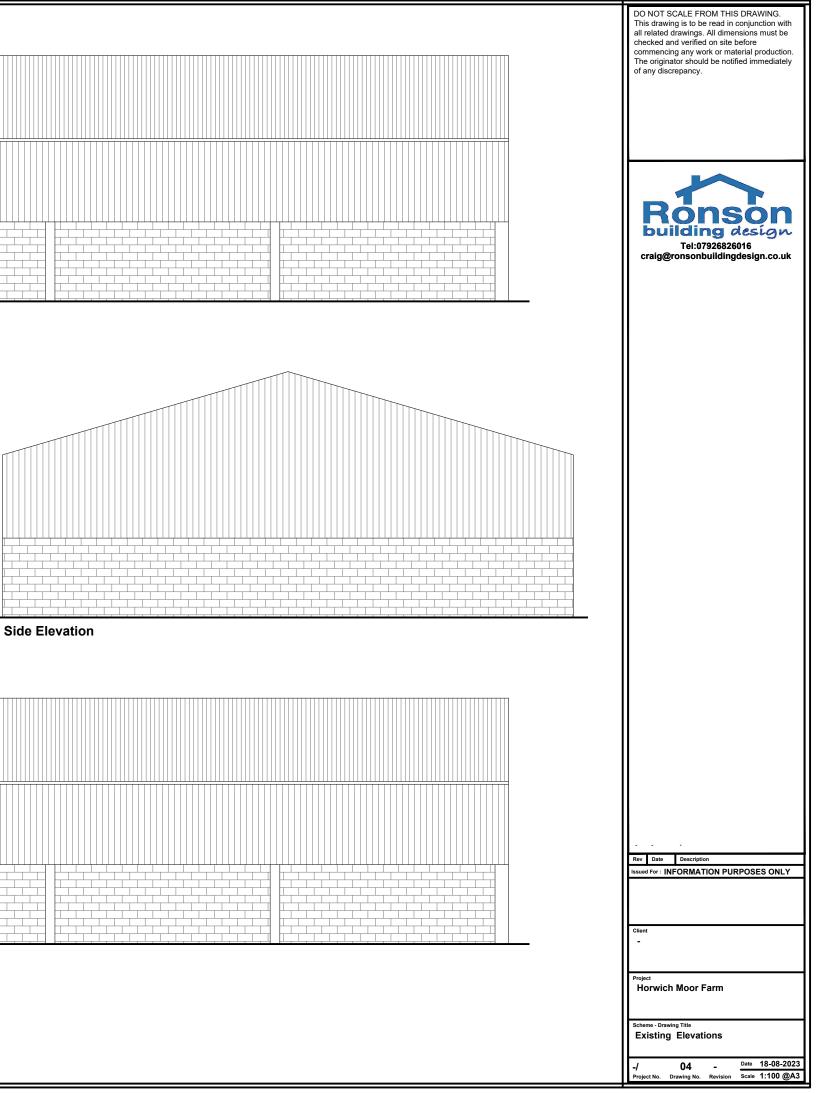


Side Elevation

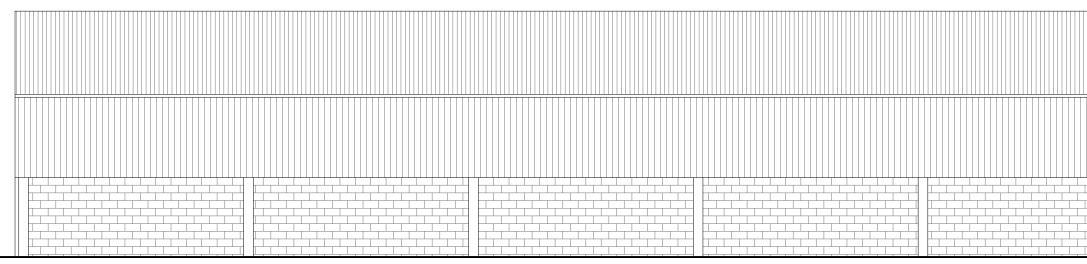

Rear Elevation

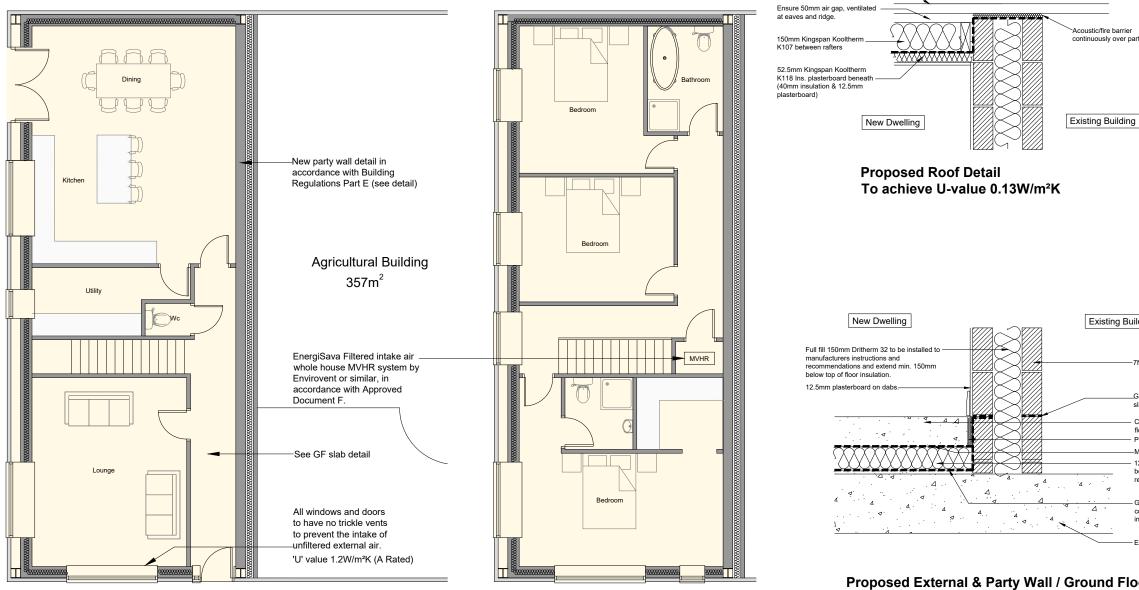



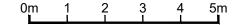





Proposed External & Party Wall / Ground Flo To achieve: U-value 0.17W/m²K Airborne Sound insulation - 45 DnT,w ·

Ensure existing roof cladding is ingood condition

	DO NOT SCALE FROM THIS DRAWING. This drawing is to be read in conjunction with all related drawings. All dimensions must be checked and verified on site before commencing any work or material production. The originator should be notified immediately of any discrepancy.
	Ronson Building design. Tel:07926826016 craig@ronsonbuildingdesign.co.uk
arty wall	
3	
ilding	
7N block to inner and outer leaf Gas proof membrane turned up around edge of	
Sab and lapped under D.P.C. Cast insitu concrete ground floor slab with power float finish. Perimeter insulation min. R-value of 0.75m ² K/W. Min. 500 Gauge visqueen on insulation to lap over DPC 120mm Floor slab insulation as per specification to be installed to manufacturers instructions and recommendations and must tightly abut blockwork.	
Gas proof membrane on Sand or weak mix concrete blinding,to be installed to manufacturers instructions and recommendations.	
Existing concrete slab	
oor Detail	A 20-03-24 Planning Re-submission
+ Ctr dB	Issued For : INFORMATION PURPOSES ONLY
	Client -
	Project Horwich Moor Farm
	Scheme - Drawing Title Proposed Plans
	-/ 05 A Date 18-08-2023 Project No. Drawing No. Revision Scale 1:50 @A3

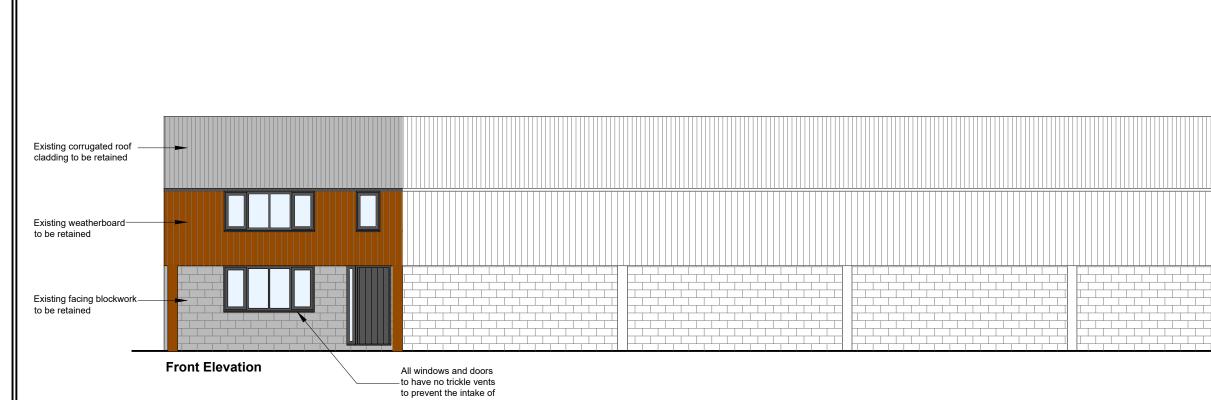

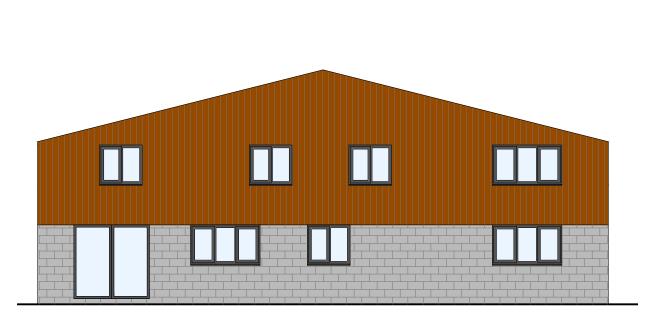



unfiltered external air. 'U' value 1.2W/m²K (A Rated)



