




**PROPOSED GROUND FLOOR PLAN**  
Scale: 1:50

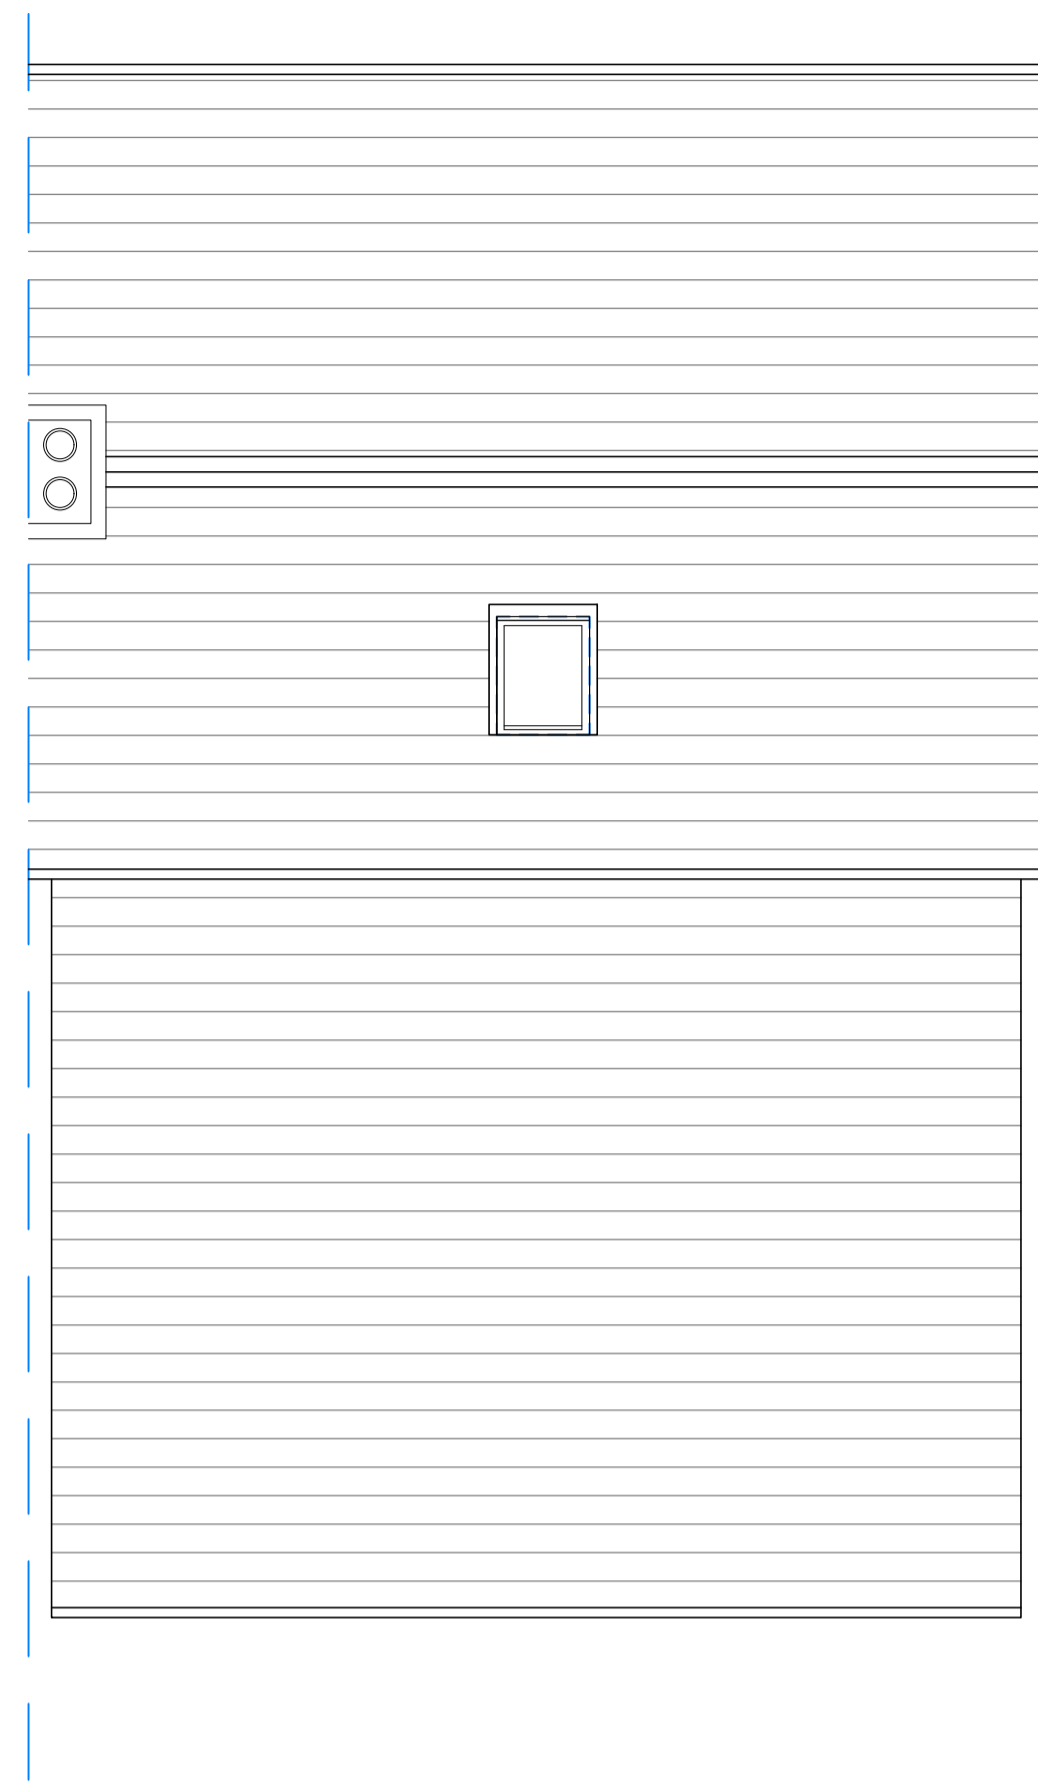


**PROPOSED FIRST FLOOR PLAN**  
Scale: 1:50

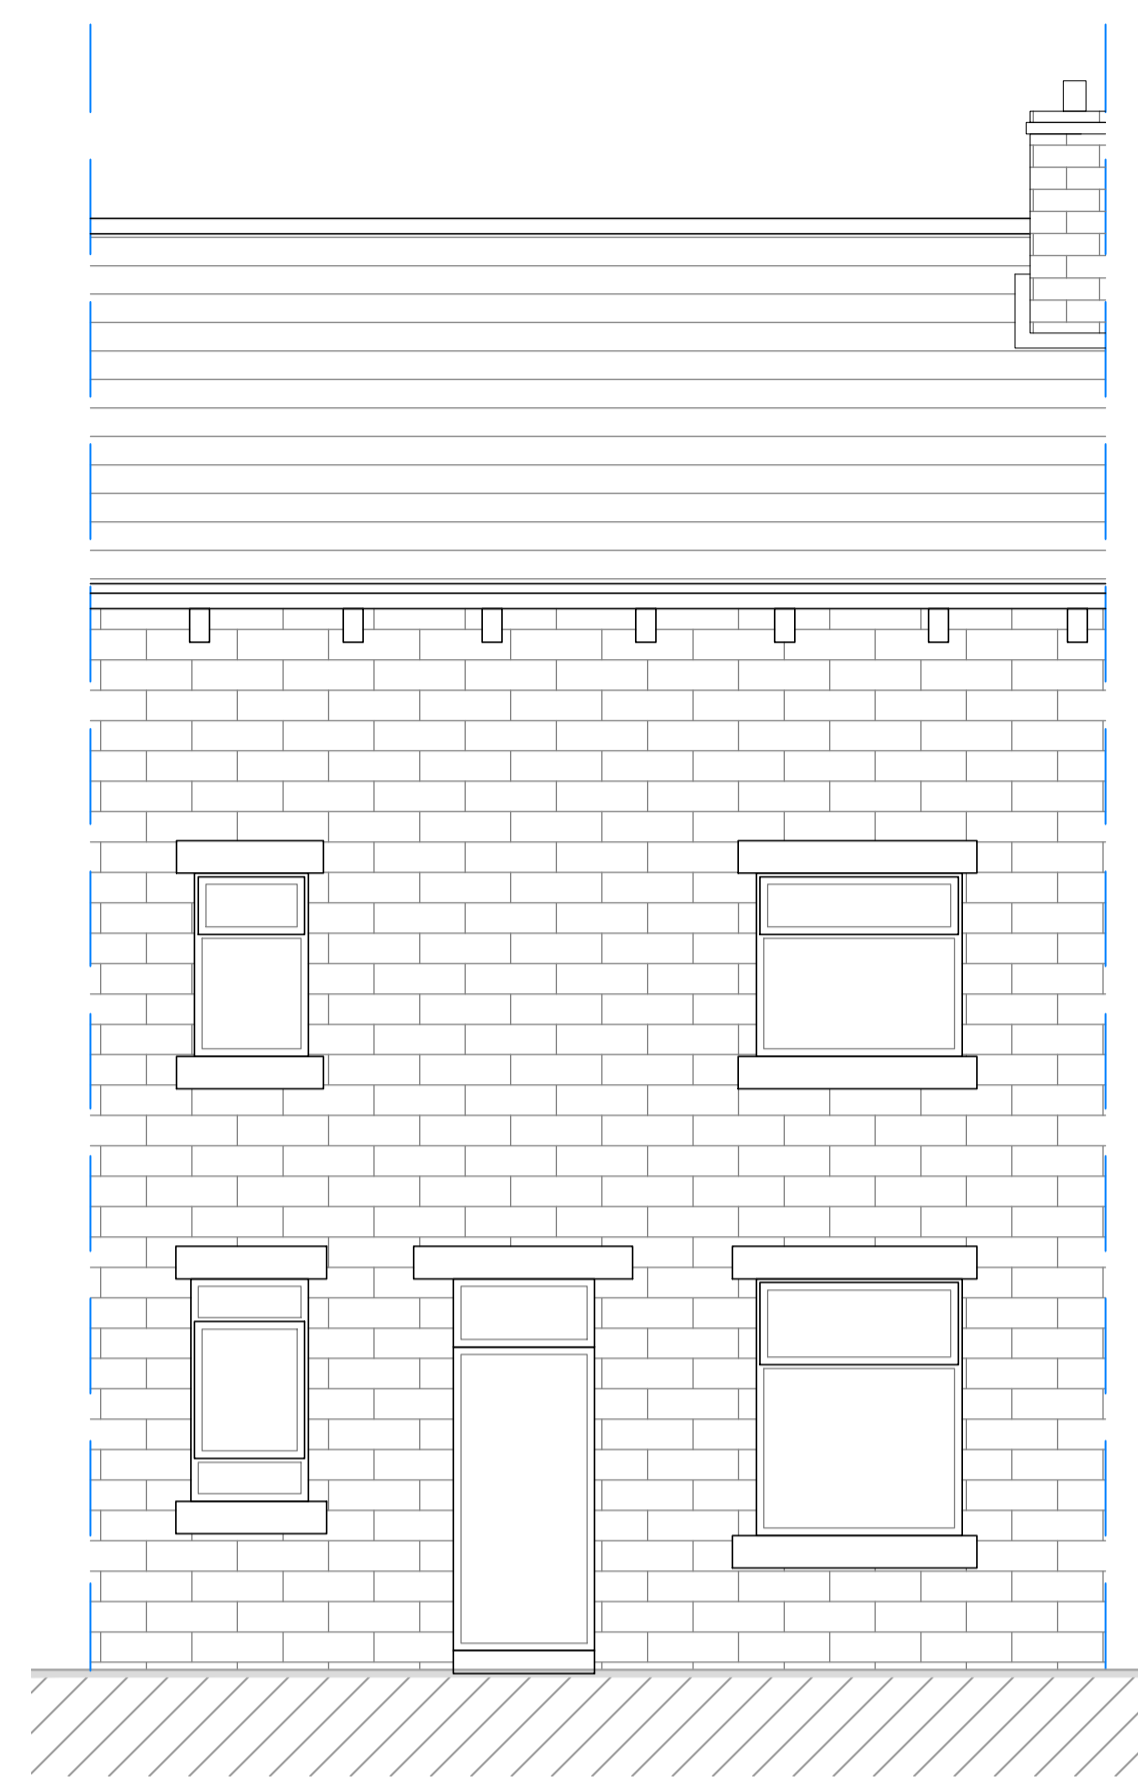


**PROPOSED FRONT ELEVATION**  
Scale: 1:50

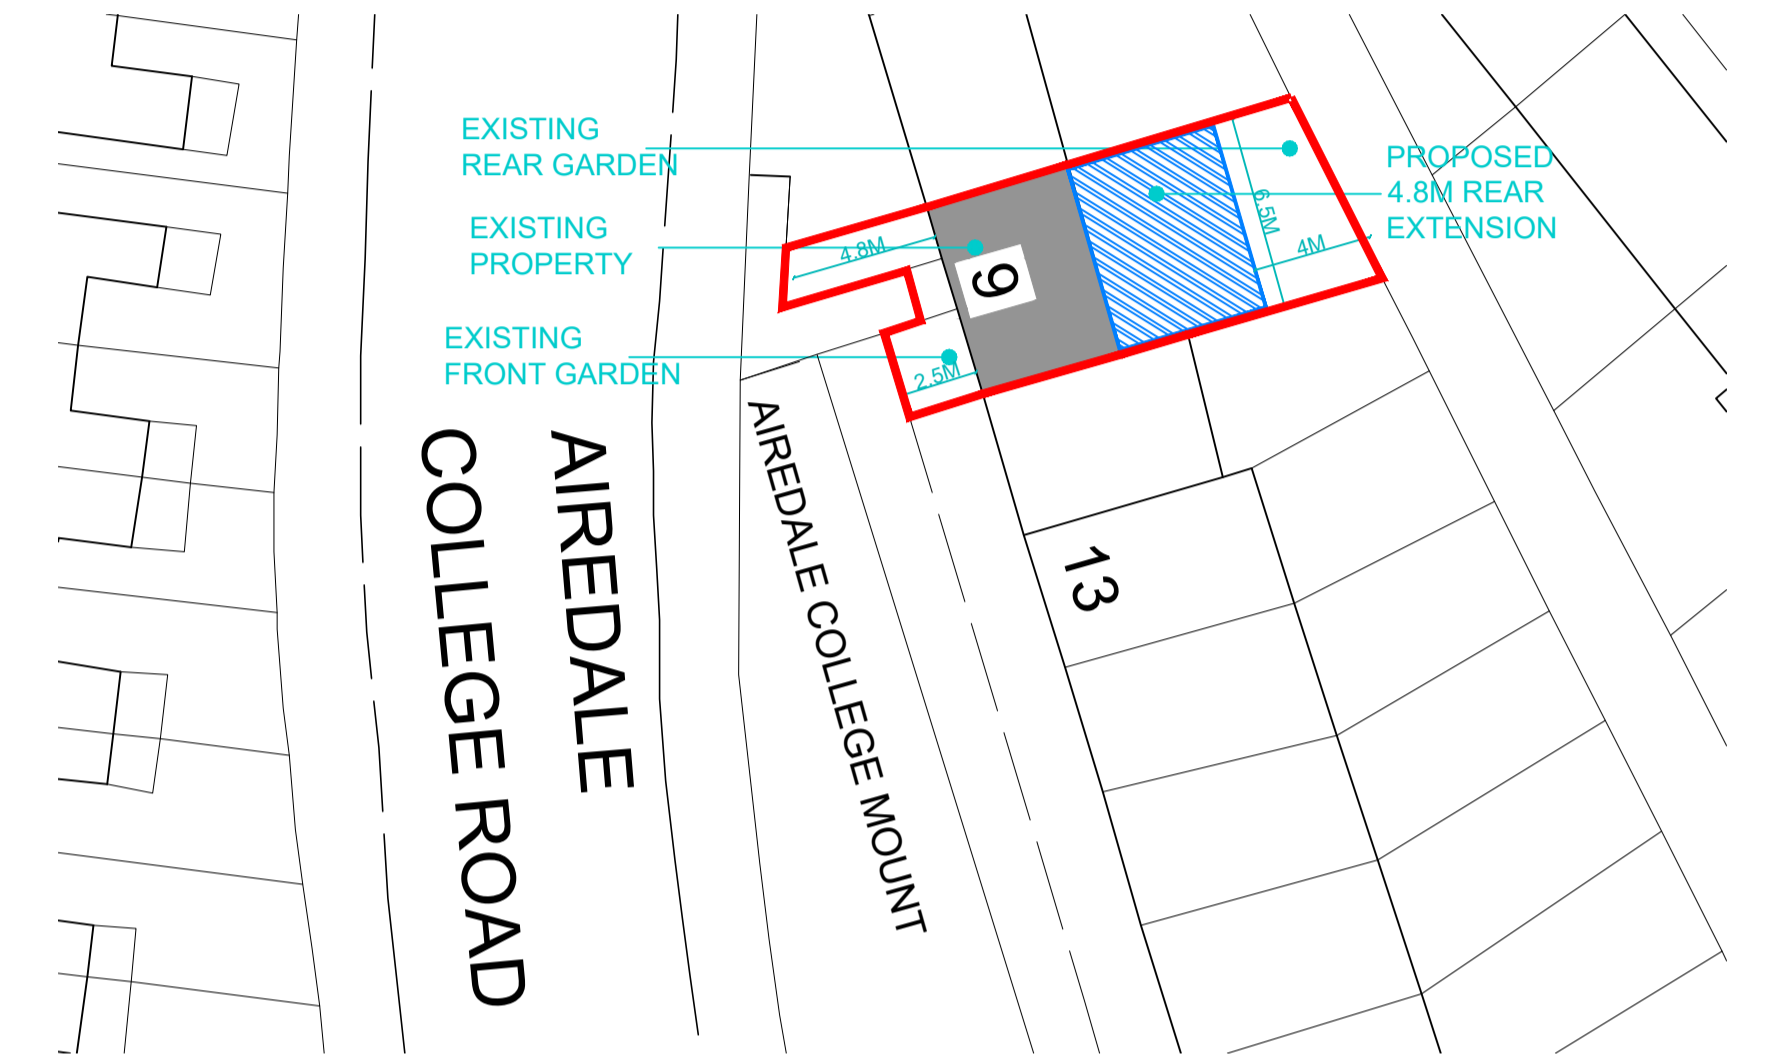


**PROPOSED SITE PLAN**  
Scale: 1:250

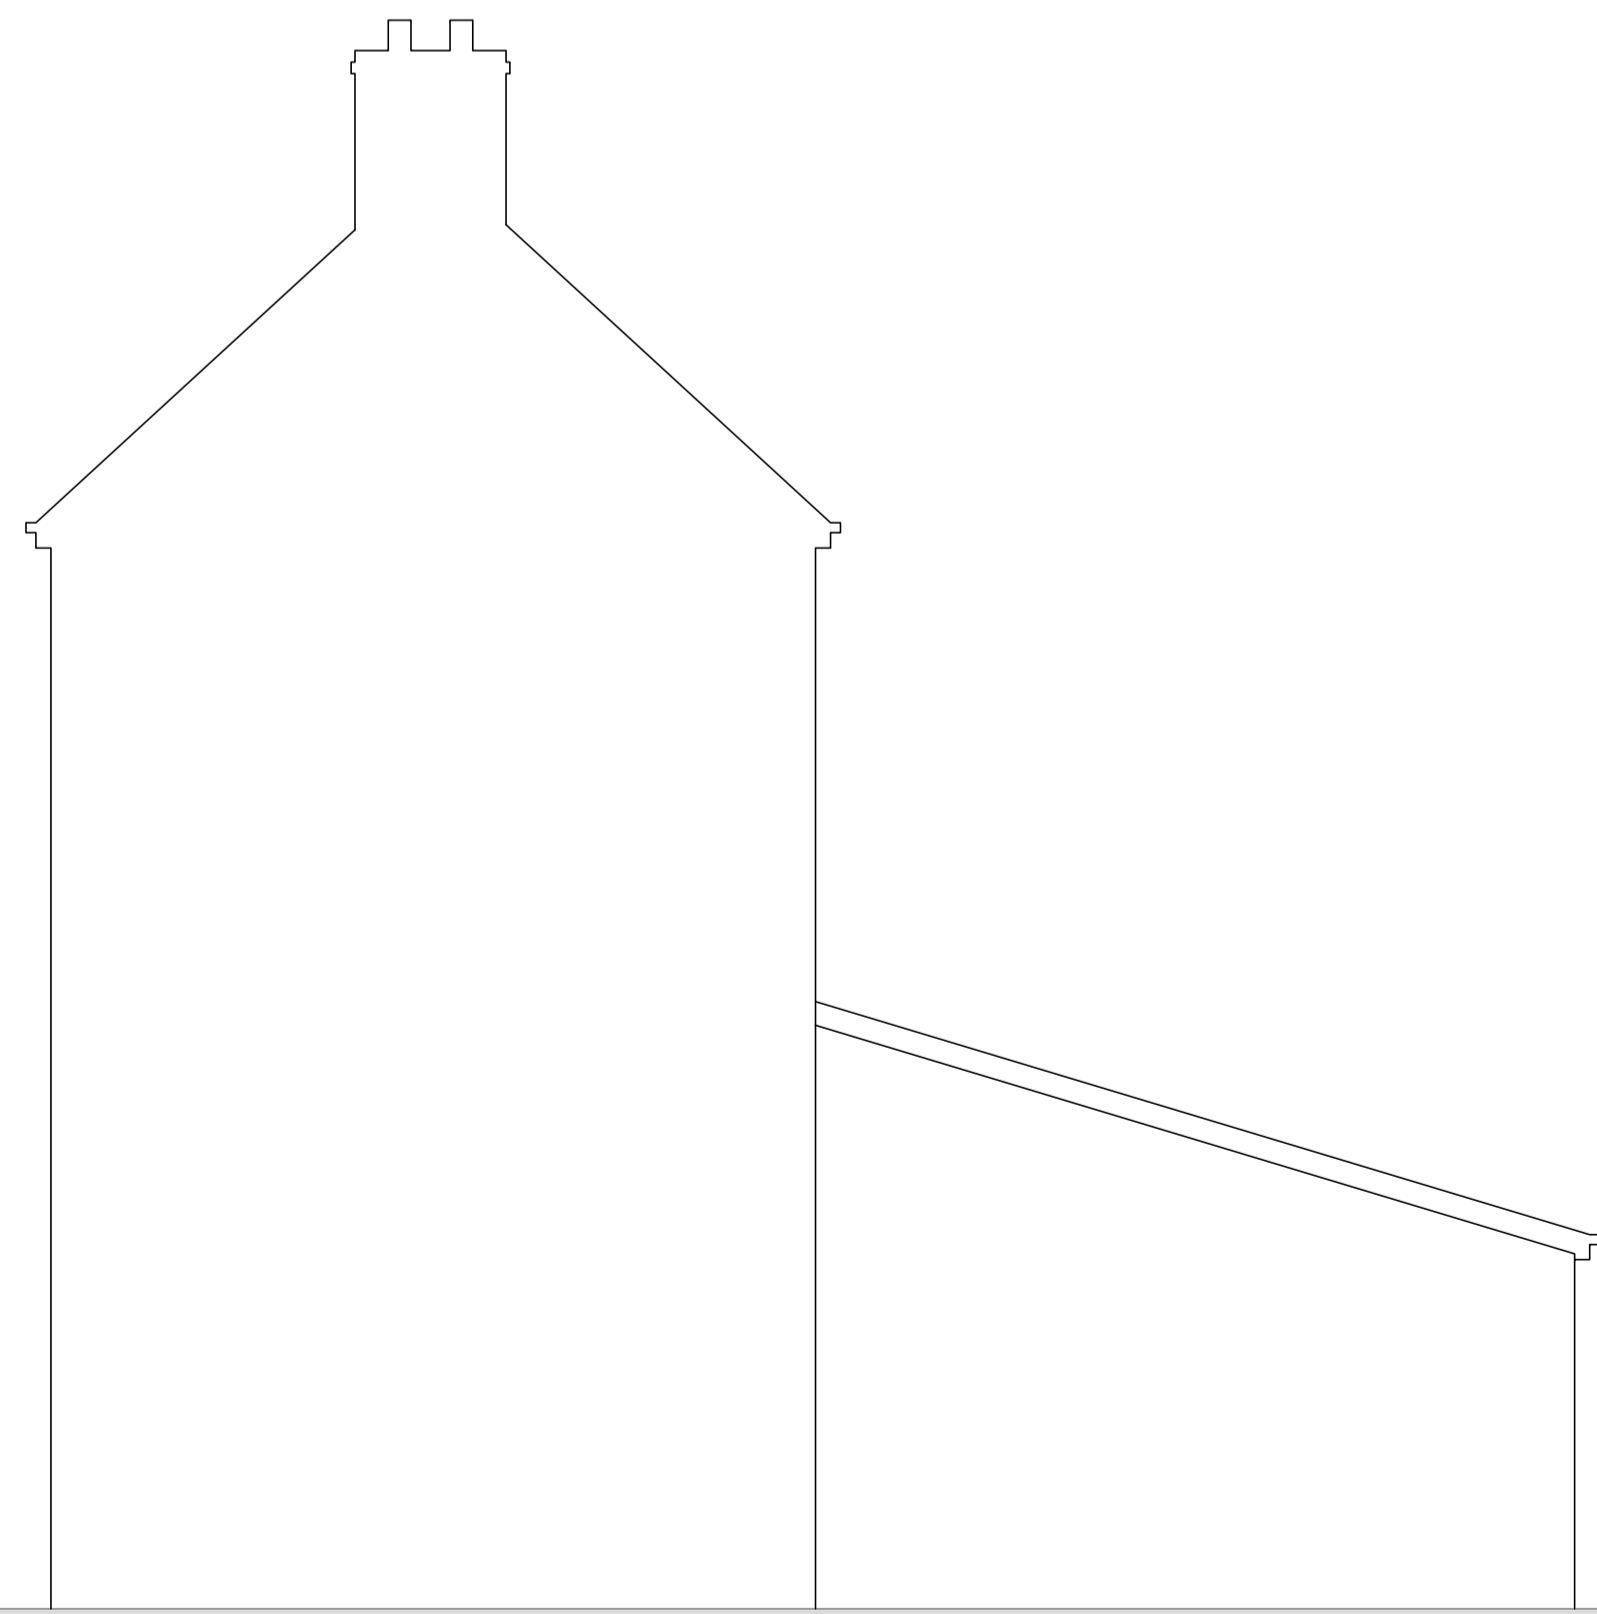

**PROPOSED SIDE ELEVATION**  
Scale: 1:50

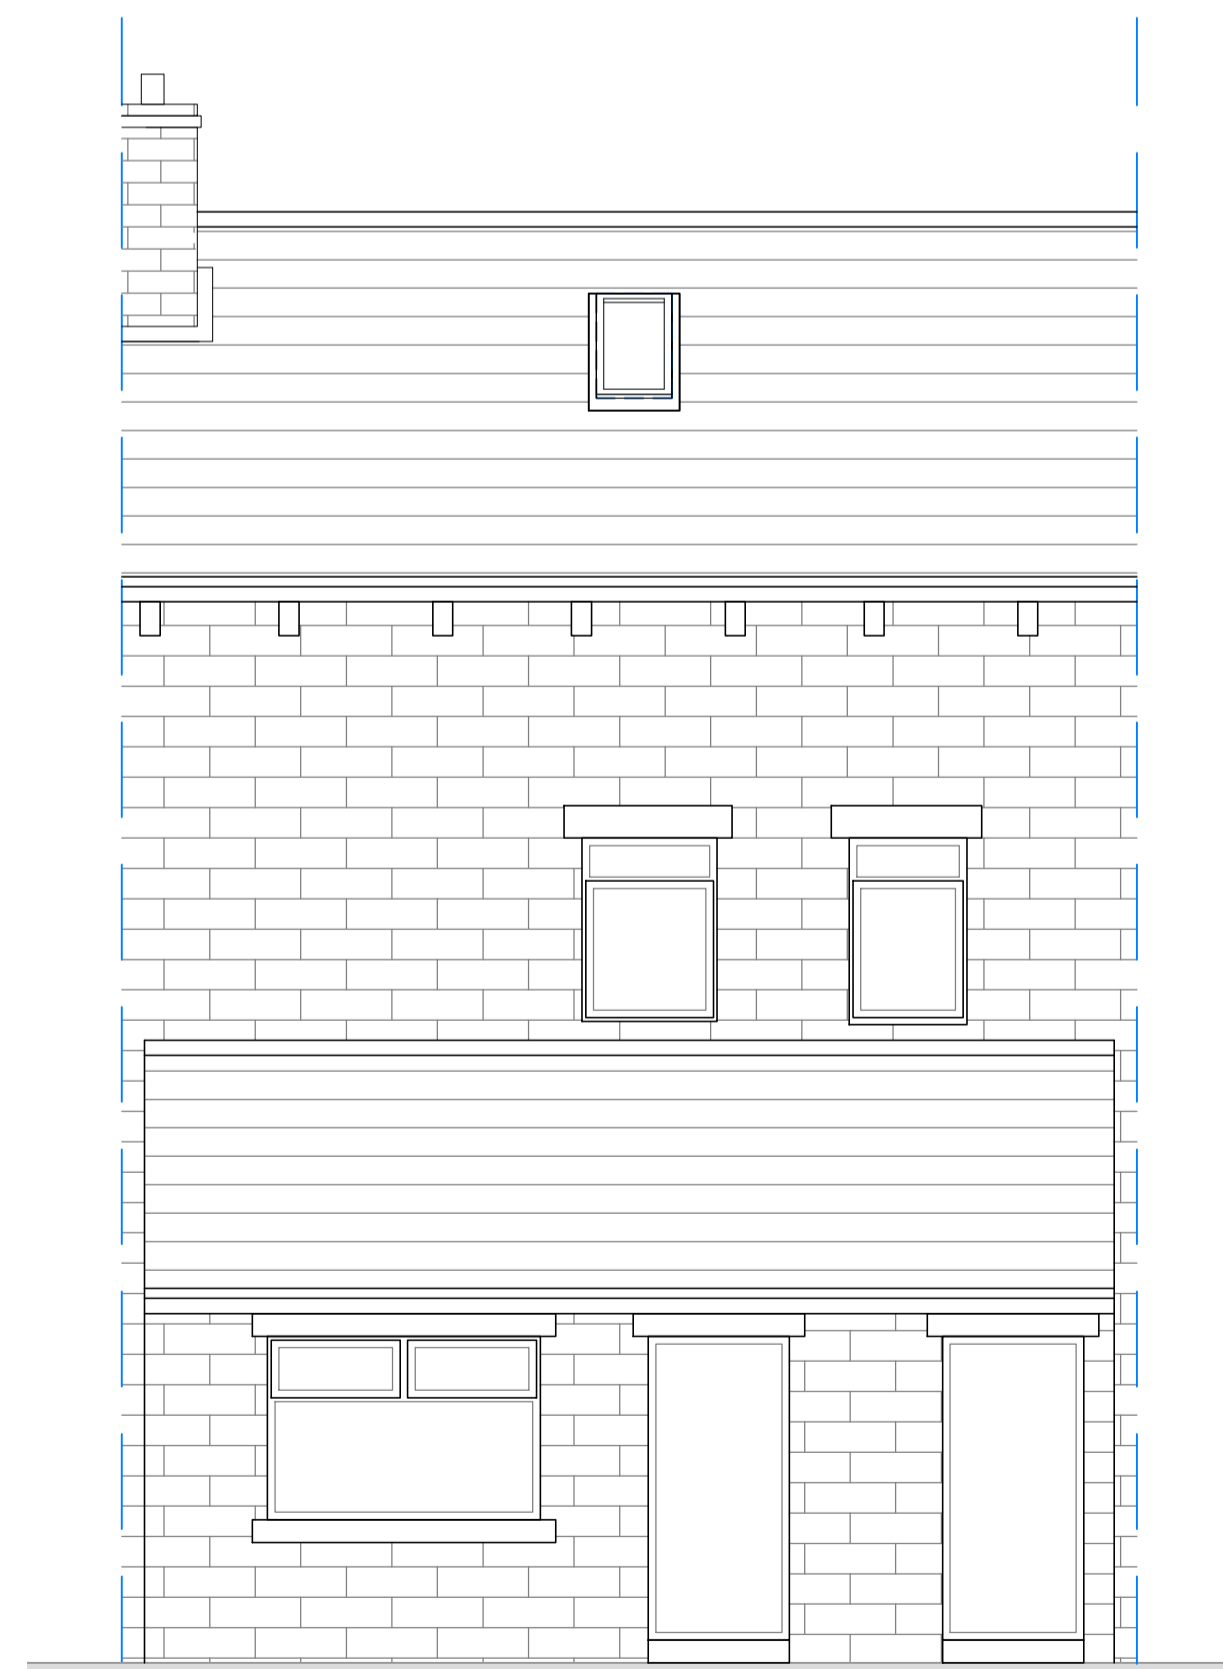


**PROPOSED REAR ELEVATION**  
Scale: 1:50

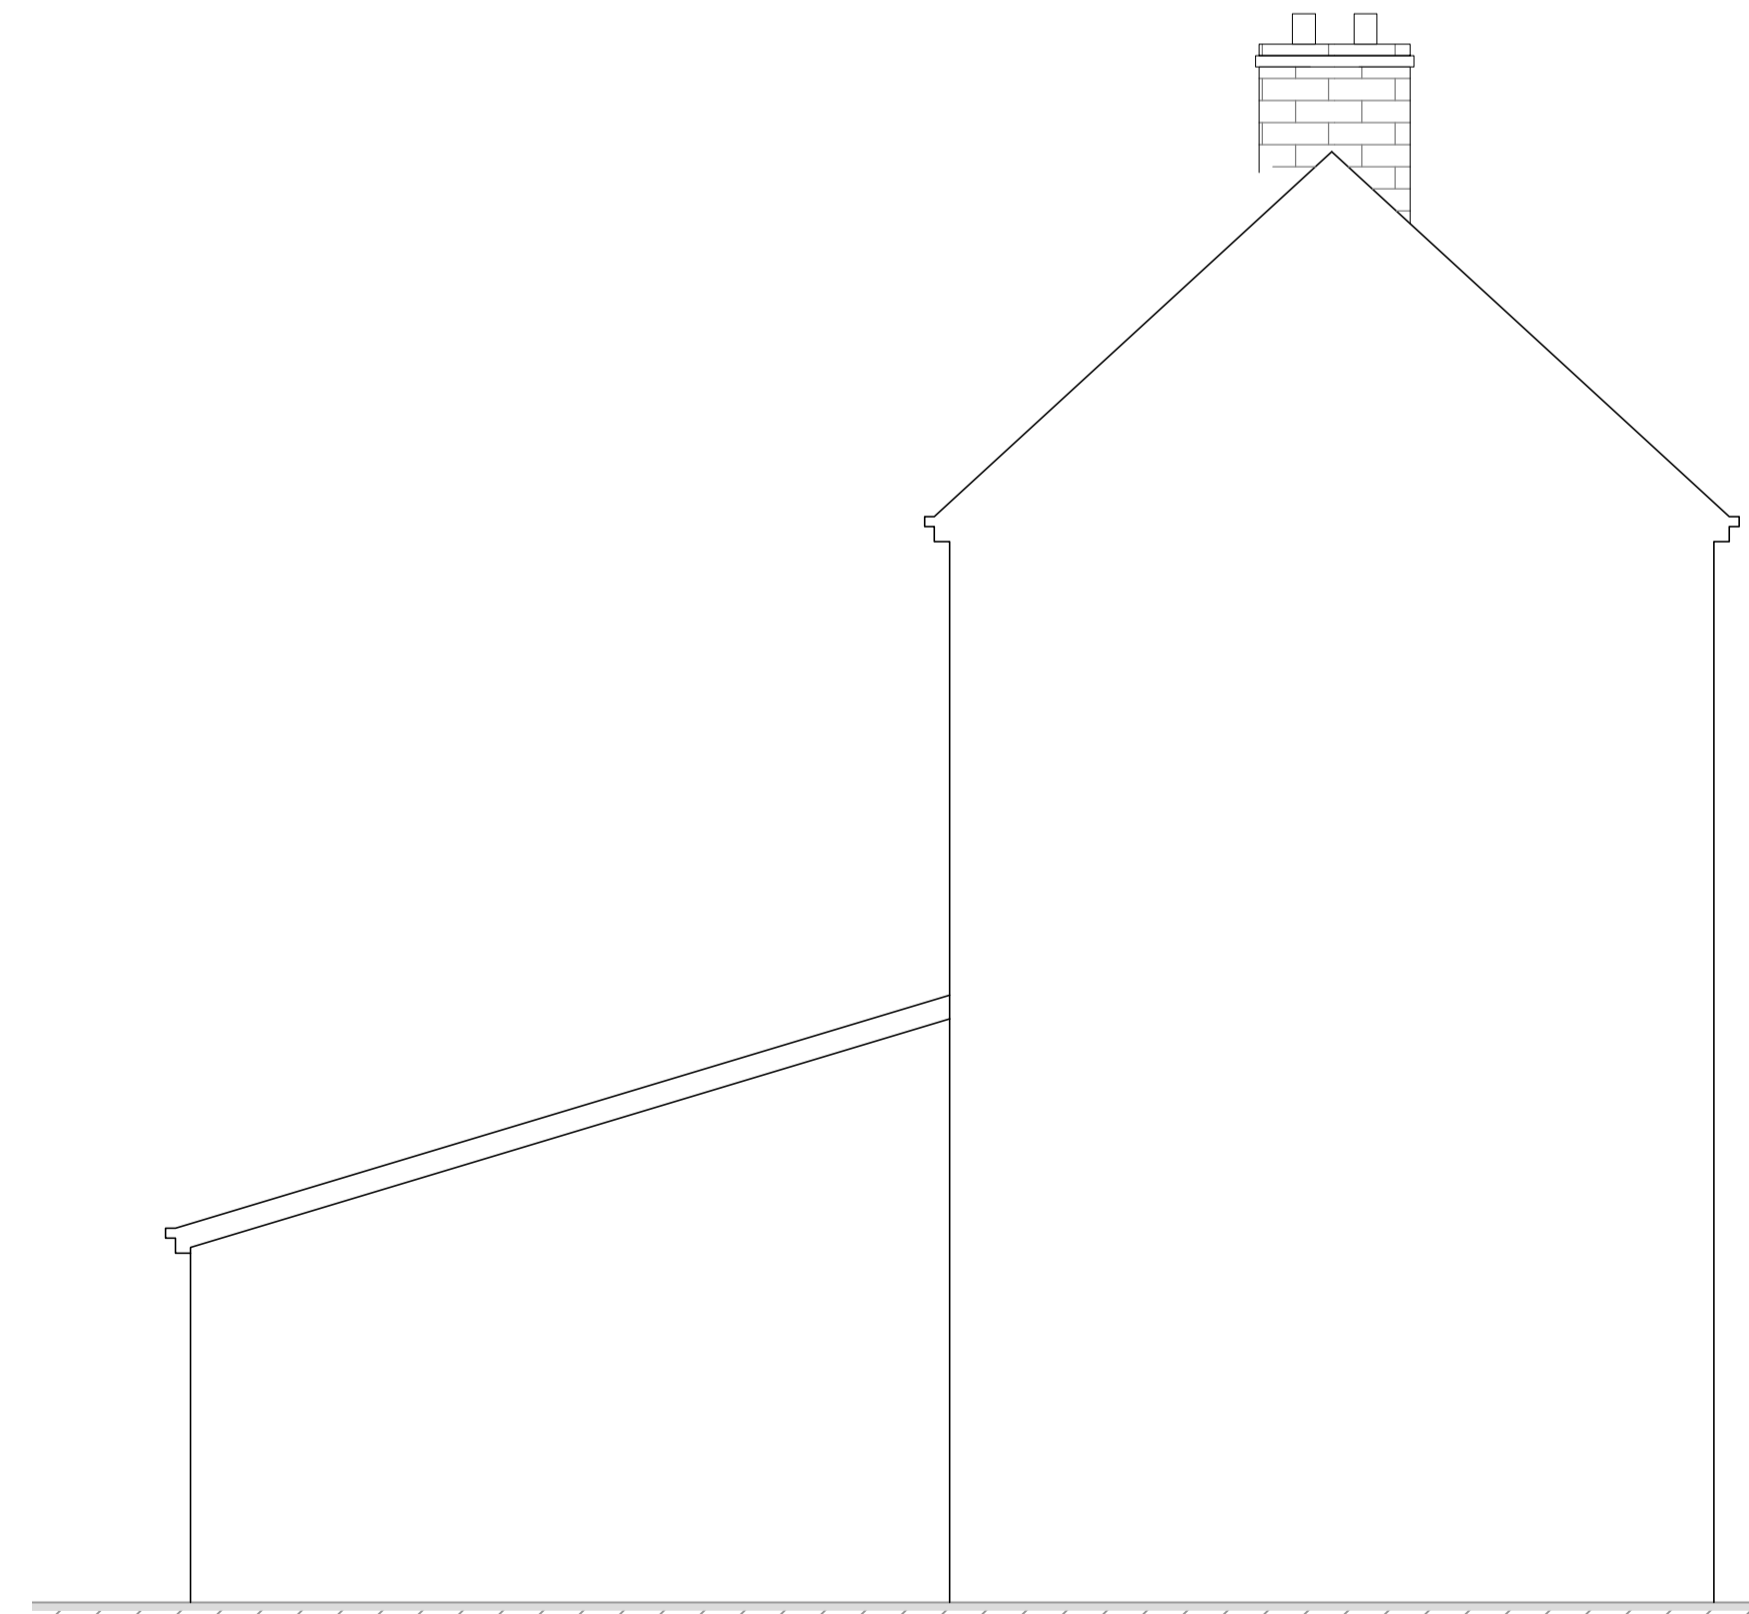

**PROPOSED OTHER SIDE ELEVATION**  
Scale: 1:50

- GENERAL NOTES:**
- Do not scale drawing.
  - Use figured dimensions only, as shown.
  - This drawing is to be read in conjunction with all other relevant drawings and specifications. Draft drawings supplied by MDK Architectural Services are for information purposes only.
  - Contractors, Sub-Contractors and suppliers must verify any critical dimensions on site prior to fabrication of any building element. Any discrepancies are to be reported prior to installation.
  - All works are to be carried out in accordance with the current edition of the Building Regulations 1991 (including amendments), and all relevant British Standards and codes of practice.
  - The contractor is responsible for the correct setting out of the works on site. Exact SVP and Boiler position to be determined on site by contractor.
  - All proposed materials to be similar or match the appearance of the existing house, unless stated otherwise.
  - All proposed materials and items are to be in strict accordance with the respective manufacturers recommendations.

REV:	DATE:	DESCRIPTION:	DI / MKA	DI / MKA
			DRAWN BY:	CHECKED BY:
CLIENT: <b>MR RASHID HUSSAIN</b>				
PROJECT ADDRESS: <b>9 AIREVILLE COLLEGE MOUNT, AIREDALE COLLEGE ROAD, BRADFORD, BD3 0JU</b>				
PROJECT NAME: <b>PROPOSED 5M REAR EXTENSION</b>				
DRAWING TITLE: <b>PROPOSED PLANS AND ELEVATIONS WITH SITE PLAN</b>				
				
DATE:	DRAWN BY:	CHECKED BY:	SCALE:	
01/04/2024	DI	MKA	1:50 @ A1	
PROJECT NO:	STATUS:	REVISION:		
2024-P100	P - PLANNING APPROVAL	-		
DRAWING NO:			<b>DI-DR-P100-02</b>	

**DO NOT SCALE FROM THIS DRAWING**