


Proposed Section A-A - Scale 1:50

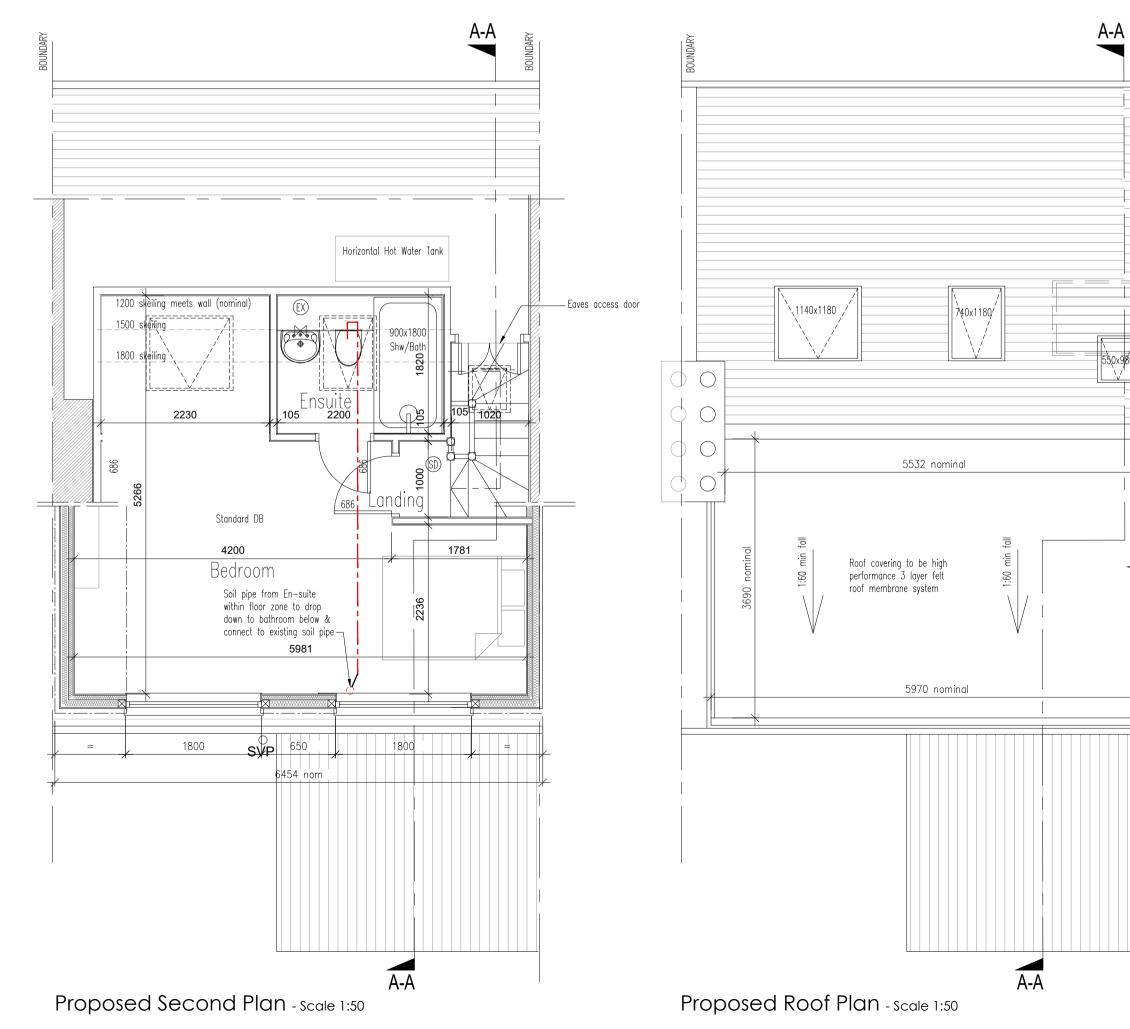

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2. DO NOT SCALE , WORK TO FIGURED DIMENSIONS ONLY.

3. ALL DIMENSIONS ARE TO BE CHECKED ON SITE BEFORE ANY WORK IS PUT IN HAND.

Notes:

4. THIS DRAWING HAS BEEN PRODUCED FOR THE SPECIFIC CLIENT AND PROJECT IDENTIFIED ABOVE AND IS NOT INTENDED FOR USE BY MANY OTHER PERSON OR FOR ANY OTHER PURPOSE.

5. THIS DRAWING IS TO BE READ IN CONJUNCTION WITH ALL RELEVANT ARCHITECT'S, SERVICE ENGINEER'S AND David F Smith, Chartered Building Surveyor and Structural Engineer DRAWINGS AND SPECIFICATIONS.

6. THE MAIN CONTRACTOR FOR THIS PROJECT WILL BE APPOINTED A PRINCIPAL CONTRACTOR UNDER THE CDM REGULATIONS 2015. THE MAIN CONTRACTOR WILL FAMILIARISE HIMSELF WITH THE REGULATIONS AND THE DUTIES OF THE PRINCIPAL CONTRACTOR. THEY SHALL ALLOW SUFFICIENT RESOURCES TO FULFILL THEIR DUTIES AND COMPLY FULLY WITH THE REGULATIONS. THIS INCLUDES THE PREPARATION OF A CONSTRUCTION PHASE HEALTH & SAFETY FILE, TO BE UPDATED AS THE WORKS PROCEED.

7. ANY DISCREPANCY ON THIS DRAWING IS TO BE REPORTED IMMEDIATELY TO THE BUILDING SURVEYOR.

8. THE CONTRACTOR IS RESPONSIPIE FOR ALL TEMPORARY WORKS AND FOR THE STABILITY OF THE WORKS IN PROGRESS.

Horizontal hot water tank - Knauf earthwool loft roll insulation or similar approved supported on chicken wire stapled to joist to ensure 30 minutes fire integrity — 100mm laid between joist with 200mm laid over — Calculated U value 0.15 Eaves ventilator roll to ensure 50mm clear ventilation path - Install 25mm continuous ventilator, either in soffit or via continous tile ventilator to eaves

Dwarf wall Insulation — 100mm Celotex GA4000

SuperFOIL tape or similar approved

between studs with 62.5mm Celotex PL40050 fixed to

inner studs or similar approved — calculated U value of 0.18 — All insulation joints to taped over with

| | BOUNDA | | | | | | | | |
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| | | | | | | | | | |
| | - | Existing parapet | | | | | | | |
| | | Remove existing velux, install smaller velux above stairwell (tbc with client) | | | | | | | |
| 550×980 | | | Rev Date Initials Notes | | | | | | |
| | | New velux above stairwell | С | 02.04.24 | chb | Front elevation | on added | | |
| | | | В | 22.02.24 | chb | Width of dorr | mer increased | | |
| | | | A | 16.11.23 | chb | Dimensions o | idded to flat roo | f | |
| | | | REV: DESCRIPTION: BY: DATE: | | | | | | |
| | | | BUILDING REGS DavidFSmith MRICS Dip. Surv., MRICS, AMIStructE., I Eng., TMICE Chartered Building Surveyor, Structural Engineer 10 Rowan Way, Rottingdean, East Sussex BN2 7FP T: 01273 276956, E: enquiries@dfsmithsurveyors.com | | | | | | |
| | \bigcirc | | | | | | | | |
| | | New warm insulated flat roof | | | | | | | |
| | . | CLIENT: Mr & Mrs Clements | | | | | | | |
| | | | ADDRESS: 78 Queens Park Rise | | | | | | |
| | | | Brighton, BN2 9ZF | | | | | | |
| | | | SITE: 78 Queens Park Rise Brighton, BN2 9ZF | | | | | | |
| | | | TITLE: Room In Roof Dormer Conversion | | | | | | |
| | DRAWING TITLE: Proposed Plans & Elevations | | | | | | | | |
| | | | SCALE: 1:50 |)-1:100@ | | ATE: 25.08.22 | drawn: CHB | CHECK | DS |
| | | | PROJE | | | RAWING NO: | 2 | REVISI | ON: |
| | | | <u>'</u> | 22.13 | 52 | BRO | 2 | | C |
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