


Do not scale from this drawing.
SAFETY HEALTH AND ENVIRONMENTAL INFORMATION
IN ADDITION TO THE HAZARD/RISKS NORMALLY ASSOCIATED WITH THE TYPES OF WORK DETAILED ON THIS DRAWING, NOTE THE FOLLOWING RISKS AND INFORMATION.
RISKS LISTED HERE ARE NOT EXHAUSTIVE. REFER TO DESIGN ASSESSMENT FORM NO.
CONSTRUCTION 250mm Ø SCOTTISH WATER ASBESTOS CEMENT WATER MAIN ADJACENT TO NORTH EAST SITE BOUNDARY. INUNDATION OF CANAL WATER TO CONSTRUCTION SITE DUE TO CANAL LOCK FAILURE.
DEMOLITION
NONE THAT COULD NOT BE FORESEEN BY A COMPETENT CONTRACTOR.
FOR INFORMATION RELATING TO USE, CLEANING AND MAINTENANCE SEE THE HEALTH AND SAFETY FILE.
IT IS ASSUMED THAT ALL WORKS WILL BE CARRIED OUT BY A COMPETENT CONTRACTOR WORKING, WHERE APPROPRIATE, TO AN APPROVED METHOD STATEMENT.

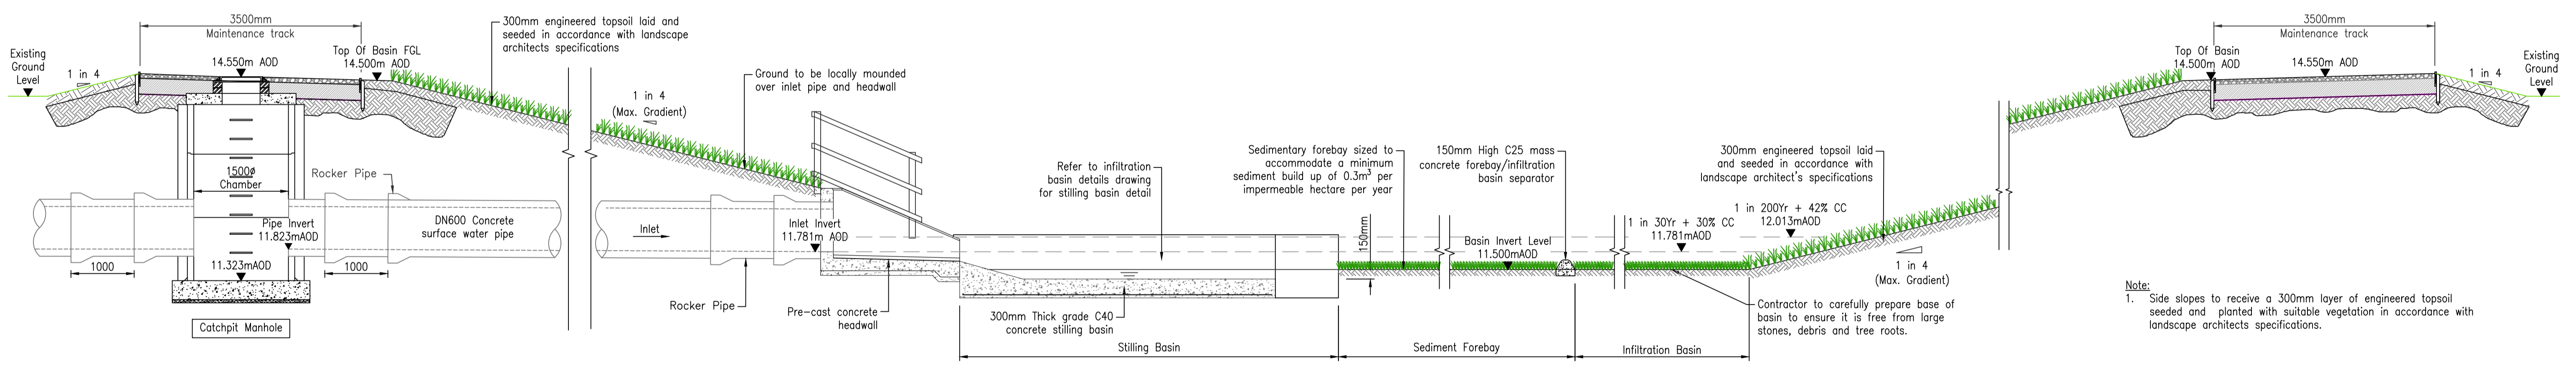

Typical Longitudinal Section Through
Infiltration Basin Inlet
Scale 1:50

Note:
1. Side slopes to receive a 300mm layer of engineered topsoil seeded and planted with suitable vegetation in accordance with landscape architects specifications.

- Notes:
- DO NOT SCALE FROM THIS DRAWING
 - ALL DIMENSIONS ARE IN METERS UNLESS SPECIFIED OTHERWISE.
 - ALL SEWERS AND MANHOLES TO BE LAID AND CONSTRUCTED IN ACCORDANCE WITH "SEWERS FOR SCOTLAND 4TH EDITION".
 - REFER TO FAIRHURST DRAWING 149592/2200 & 2201 FOR DRAINAGE LAYOUT PLAN SHEETS 1 & 2.
 - REFER TO FAIRHURST DRAWING 149592/2207 FOR INFILTRATION BASIN CONSTRUCTION DETAILS

	Client:	NEW HOUSING TORVEAN NORTH	
	Project Title:	NEW HOUSING TORVEAN NORTH	
	Scale at A1:	1:50	
	Status:	For Appraisal	
	Drawing Title:	INFILTRATION BASIN SECTIONS PHASE 1	
	Checked:	RMS	
	Date:	11/03/2024	
	Date:	13/03/2024	
	Drawing No.:	149592/2208	
	Revision:	-	

Rev.	Date	Description	Drawn	Checked	Approved