

No.	REVISION	DRAWN BY	CHECKED BY	DATE
3	ISSUED FOR PLANNING & WARRANT APPROVAL	Z.URQUHART		18/04/2024
2	DRAWING AMENDMENTS AS PER CUSTOMER COMMENTS	Z.URQUHART		08/04/2024
1	ISSUED TO CUSTOMER FOR APPROVAL	Z.URQUHART		02/04/2024
0	ISSUED TO SALES FOR APPROVAL	Z.URQUHART		20/03/2024

CUSTOMER:
MR & MRS B. HENDERSON
57 NESS CIRCLE
ELLON
ABERDEENSHIRE
AB41 9BR

PROJECT:
PROPOSED EXTENSION

THISTLE CONTRACT NO: **41560**



THISTLE
HOME IMPROVEMENTS GROUP

THISTLE HOUSE, WOODSIDE ROAD
BRIDGE OF DON, ABERDEEN, AB23 8EF

TEL: 01224 706555 WWW.THISTLE.GROUP

DATE	MARCH '24	DRAWING NO:	101
SCALE	1:100		

GENERAL NOTES

ALL ELECTRICAL WORK TO BE CARRIED OUT IN STRICT ACCORDANCE WITH THE LATEST I.E.E REGULATIONS AND TO COMPLY WITH THE 18TH EDITION OF THE BS 7671: 2018 'THE REQUIREMENTS FOR ELECTRICAL INSTALLATIONS'.

ANY DISCREPANCIES OR QUERIES REGARDING ANY PART OF THE WORKS TO BE DISCUSSED PRIOR TO ANY AFFECTED WORK BEING CARRIED OUT.

WHILST THE HIGHLIGHTED AREAS ARE INDICATIONS OF SERVICES BELOW GROUND THERE MAY BE OTHERS OUT WITH, THEREFORE ALL EXCAVATIONS SHOULD INCORPORATE EXTREME CARE AND DILIGENCE.

DRAWINGS TO BE READ AND UNDERSTOOD PRIOR TO WORK COMMENCING. FIGURED DIMENSIONS TO TAKE PREFERENCE OVER SCALED DIMENSIONS. ALL DIMENSIONS AND LEVELS TO BE CHECKED ON SITE. EXISTING DRAINAGE AND SERVICES POSITIONS TO BE CONFIRMED ON SITE. ANY DISCREPANCIES TO BE REPORTED BACK TO ARCHITECT.

CUSTOMER APPROVAL		
SALES ADVISER		
SALES MANAGER		
APPROVAL	DATE	SIGNATURE

Existing Ground Floor Plan
scale 1:100



EXISTING FINISHES :

ROOF:
 BROWN PROFILED ROOF TILES to DWELLINGHOUSE
 GREY FLAT ROOF TILES to GARAGE


DRAINAGE:
 BLACK uPVC GUTTERS & DOWNPIPES; uPVC BROWN FASCIAS & WHITE SOFFITS

WINDOWS & DOORS:
 ROSEWOOD uPVC DOUBLE GLAZED UNITS to DWELLINGHOUSE
 ROSEWOOD ROLLER DOOR & WHITE PAINTED TIMBER DOOR [REAR] to GARAGE


WALLS:
 DARK GREY BRICK Tto BASECOURSE, WHITE RENDER TO WALLS to DWELLINGHOUSE

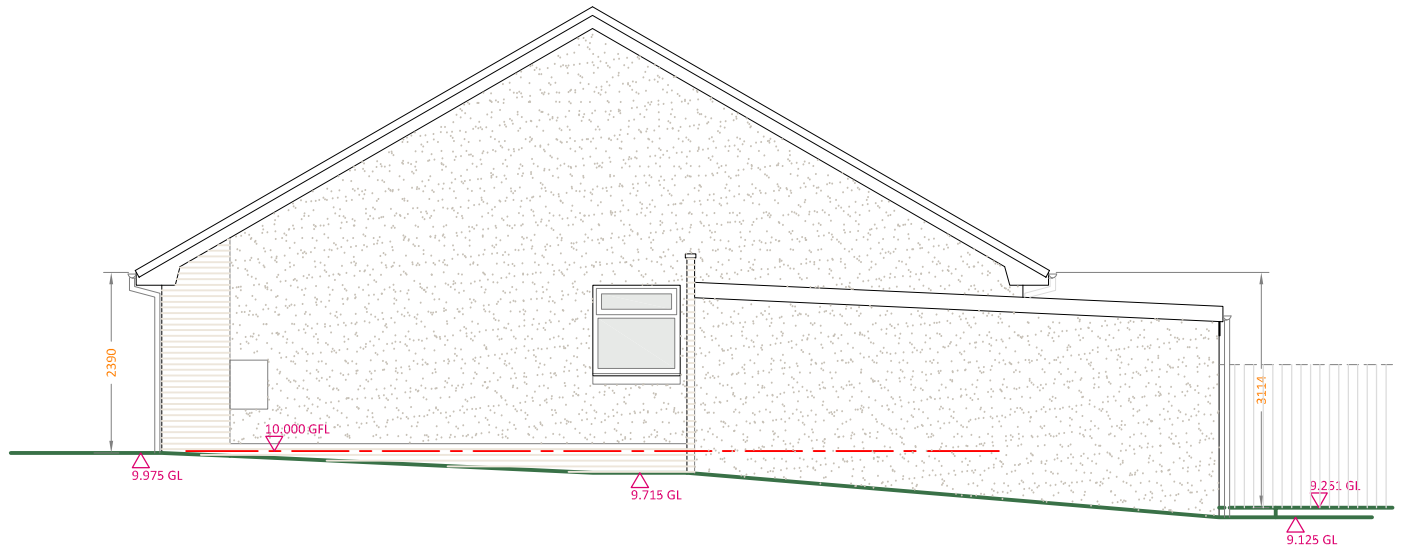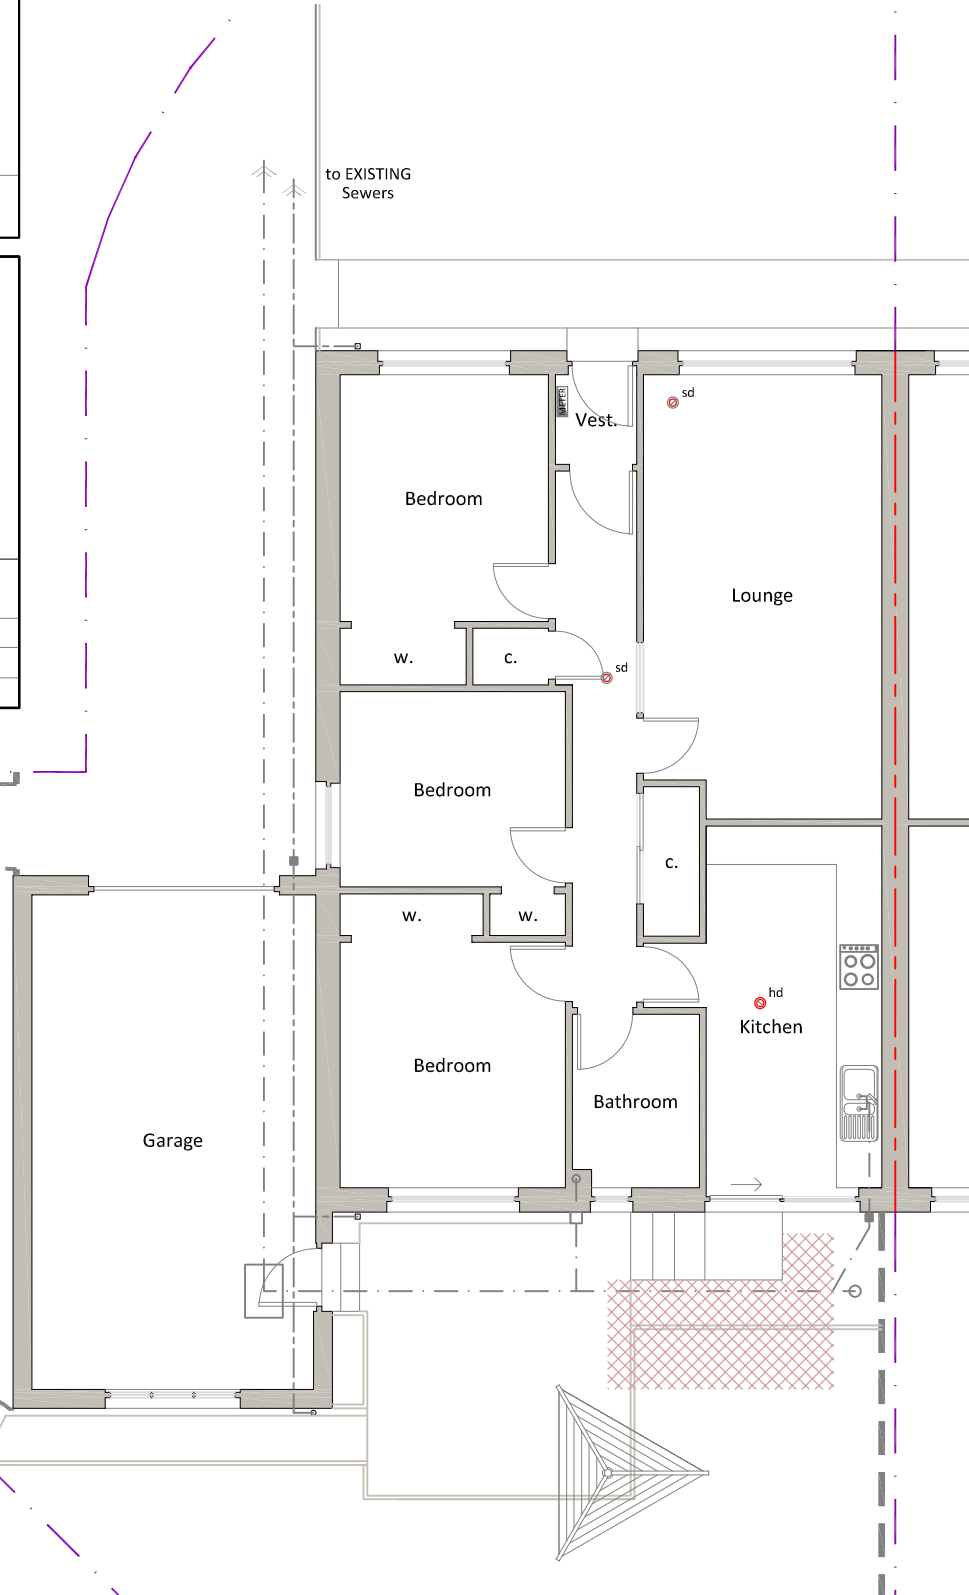

Existing South-West Elevation
scale 1:100

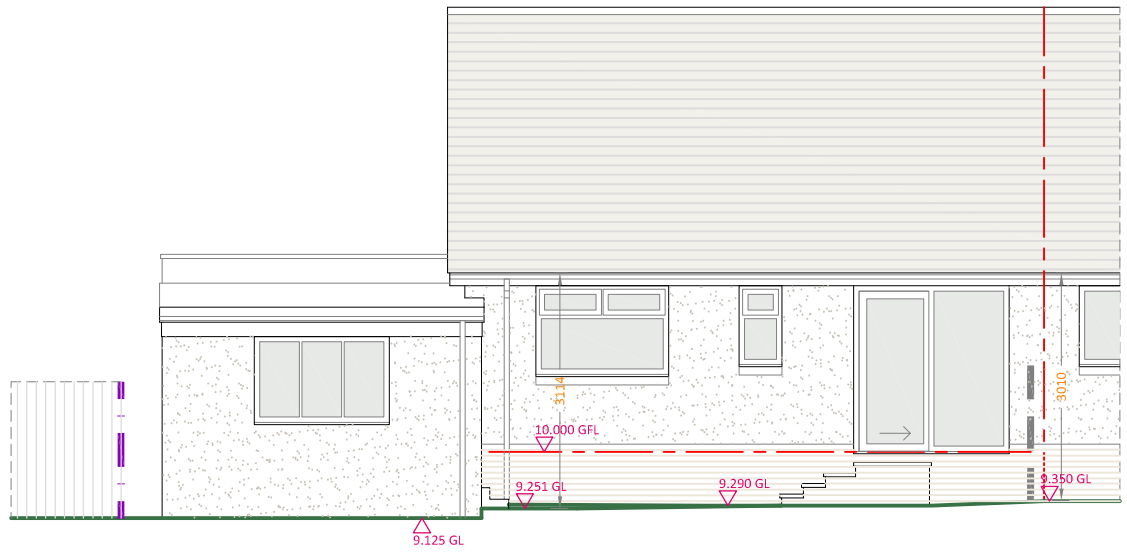

Existing South-East Elevation
scale 1:100

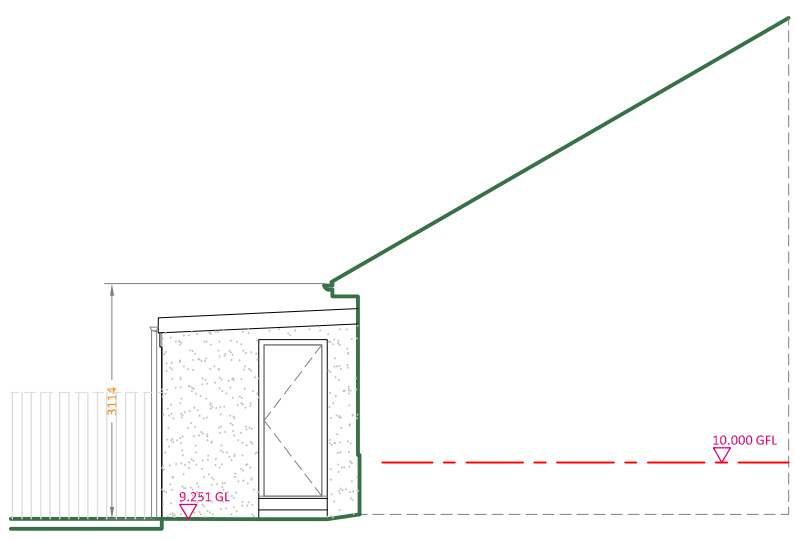

Existing North-East Elevation [INTERNAL]
scale 1:100

