
1:500 0 2 4 8 12 16 20m GROOMBRIDGE CLOSE 34 Proposed Roof Plan 1:100 100 Existing Block Plan 1:500 **1:200 0** 1 2 4 8 10m 0 111 GROOMBRIDGE 22 12 $\overline{}$ Tyrell Avenue 20 132

KEY

- Emergency egress windows at first floor bedrooms and any inner rooms, fitted with hinges to allow minimum 450mm x 800mm clear opening (min. area 0.33m2). Cill height should not be greater than 1100mm from finished floor level.
- (ef) Mechanical extractor ducted to outside air. Shower/WC minimum 15 ltr/sec with separate switch,15 minutes overrun if windowless or fixed unopenable windows.
- Mains operated with battery back-up and interlinked smoke alarms and heat alarm are to be fitted at positions shown on plans. Minimum system to be grade D, category LD2 system complying to BS5839-6: 2004. Positions to be ceiling mounted, minimum 300mm away from wall junctions or light fittings and max. 3 metres from bedroom door. Detector units to comply to BS5446-1-2:

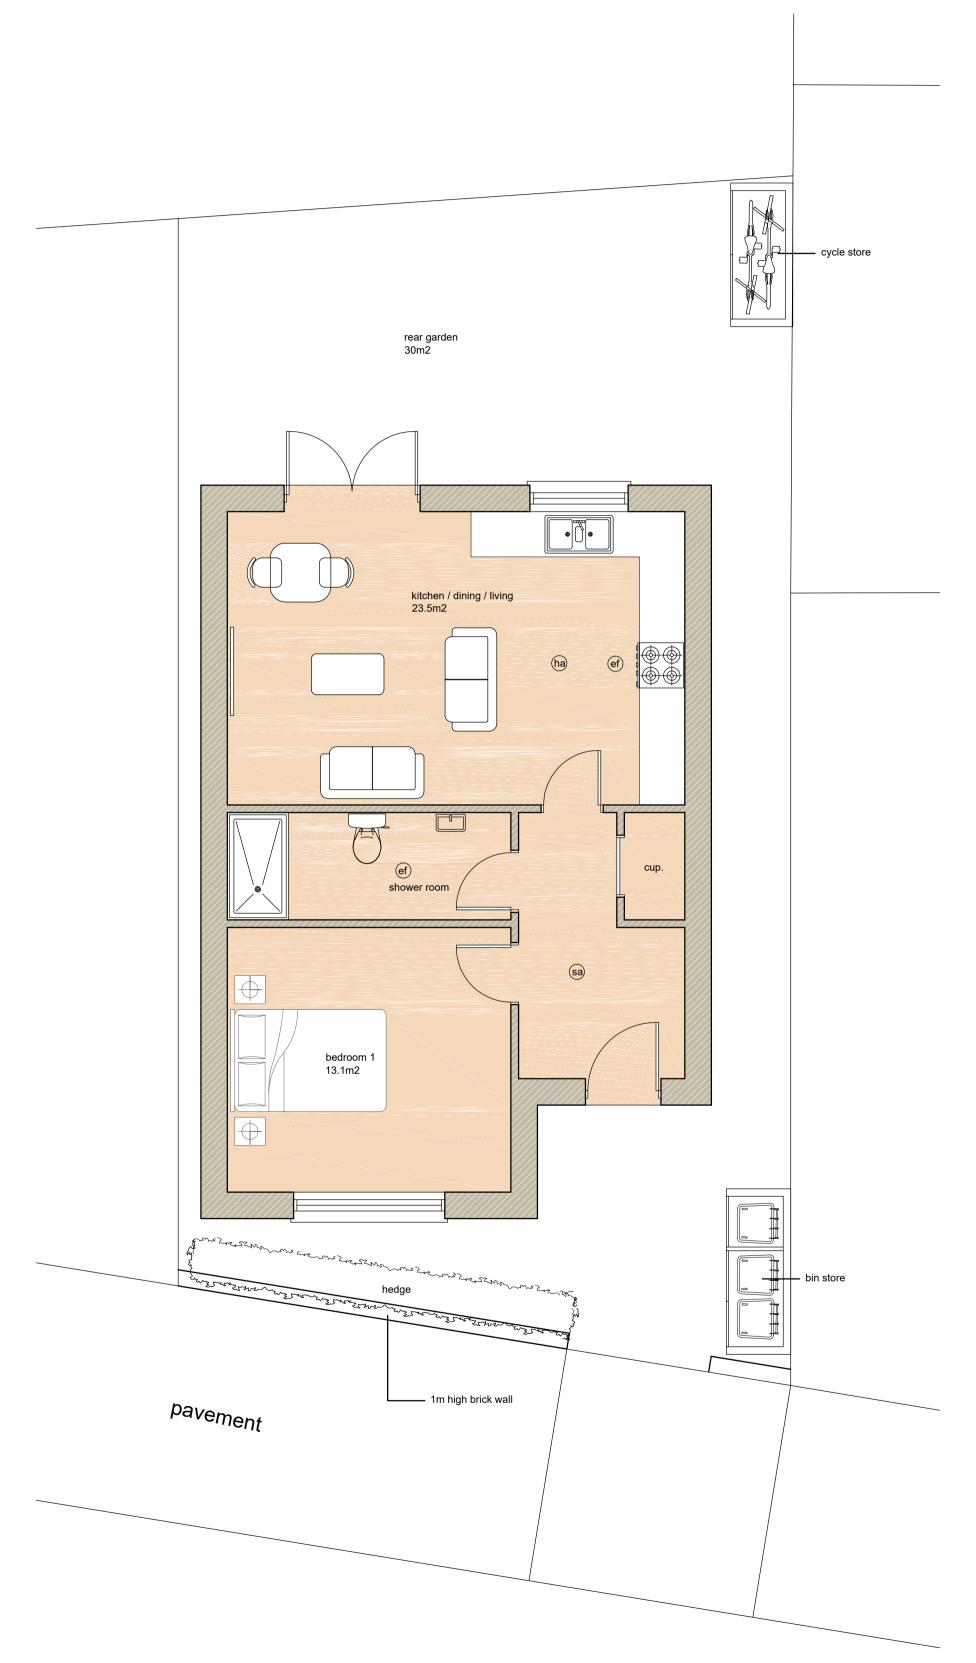

Floor Area of Proposed New Dwelling (1 Bed 2 People):

Overall G.I.A = 51m²

Proposed Ground Floor Plan 1:50


General Notes:

1. Dimensions should not be scaled from the drawings where

- accuracy is essential. 2. Details dimensions and levels to be checked on site by builder prior to commencement of works. Any works commenced prior to all necessary local authority approvals are entirely at the risk of the owner & builder. 3. Structural details are subject to exposure of existing construction and verification by L.A Surveyor and any necessary revised details are to be agreed with the L.A Surveyor prior to carrying out the affected works. 4. All materials are to be used in accordance with the manufacturers' guidelines and all relevant British Standards Codes of Practice & Regulation 7 of Building Regs.
- Authority requirements. 6. The intended works fall within the Party Wall Act 1996 and any adjoining owners affected must be notified prior to commencement of any works.


5. All works are to be carried out in accordance with Local


When printing off pdf drawings, it is the responsibility of the user to verify that the resulting prints are to scale on the appropriate sized sheet. Also the scale bar on the plan measure correctly.

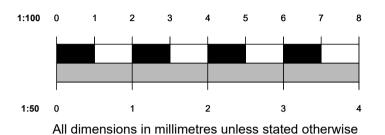



Site Plan at 1:1250

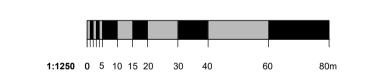

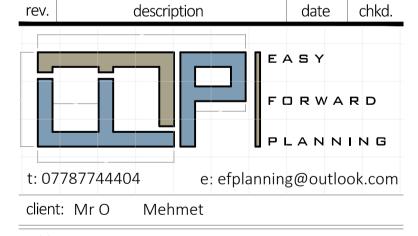

address:

22 Groombridge Close, Welling, Kent, DA16 2BS

drawing title:

Proposed Floor Plan & Block Plans.

project:

Erection of a 1 bedroom detached bungalow.

drawn:	Eralp Semi	chk	d:		sch:
status:	Planning		dat	e:	April 2024

drawing no: EFP/24019 - 1 Bungalow

scale: 1:50, 1:100 at A1 rev date:

Proposed Block Plan 1:200