

F-Line **Designs**

planning@flinedesigns.cor 020 364 268 00

12 Berghem Mews, Blythe Road, London United Kingdom W14 0HN

All dimensions must be checked on site before any works commencement.

All discrepancies must be reported to the Main Architect before works proceed.

Only figured dimensions are to be used.

Any conflict of given data on the drawing(s) with site condition to be discussed with the Architect

The General Contractor and/or all Sub-contractors working according these drawings and specifications to contact the architect or representative if any measurements do not appear correct or unclear, add up properly or scale correctly to the indicated size upon approvals.

- All drawings to be read in conjunction with structural engineer's drawings and specifications.

 All Structural Elements Spans must be measured on site
- before ordering.

 This drawing must be read in conjunction with the Structural Engineer's Drawings, Calculations and other details.

Accurate site dimensions are to be taken by the contractor on site prior to any construction commencing.

PROPOSED DROPPED KERB


17 BARNHURST PATH WD19 6TX


LOCATION PLAN

FL190

A100

DATE 01/11/2023 DRAWN NV AC CHECKED REV SCALE 1:100 / A3

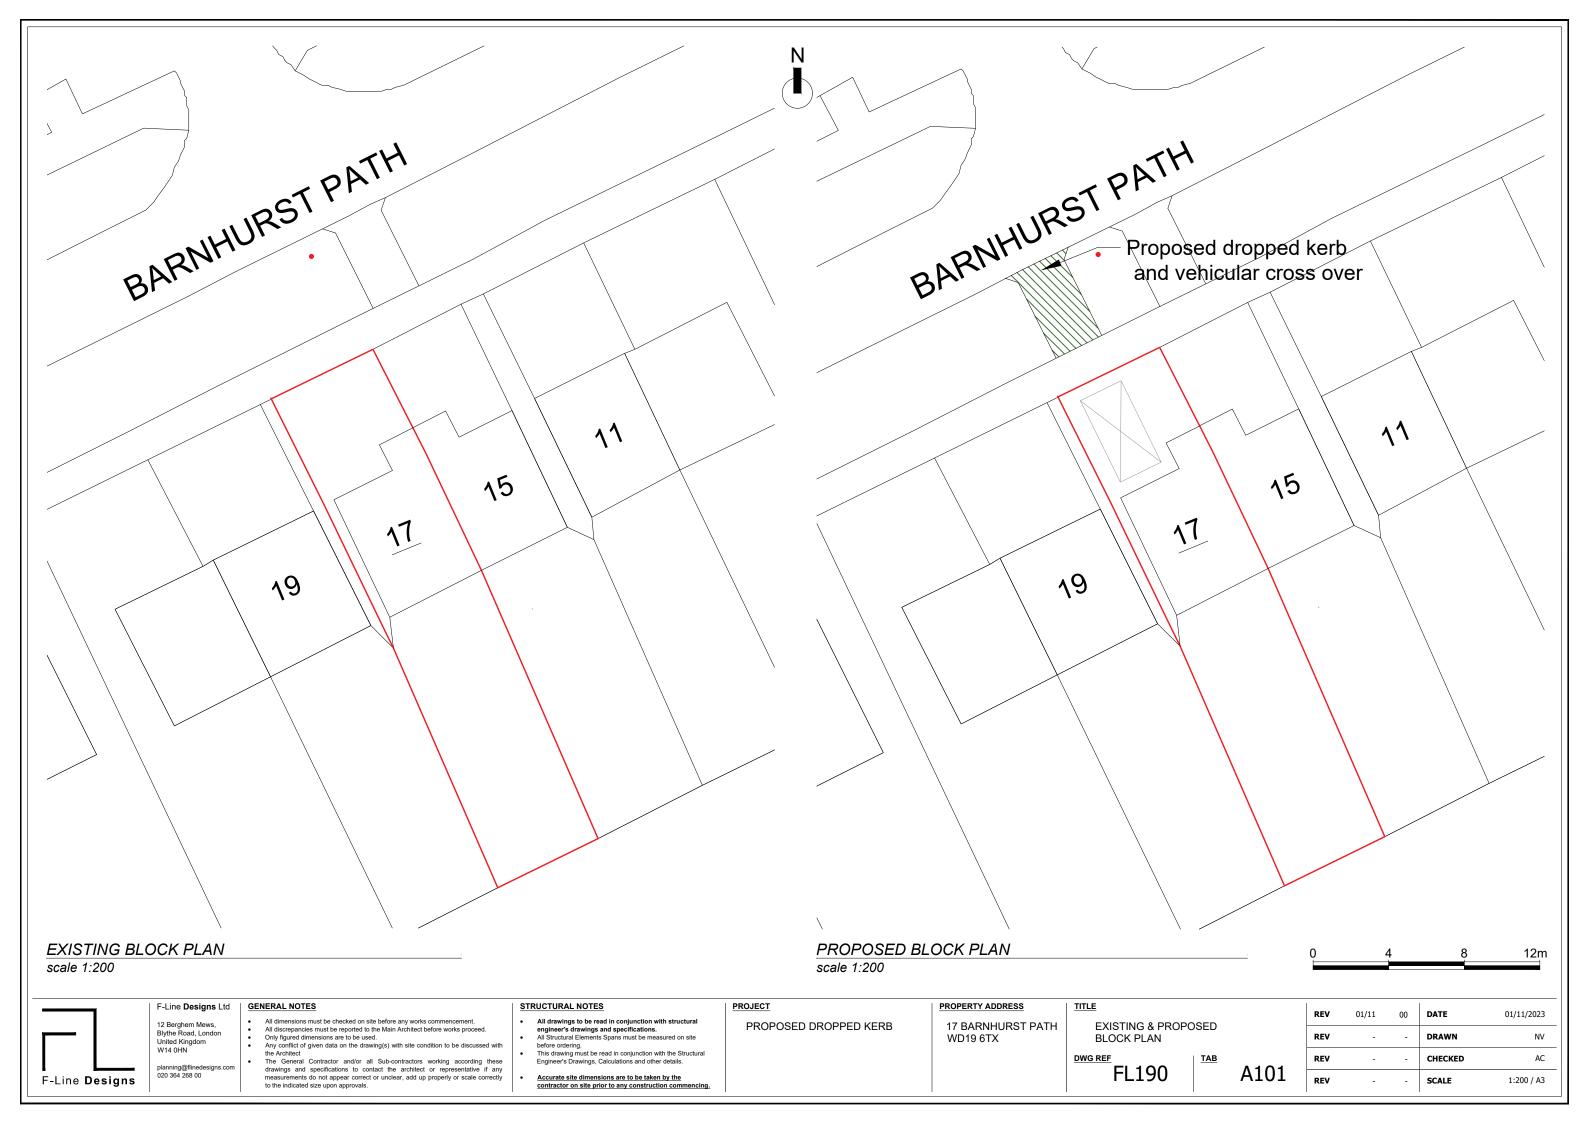

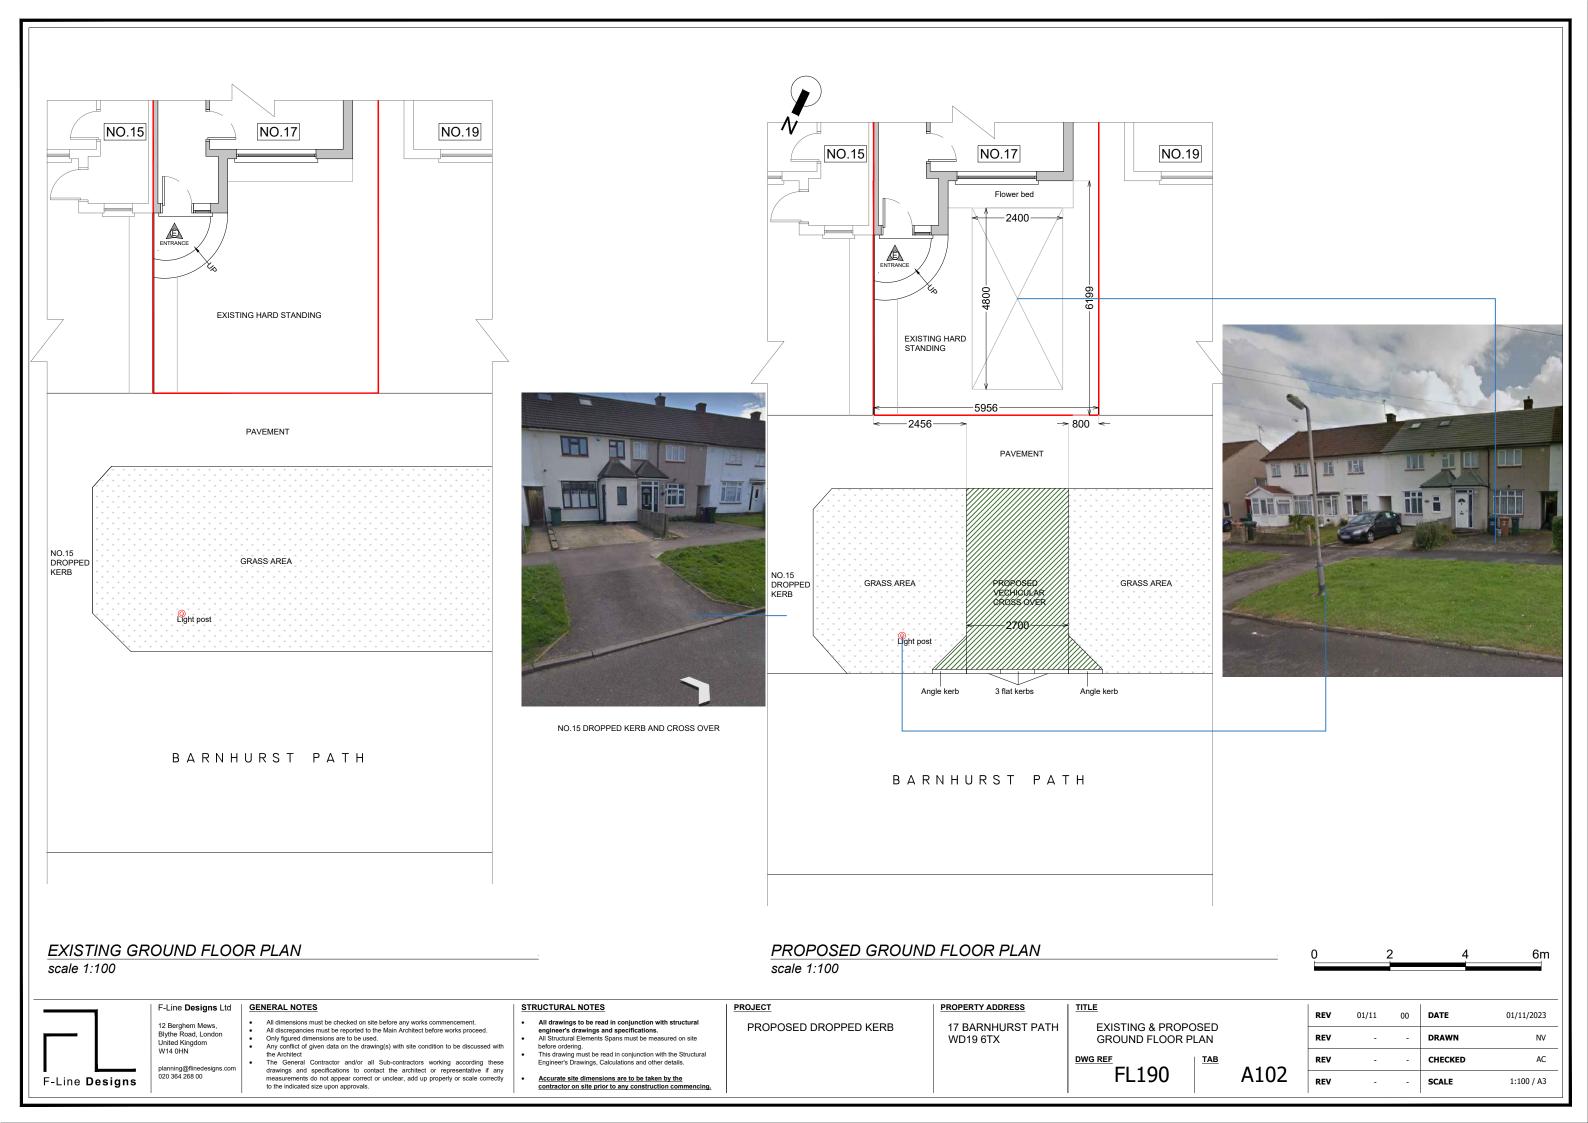





EXISTING FRONT ELEVATION

scale 1:100

PROPOSED FRONT ELEVATION

scale 1:100



F-Line **Designs**

F-Line **Designs** Ltd

12 Berghem Mews, Blythe Road, London United Kingdom W14 0HN

020 364 268 00

- All dimensions must be checked on site before any works commencement.
 All discrepancies must be reported to the Main Architect before works proceed.
 Only figured dimensions are to be used.
 Any conflict of given data on the drawing(s) with site condition to be discussed with
- Any continct of given data on the drawing(s) with site condition to be discussed with the Architect

 The General Contractor and/or all Sub-contractors working according these drawings and specifications to contact the architect or representative if any measurements do not appear correct or unclear, add up properly or scale correctly to the indicated size upon approvals.

STRUCTURAL NOTES

- All drawings to be read in conjunction with structural engineer's drawings and specifications.

 All Structural Elements Spans must be measured on site before order.
- before ordering.

 This drawing must be read in conjunction with the Structural Engineer's Drawings, Calculations and other details.
- Accurate site dimensions are to be taken by the contractor on site prior to any construction commencing

PROPOSED DROPPED KERB

PROPERTY ADDRESS 17 BARNHURST PATH

WD19 6TX

EXISTING & PROPOSED ELEVATIONS

DWG REF

FL190

A20 3

01/11 00 DATE 01/11/2023 REV DRAWN CHECKED AC REV SCALE 1:100 / A3