



LOCATION PLAN SCALE 1:1250

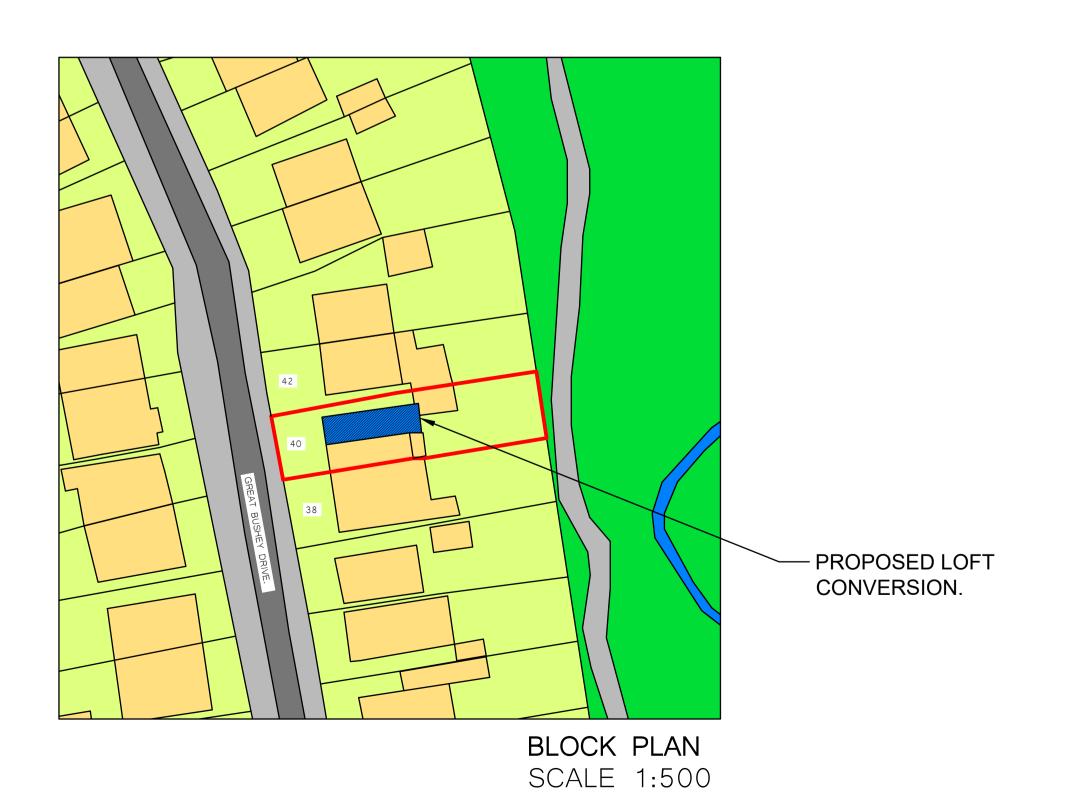

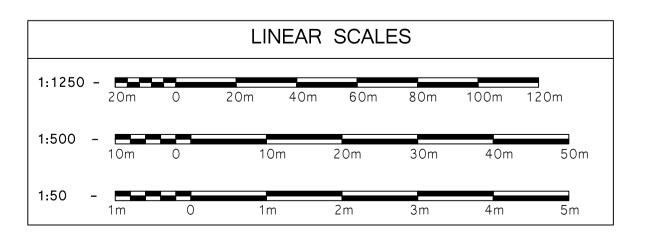

General Notes

LEGEND

EXISTING SOLID WALL

WALL TO BE REMOVED

BRICKWORK WALL

BLOCKWORK WALL

WALL TO BE CONSTRUCTED

NON LOAD-BEARING WALLS

PROPOSED STEEL BEAM (1)

PROPOSED STEEL COLUMN (1)

PROPOSED TIMBER MEMBER (T1)

REFERS TO CONCRETE PADSTONE (1)

"FFL" FINISHED FLOOR TO CEILING HEIGHT "SFL" STRUCTURAL FLOOR TO CEILING HEIGHT

DIRECTION OF TIMBER FLOOR JOISTS (1)

DIRECTION OF TIMBER ROOF RAFTERS (1)

INDICATES PERIMETER OF NEW FOUNDATIONS

REFERS TO SECTION "A" FROM SHEET 01

DIRECTION OF CONCRETE SLAB (1)

DIRECTION OF STAIRS GOING UP

REFERS TO DETAIL "YY"

PROPOSED LINTEL (1)

LOFT HATCH

TIMBER STUD LOAD-BEARING WALLS

INDICATES EXISTING CEILING BEAMS

SYMBOL

X|....X

B1

COL1

X

- J1 -

A 4

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Drawing Notes

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- 7. SHOULD THE CONTRACTOR COMMENCE SITE WORK PRIOR TO APPROVAL BEING GIVEN, IT IS ENTIRELY AT THEIR OWN RISK;
- 8. HAZARDS IDENTIFIED THUS: 🔼

9. ITEMS OF IMPORTANCE HIGHLIGHTED THUS:

10. CHECK COMPONENTS AS SUPPLIED MATCH DRAWINGS. WHERE SUBSTITUTIONS ARE MADE, THE ENGINEER (KEC) MUST BE INFORMED PRIOR TO LOADING.

Rev.	Date	Details of Revision
D01	12/04/24	FIRST ISSUE - FOR APPROVAL
D02	19/04/24	CHANGES TO THE ROOF PITCH AND LOFT ARRANGEMENT.
D03	25/04/24	FINAL DRAWINGS APPROVAL FOR PLANNING SUBMISION.
D04	26/04/24	FINAL (2) DRAWINGS APPROVAL FOR PLANNING SUBMISION.
P01	30/04/24	DRAWINGS APPROVED FOR PLANNING.

MR FOROOZ GHASSEMI

Project Title

40 GREAT BUSHEY DRIVE, LONDON, N20 8QL

Drawing Title

PLANNING LOFT CONVERSION BLOCK & LOCATION PLANS




PLANNING

1 of 10 P01


Designed By	у	Date	Checked By	Date
	RK	12/04/24	RK	12/04/24
File No.	390-01		Scale AS IND	DICATED
	lo.		Sheet No.	Rev No.

390-01-FOZ-RES-APP-01

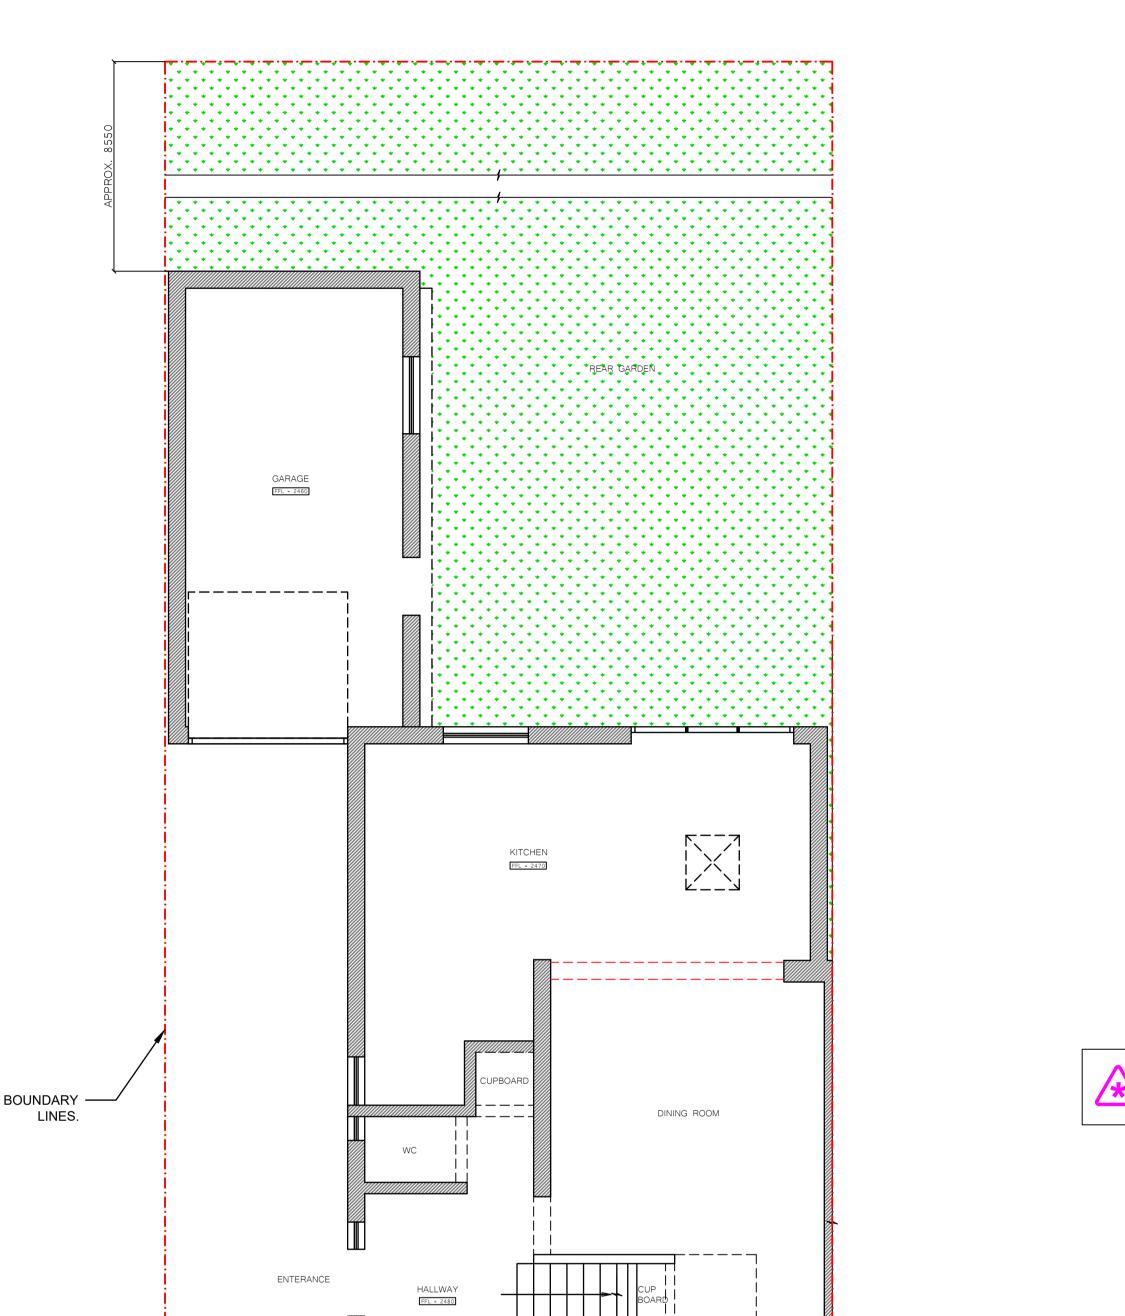


OFFICE

FRONT DRIVE

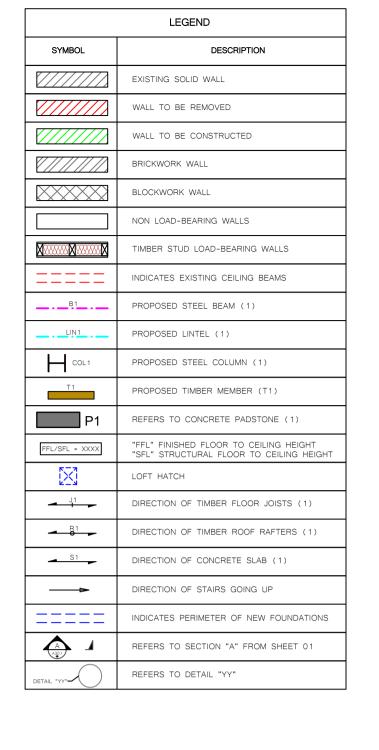

NO CHANGES WILL BE MADE ON THE GROUND FLOOR LEVEL. HENCE THE GROUND FLOOR GA WILL REMAIN THE SAME.

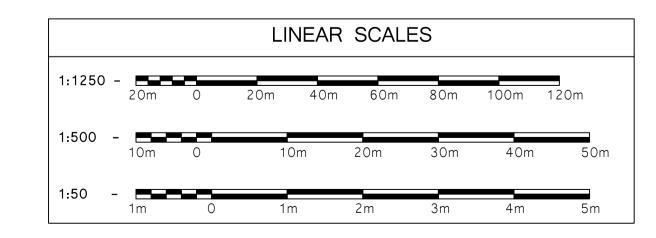

EXISTING GROUND FLOOR GENERAL ARRANGEMENT SCALE 1:50

General Notes

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- 8. HAZARDS IDENTIFIED THUS: 🔼

PRIOR TO LOADING.



9. ITEMS OF IMPORTANCE HIGHLIGHTED THUS:

SUBSTITUTIONS ARE MADE, THE ENGINEER (KEC) MUST BE INFORMED



CHANGES TO THE ROOF PITCH

AND LOFT ARRANGEMENT.

PO1 30/04/24 DRAWINGS APPROVED FOR PLANNING. FINAL (2) DRAWINGS APPROVA D04 26/04/24 FOR PLANNING SUBMISION. FINAL DRAWINGS APPROVAL FOR D03 25/04/24 PLANNING SUBMISION.

D01 12/04/24 FIRST ISSUE - FOR APPROVAL Rev. Date Details of Revision Client

Project Title

D02 19/04/24

40 GREAT BUSHEY DRIVE, LONDON, N20 8QL

MR FOROOZ GHASSEMI

Drawing Title

PLANNING LOFT CONVERSION EXISTING (AND PROPOSED) GROUND FLOOR GENERAL ARRANGEMENT




PLANNING


Email: info@kolekaengineering.co.uk Website: www.kolekaengineering.co.uk

Designed By	Date	Checked By	Date
RK	12/04/24	RK	12/04/
File No		Scale	

Scale AS INDICATED 390-01

390-01-FOZ-RES-APP-01 2 of 10 P01

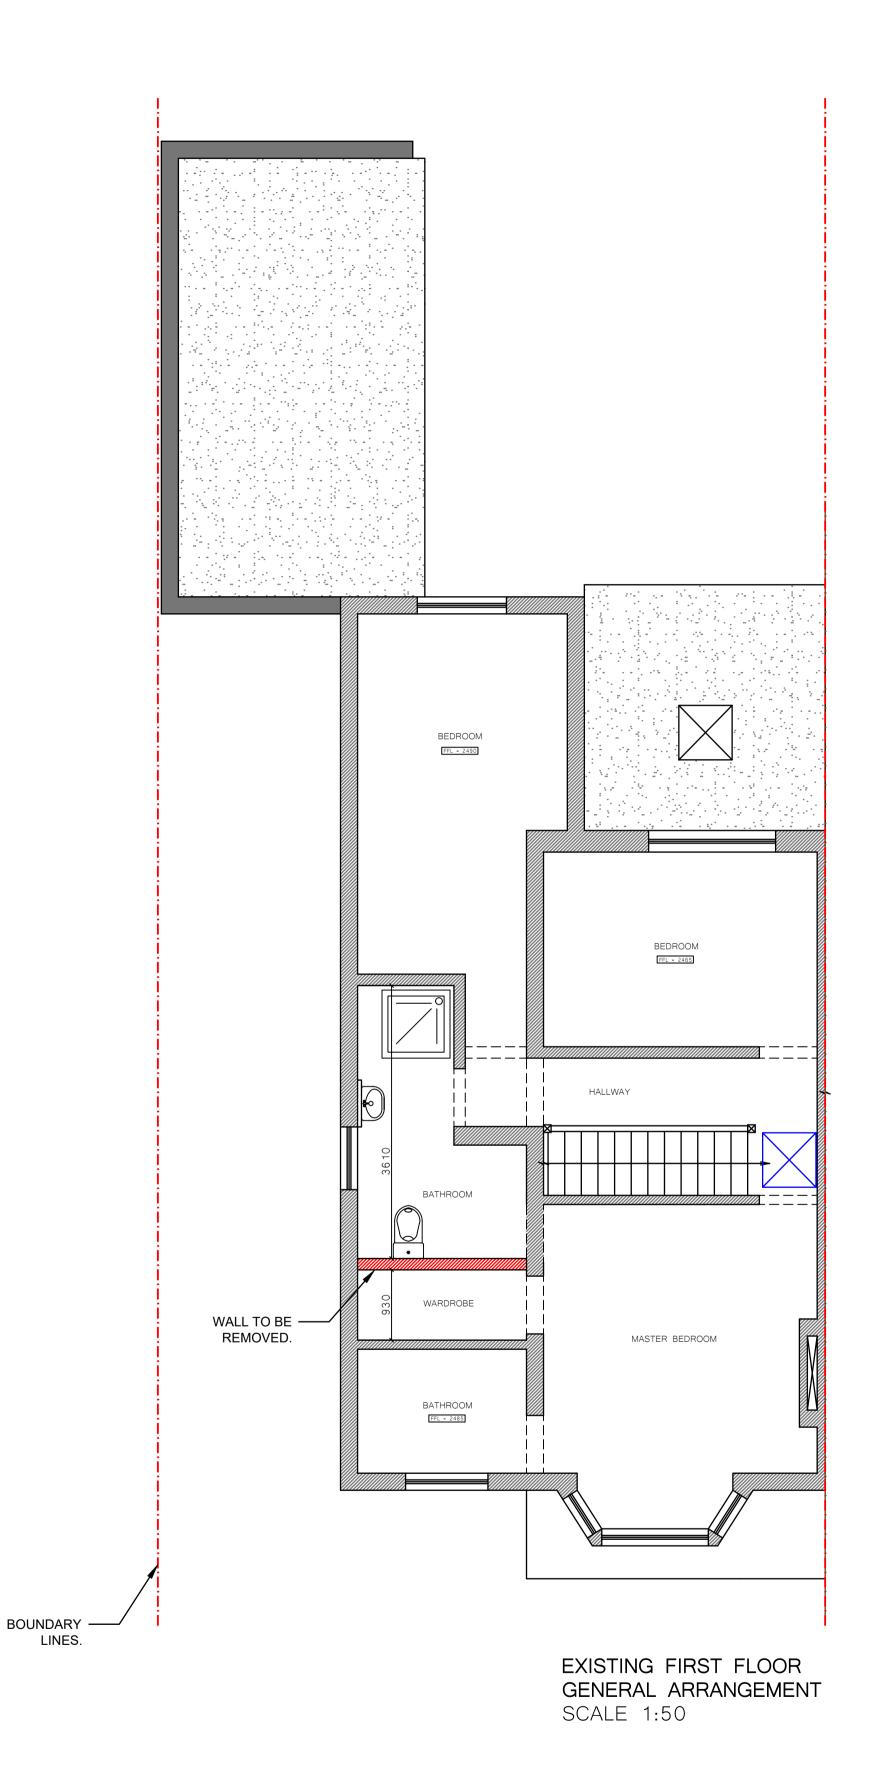

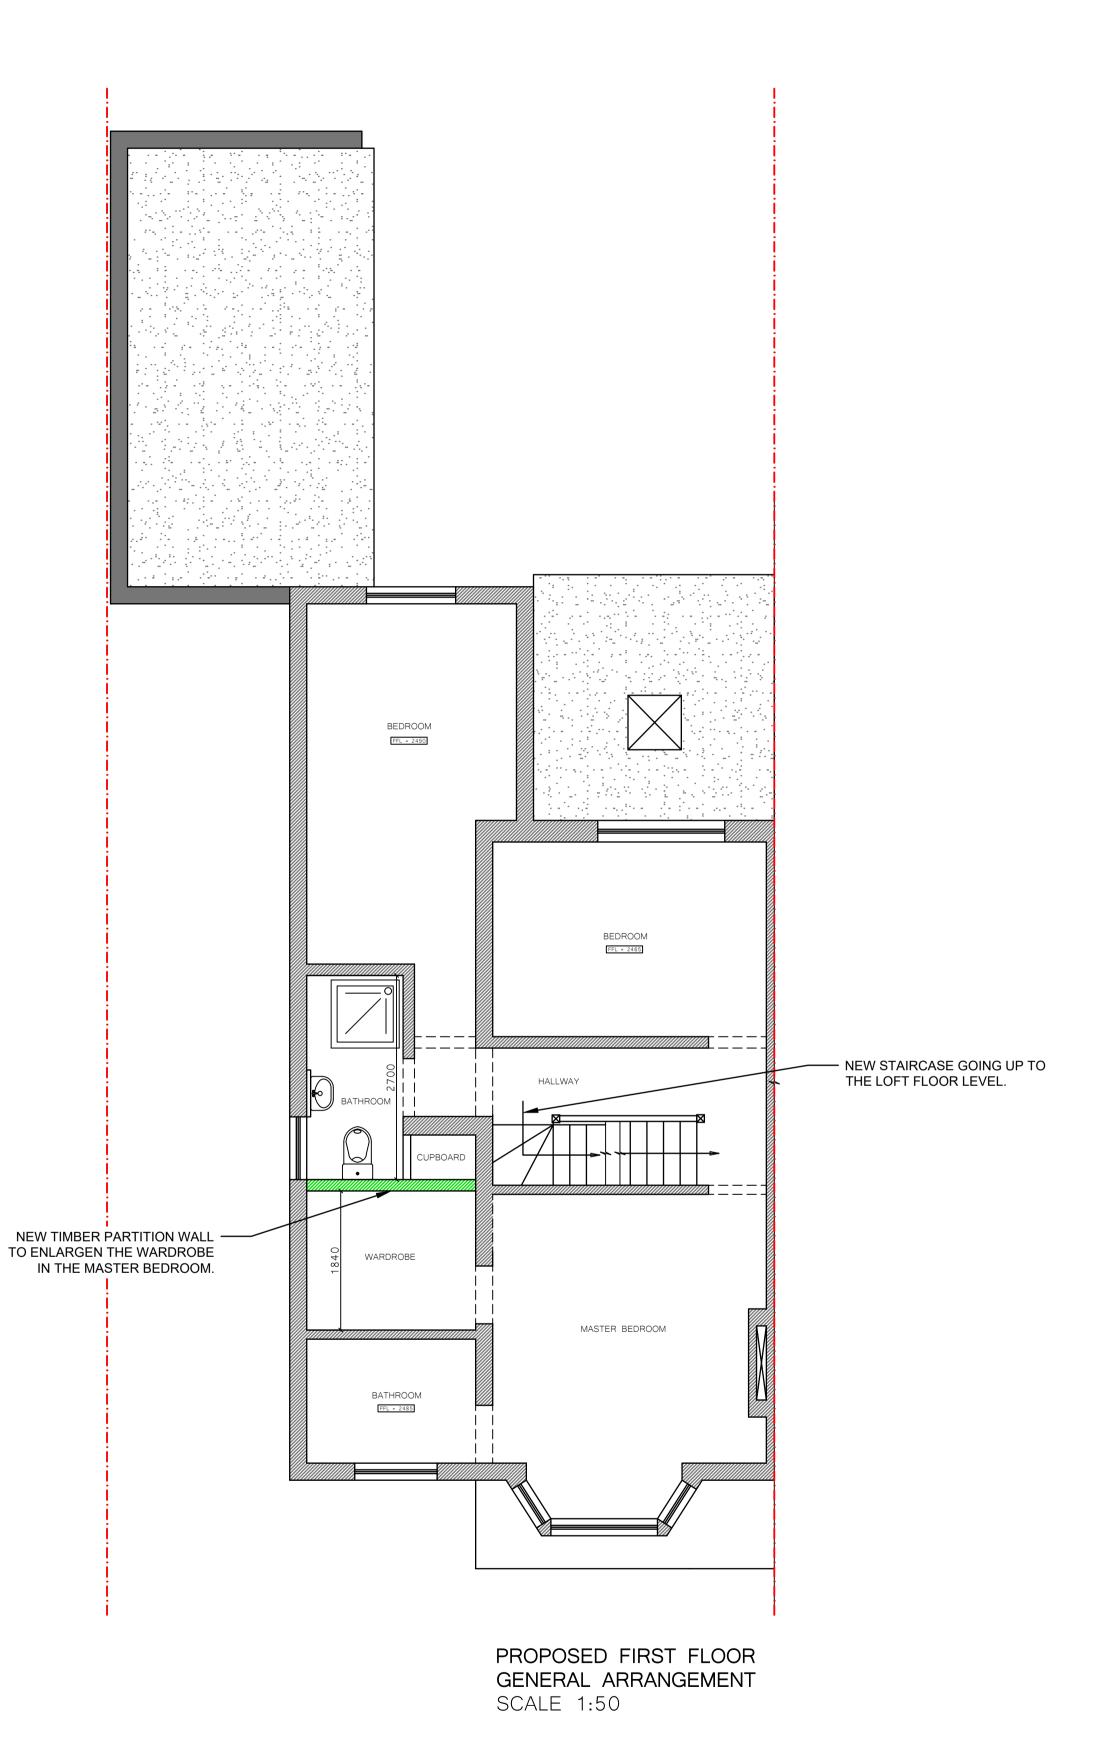

LEGEND SYMBOL EXISTING SOLID WALL WALL TO BE REMOVED WALL TO BE CONSTRUCTED BRICKWORK WALL BLOCKWORK WALL NON LOAD-BEARING WALLS TIMBER STUD LOAD-BEARING WALLS INDICATES EXISTING CEILING BEAMS B1 PROPOSED STEEL BEAM (1) PROPOSED LINTEL (1) PROPOSED STEEL COLUMN (1) PROPOSED TIMBER MEMBER (T1) REFERS TO CONCRETE PADSTONE (1) "FFL" FINISHED FLOOR TO CEILING HEIGHT "SFL" STRUCTURAL FLOOR TO CEILING HEIGHT LOFT HATCH **-** J1 DIRECTION OF TIMBER FLOOR JOISTS (1) DIRECTION OF TIMBER ROOF RAFTERS (1) DIRECTION OF CONCRETE SLAB (1) DIRECTION OF STAIRS GOING UP ____ INDICATES PERIMETER OF NEW FOUNDATIONS A A REFERS TO SECTION "A" FROM SHEET 01

REFERS TO DETAIL "YY"

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PRIOR TO LOADING.



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ENGINEER (KEC) MUST BE INFORMED



P01 30/04/24 DRAWINGS APPROVED FOR PLANNING. FINAL (2) DRAWINGS APPROVAL FOR PLANNING SUBMISION. D04 26/04/24 FINAL DRAWINGS APPROVAL FOR PLANNING SUBMISION. D03 25/04/24 CHANGES TO THE ROOF PITCH AND LOFT ARRANGEMENT. D02 19/04/24 D01 12/04/24 FIRST ISSUE - FOR APPROVAL

Rev. Client

Date

MR FOROOZ GHASSEMI

Details of Revision

Project Title

40 GREAT BUSHEY DRIVE, LONDON, N20 8QL

Drawing Title

PLANNING LOFT CONVERSION EXISTING AND PROPOSED FIRST FLOOR GENERAL ARRANGEMENT




Address: 218 Summers Lane, North Finchley, London N12 OJY

PLANNING

Designed By		Date	Checked By	Date
RK		12/04/24	RK	12/04/24
File No.	200 01		Scale	NOATED
	390-01		AS INL	DICATED

390-01-FOZ-RES-APP-01 3 of 10

LINEAR SCALES 20m 40m 60m 1:500 -1:50

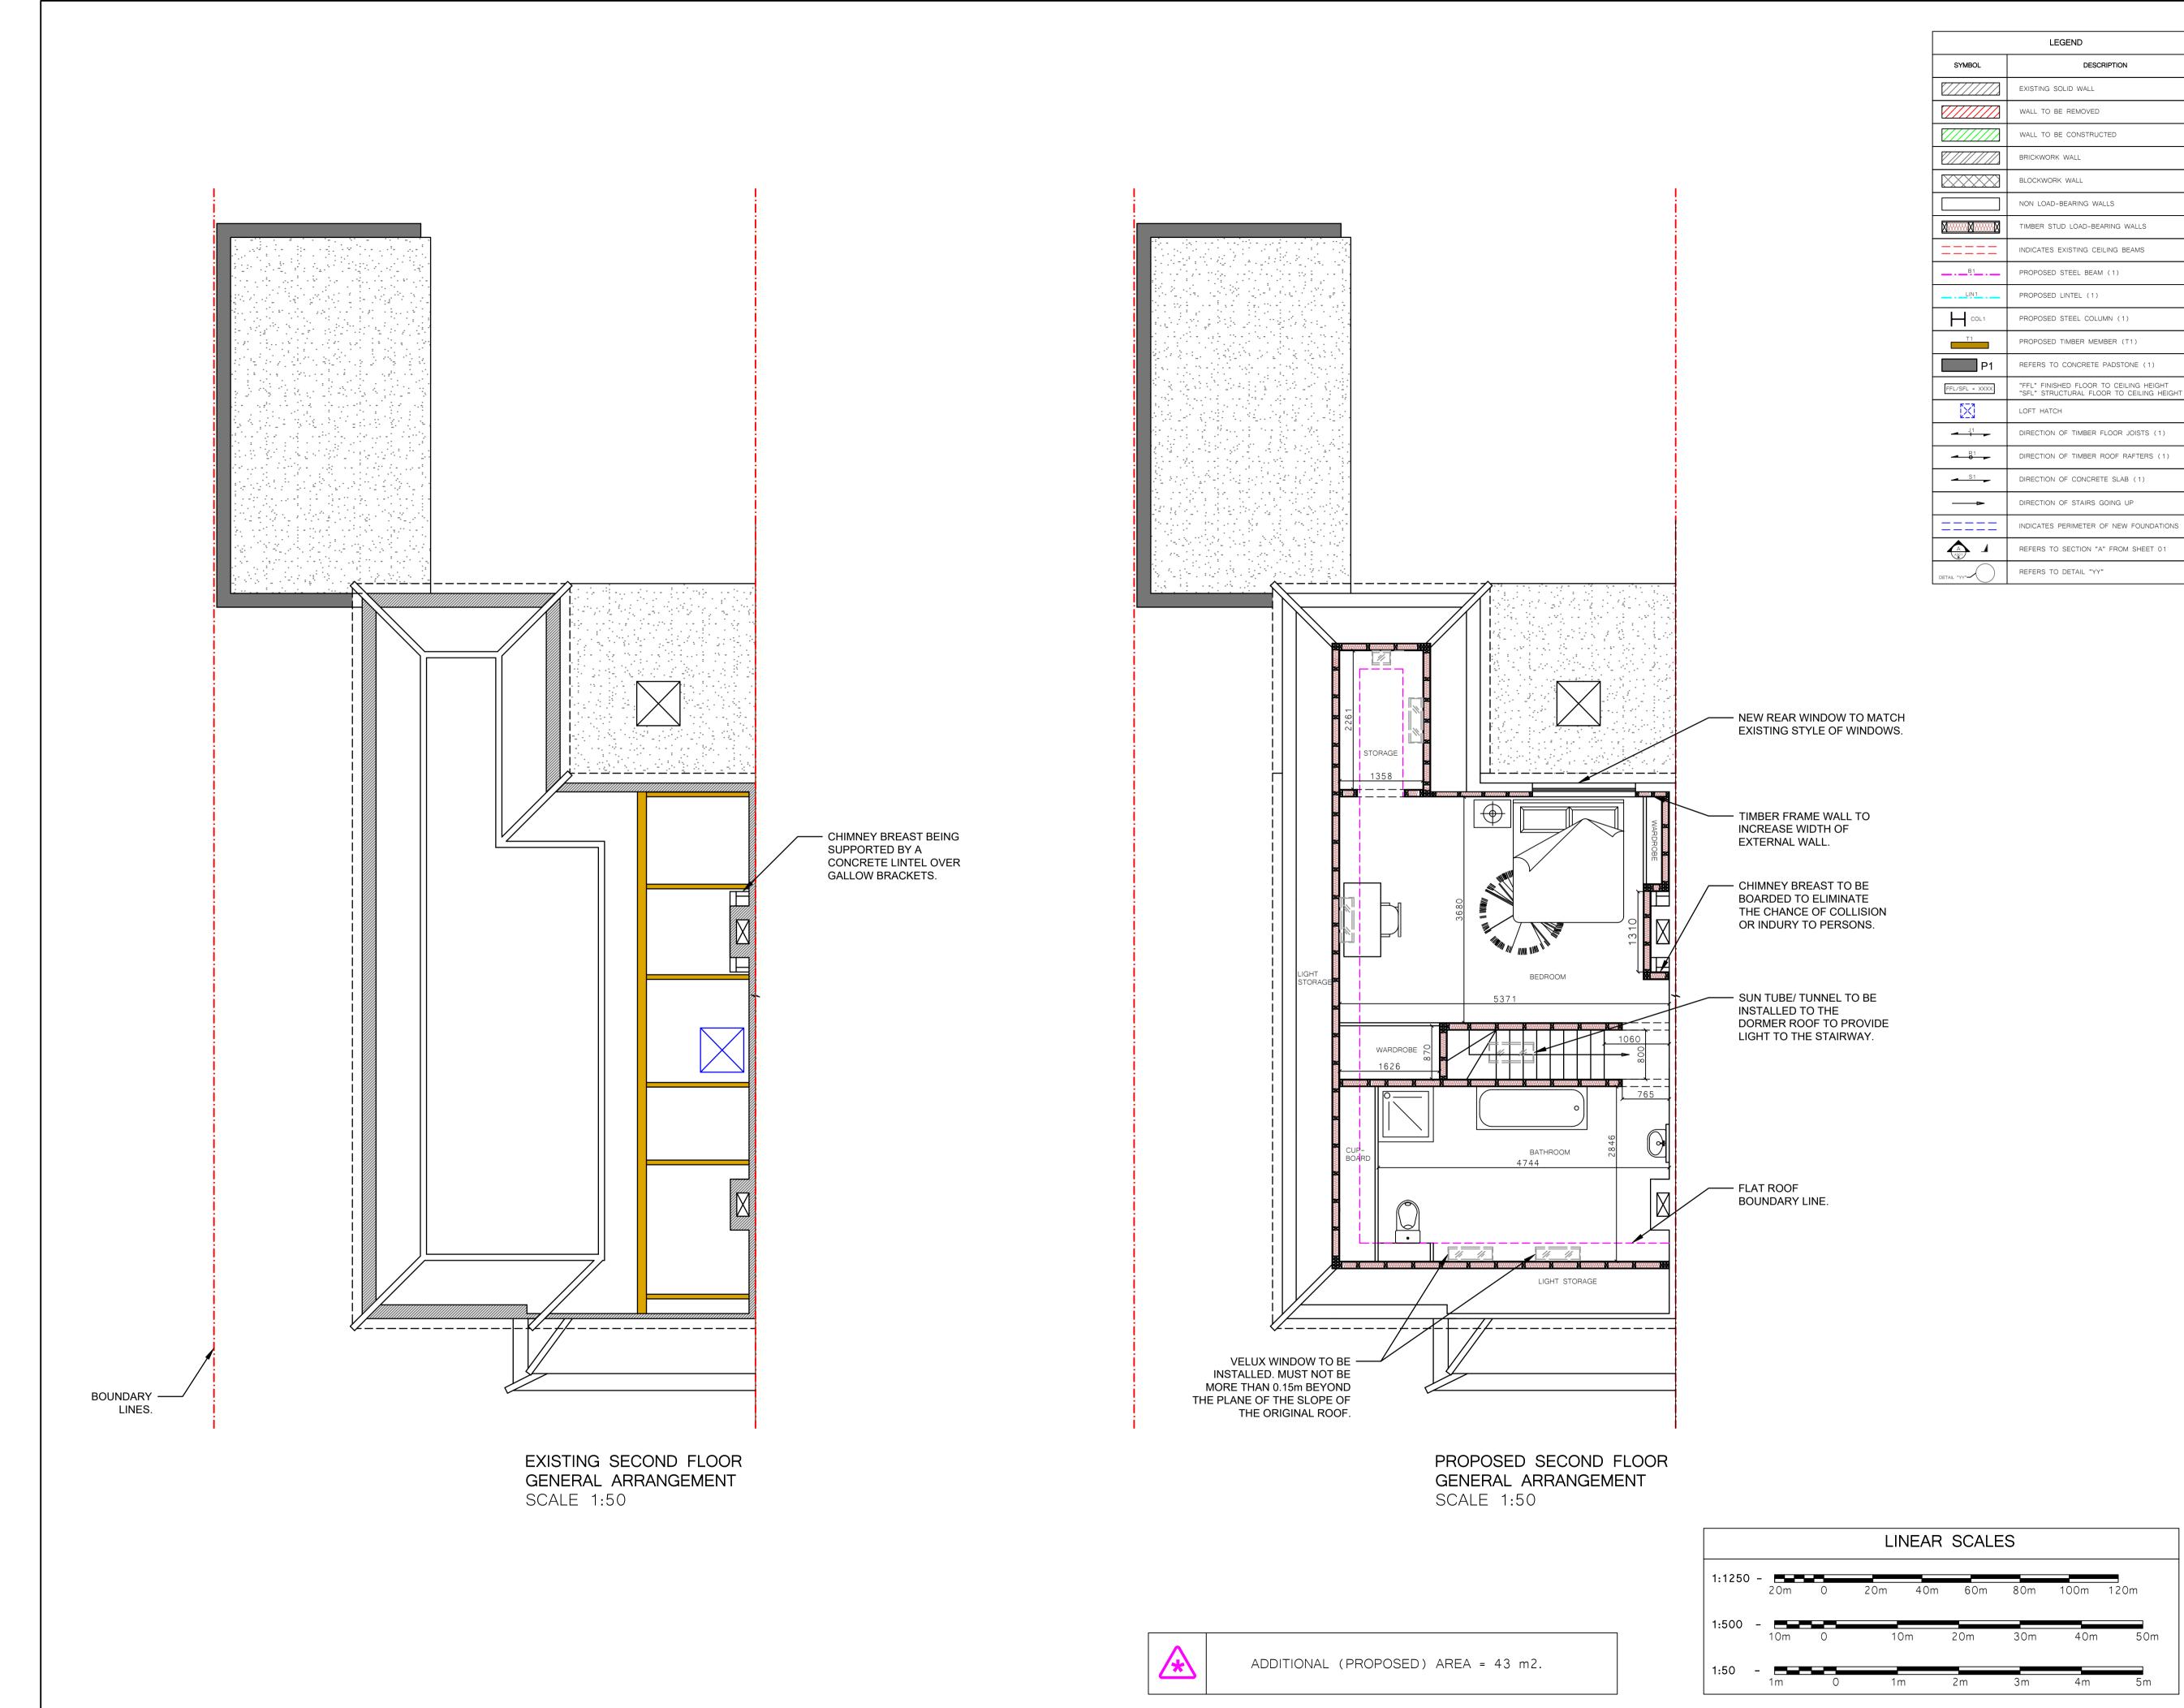

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PRIOR TO LOADING.



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Rev.	Date	Details of Revision
D01	12/04/24	FIRST ISSUE - FOR APPROVAL
D02	19/04/24	CHANGES TO THE ROOF PITCH AND LOFT ARRANGEMENT.
D03	25/04/24	FINAL DRAWINGS APPROVAL FOR PLANNING SUBMISION.
D04	26/04/24	FINAL (2) DRAWINGS APPROVAL FOR PLANNING SUBMISION.
P01	30/04/24	DRAWINGS APPROVED FOR PLANNING.

MR FOROOZ GHASSEMI

Project Title

40 GREAT BUSHEY DRIVE, LONDON, N20 8QL

Drawing Title

PLANNING LOFT CONVERSION EXISTING AND PROPOSED ARRIC/ LOFT FLOOR GENERAL ARRANGEMENT



Address: 218 Summers Lane, North Finchley, London N12 OJY


Contact Number: 07722092043 Email: info@kolekaengineering.co.uk Website: www.kolekaengineering.co.uk

PLANNING

Designed By RK 12/04/24 12/04/24 Scale AS INDICATED File No.

390-01


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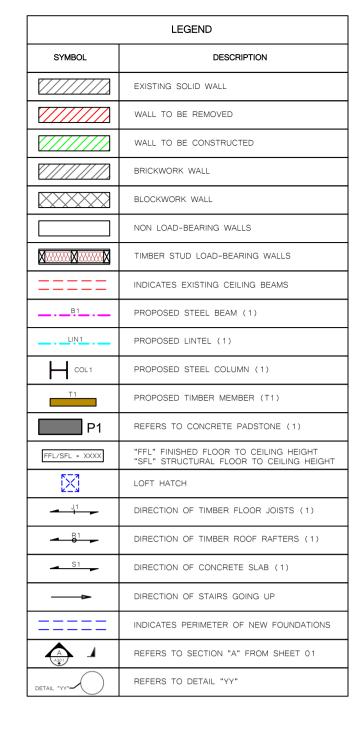


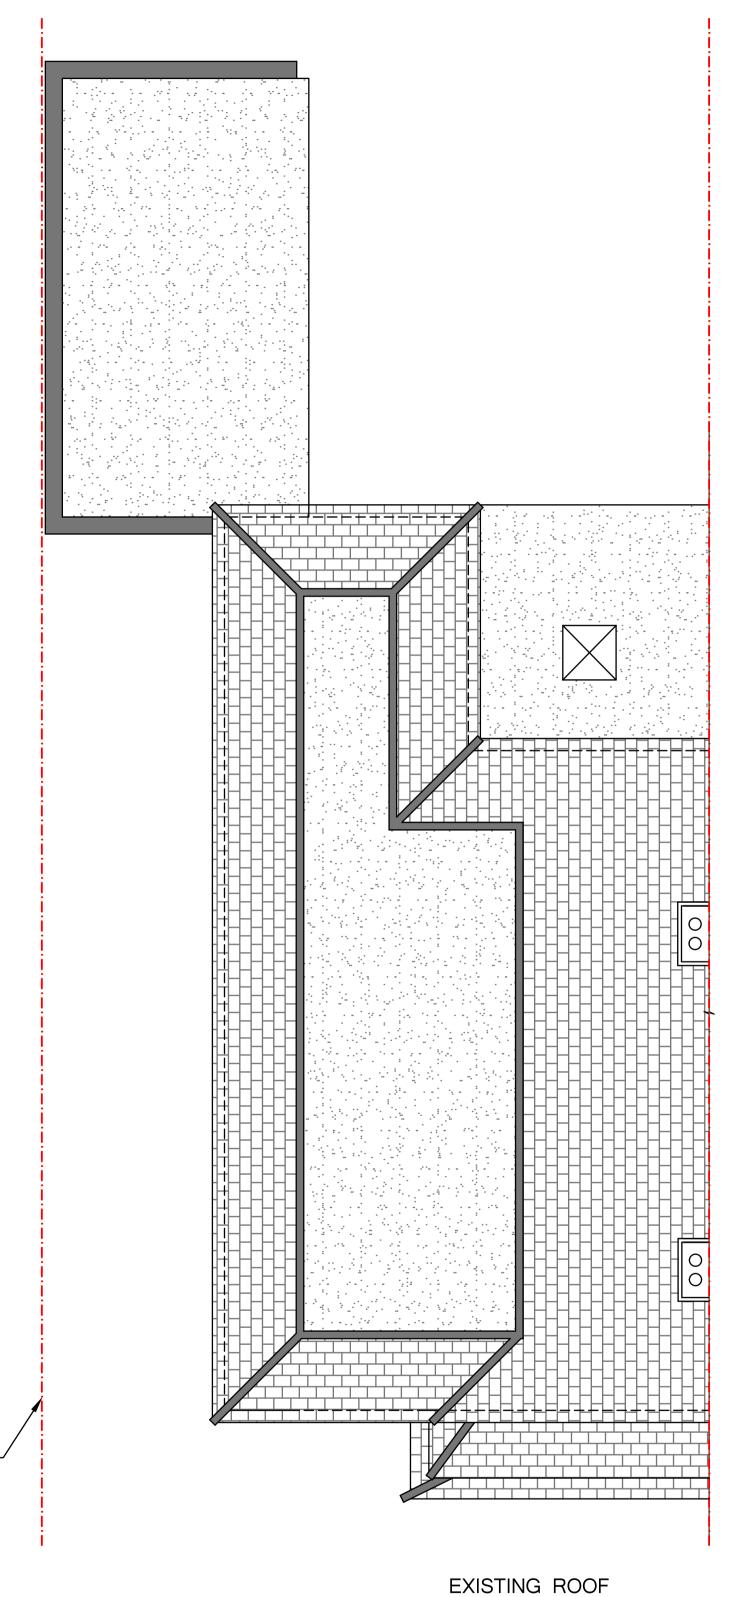BOUNDARY


LINES.

EXISTING ROOF
GENERAL ARRANGEMENT
SCALE 1:50



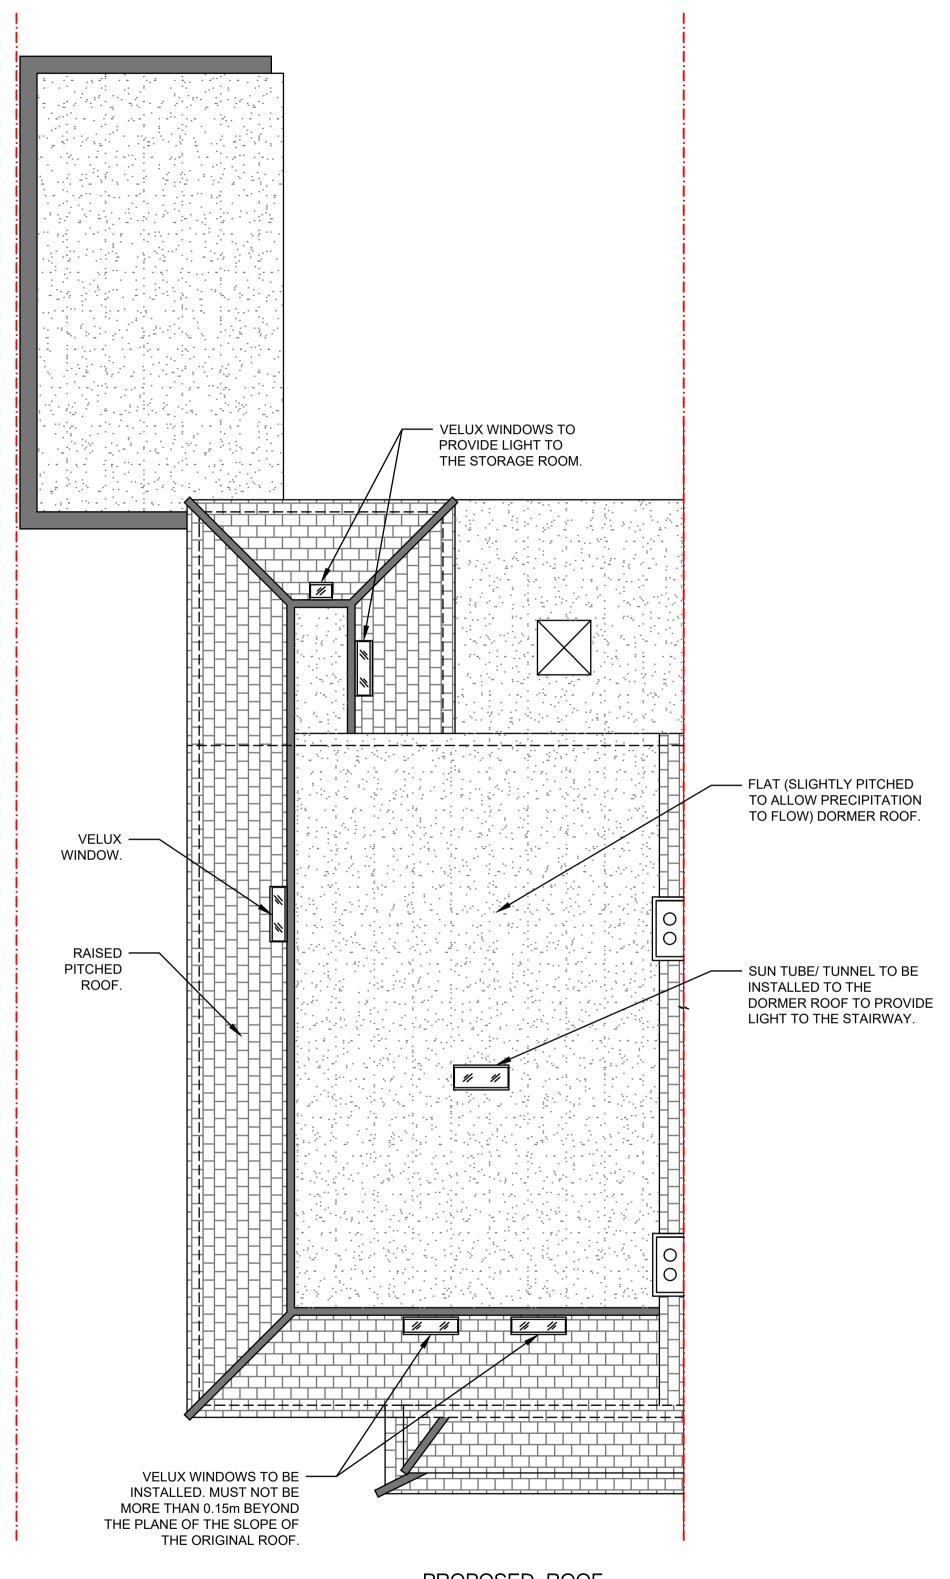

PROPOSED ROOF
GENERAL ARRANGEMENT
SCALE 1:50

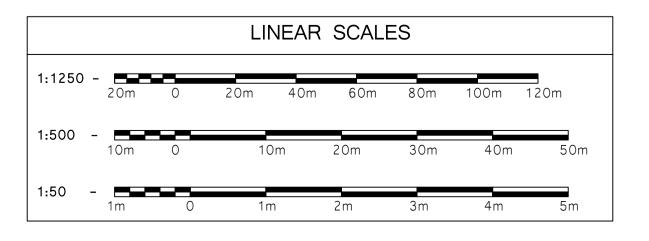

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PRIOR TO LOADING.



9. ITEMS OF IMPORTANCE HIGHLIGHTED THUS:



P01	30/04/24	DRAWINGS APPROVED FOR PLANNING.
D04	26/04/24	FINAL (2) DRAWINGS APPROVAL FOR PLANNING SUBMISION.
D03	25/04/24	FINAL DRAWINGS APPROVAL FOR PLANNING SUBMISION.
D02	19/04/24	CHANGES TO THE ROOF PITCH AND LOFT ARRANGEMENT.
D01	12/04/24	FIRST ISSUE - FOR APPROVAL

ENGINEER (KEC) MUST BE INFORMED

Rev. Date

MR FOROOZ GHASSEMI

Details of Revision

Project Title

40 GREAT BUSHEY DRIVE, LONDON, N20 8QL

Drawing Title

PLANNING LOFT CONVERSION
EXISTING AND PROPOSED ROOF FLOOR
GENERAL ARRANGEMENT



Status

PLANNING


Designed By		Date	Checked By	Date
RK		12/04/24	RK	12/04/24
File No.	90-01		Scale AS IND	DICATED

 Drawing No.
 Sheet No.
 Rev No.

 390-01-FOZ-RES-APP-01
 5 of 10
 P0




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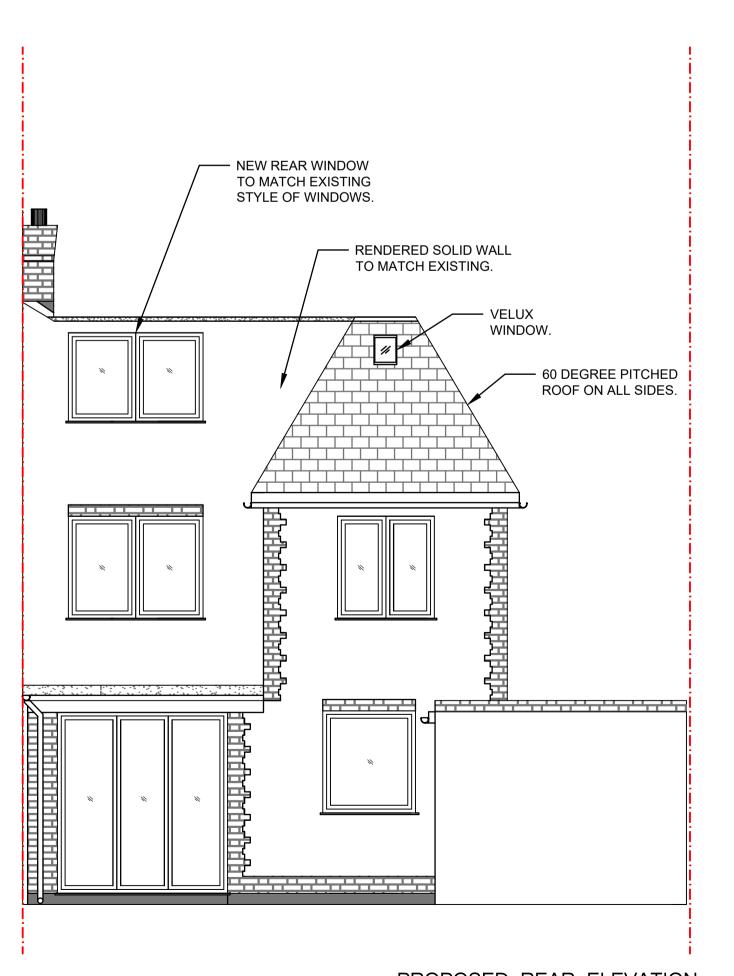
BOUNDARY -LINES.

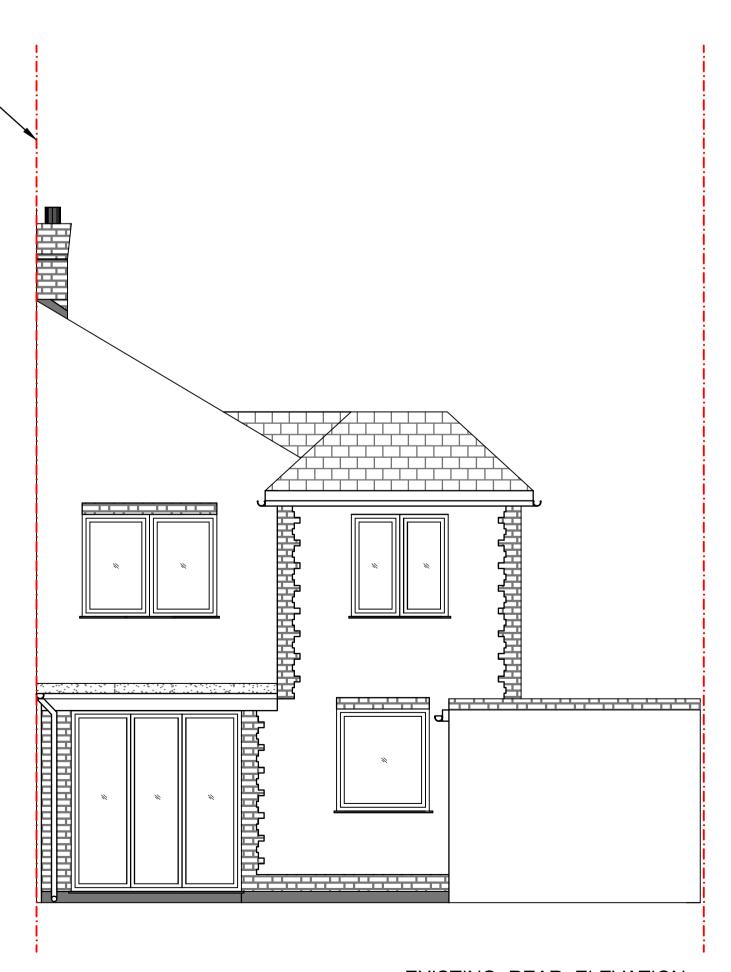EXISTING REAR ELEVATION

SCALE 1:50



PROPOSED FRONT ELEVATION SCALE 1:50

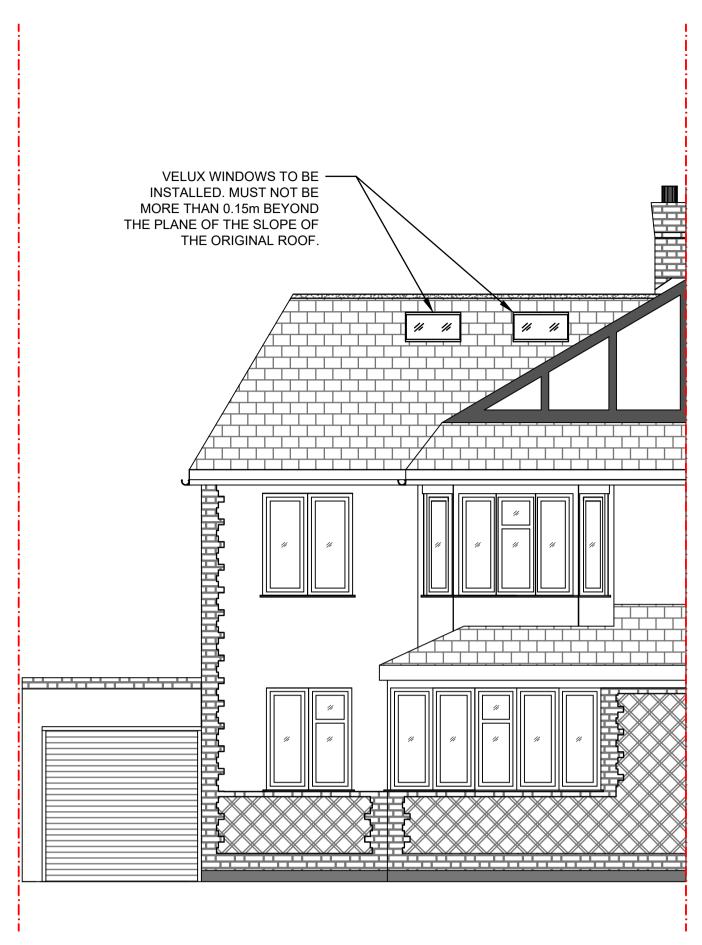

PROPOSED REAR ELEVATION

SCALE 1:50

	LEGEND		
SYMBOL	DESCRIPTION		
	EXISTING SOLID WALL		
	WALL TO BE REMOVED		
	WALL TO BE CONSTRUCTED		
	BRICKWORK WALL		
	BLOCKWORK WALL		
	NON LOAD-BEARING WALLS		
XXX	TIMBER STUD LOAD-BEARING WALLS		
=====	INDICATES EXISTING CEILING BEAMS		
B1	PROPOSED STEEL BEAM (1)		
LIN1	PROPOSED LINTEL (1)		
COL1	PROPOSED STEEL COLUMN (1)		
T1	PROPOSED TIMBER MEMBER (T1)		
P1	REFERS TO CONCRETE PADSTONE (1)		
FFL/SFL = XXXX	"FFL" FINISHED FLOOR TO CEILING HEIGHT "SFL" STRUCTURAL FLOOR TO CEILING HEIGHT		
\boxtimes	LOFT HATCH		
J1	DIRECTION OF TIMBER FLOOR JOISTS (1)		
- R1	DIRECTION OF TIMBER ROOF RAFTERS (1)		
S1	DIRECTION OF CONCRETE SLAB (1)		
→	DIRECTION OF STAIRS GOING UP		
=====	INDICATES PERIMETER OF NEW FOUNDATIONS		
A A	REFERS TO SECTION "A" FROM SHEET 01		
DETAIL "YY"	REFERS TO DETAIL "YY"		

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- 8. HAZARDS IDENTIFIED THUS:



9. ITEMS OF IMPORTANCE HIGHLIGHTED THUS:



10. CHECK COMPONENTS AS SUPPLIED MATCH DRAWINGS. WHERE SUBSTITUTIONS ARE MADE, THE ENGINEER (KEC) MUST BE INFORMED PRIOR TO LOADING.

P01	30/04/24	DRAWINGS APPROVED FOR PLANNING.
D04	26/04/24	FINAL (2) DRAWINGS APPROVAL FOR PLANNING SUBMISION.
D03	25/04/24	FINAL DRAWINGS APPROVAL FOR PLANNING SUBMISION.
D02	19/04/24	CHANGES TO THE ROOF PITCH AND LOFT ARRANGEMENT.
D01	12/04/24	FIRST ISSUE - FOR APPROVAL
Rev.	Date	Details of Revision

Client

MR FOROOZ GHASSEMI

Project Title

LINEAR SCALES

40m 60m

20m

1:500

1:50

40 GREAT BUSHEY DRIVE, LONDON, N20 8QL

Drawing Title

PLANNING LOFT CONVERSION EXISTING AND PROPOSED FRONT & REAR ELEVATIONS



Address: 218 Summers Lane, North Finchley, London N12 OJY


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PLANNING


6 of 10

P01


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	RK	12/04/24	RK	12/04/24
File No.	390-01		Scale AS IND	DICATED
Drawing 1	No		Sheet No.	Rev No

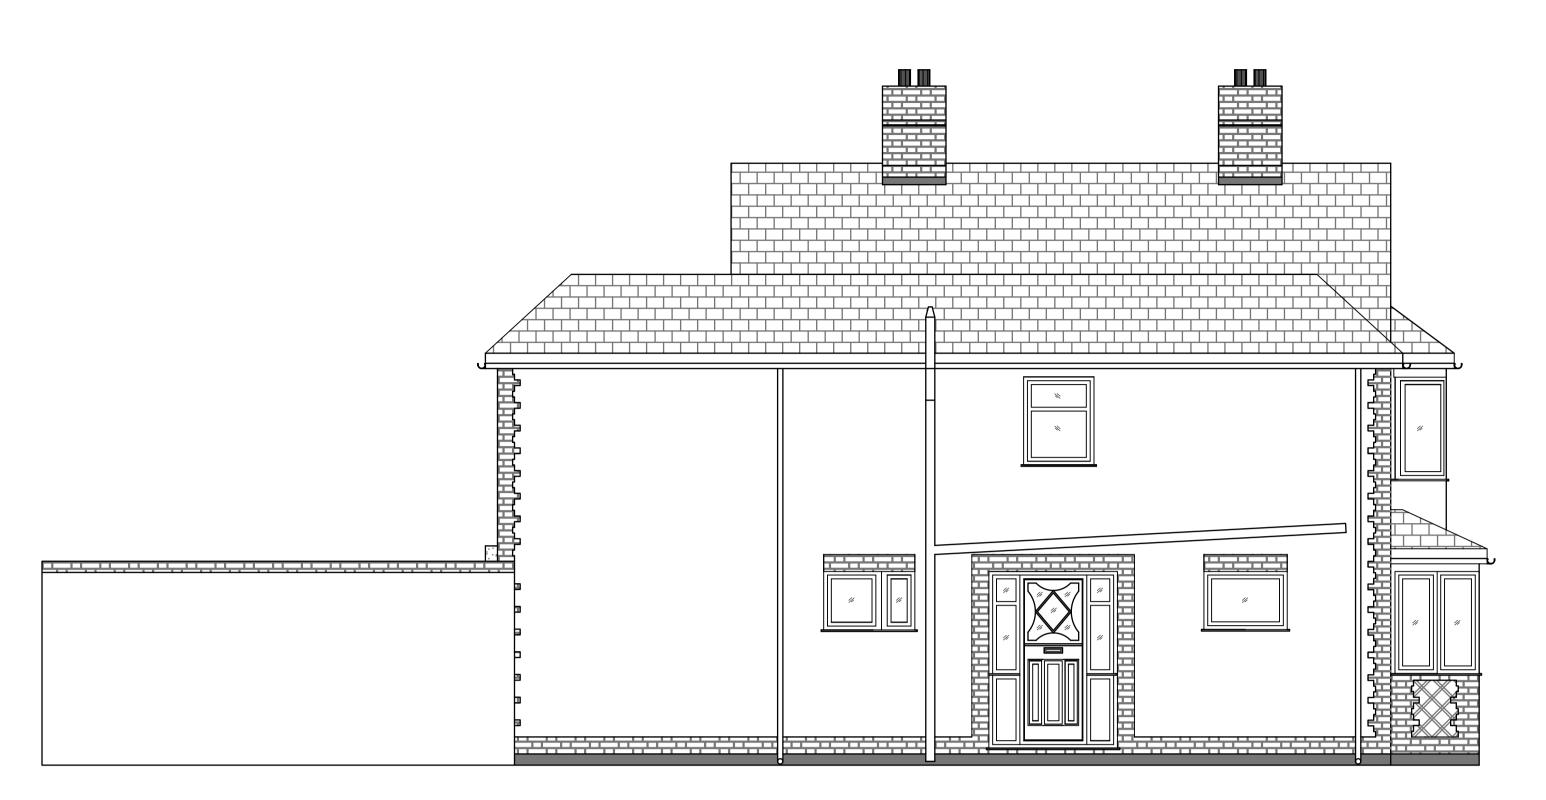

EXISTING EAST SIDE ELEVATION SCALE 1:50

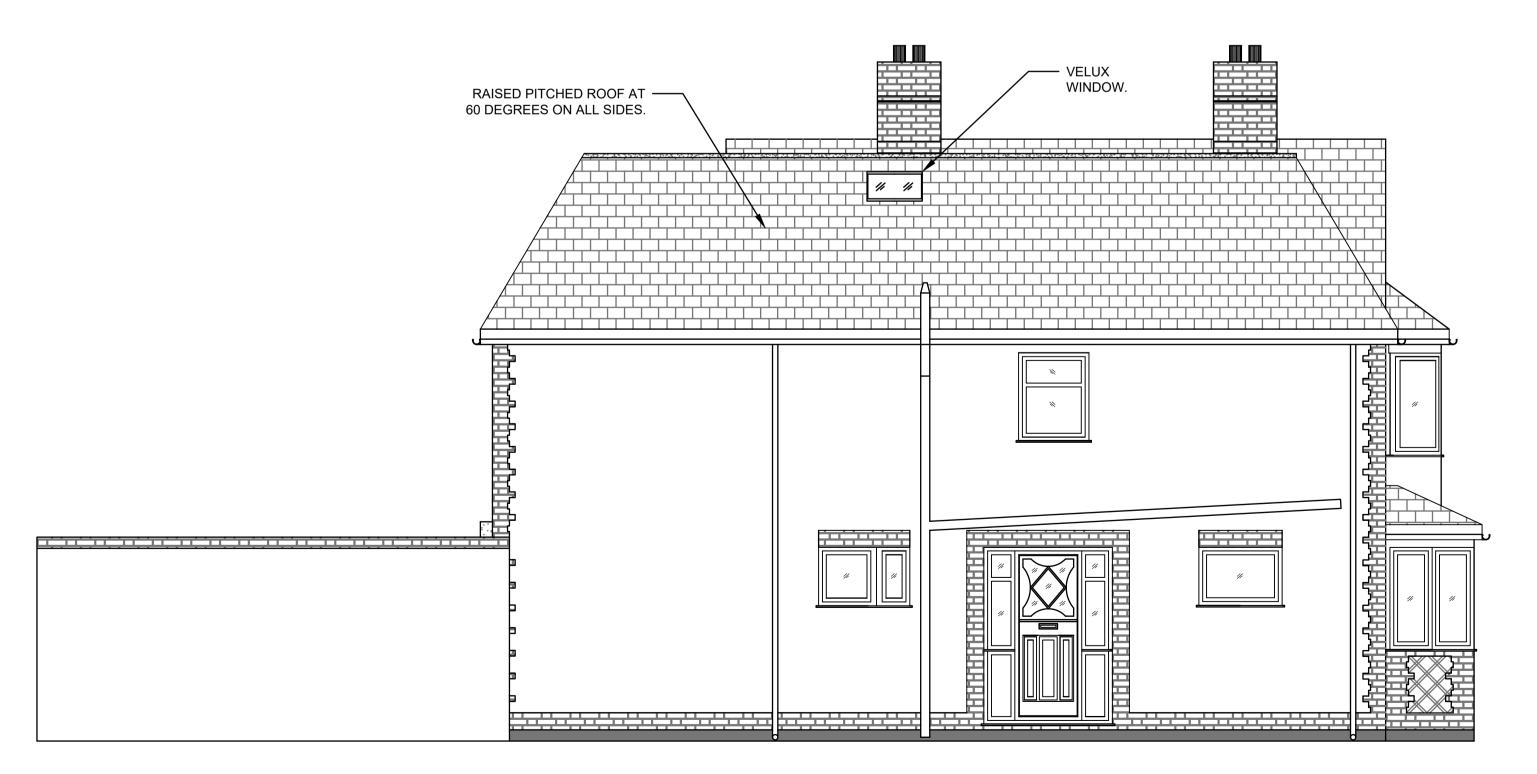

PROPOSED EAST SIDE ELEVATION SCALE 1:50

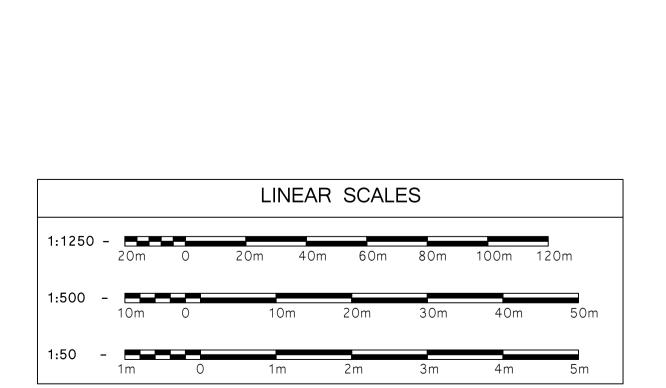

General Notes LEGEND THIS DRAWING IS THE PROPERTY OF KOLEKA ENGINEERING CONSULTANTS (KEC) LIMITED AND NO REPRODUCTION OR DISCLOSURE EXISTING SOLID WALL THEREOF MAY BE MADE IN WHOLE OR IN WALL TO BE REMOVED PART WITHOUT WRITTEN PERMISSION. WALL TO BE CONSTRUCTED THIS DRAWING HAS BEEN PREPARED FROM INFORMATION SUPPLIED TO US BY OUR BRICKWORK WALL CLIENT/ THE CONTRACTOR AND WHERE NECESSARY THROUGH DIRECT SITE BLOCKWORK WALL MEASUREMENT BY KEC. ALL INFORMATION NON LOAD-BEARING WALLS WITHIN THE DRAWING IS SUBJECT TO CHECKING BY OUR CLIENT AND THE TIMBER STUD LOAD-BEARING WALLS CONTRACTOR TO ENSURE THE REQUIREMENTS HAVE BEEN CORRECTLY INDICATES EXISTING CEILING BEAMS INTERPRETED. PROPOSED STEEL BEAM (1) THE CLIENT & CONTRACTOR MUST SATISFY PROPOSED LINTEL (1) THEMSELVES THAT ALL DIMENSIONS AND COORDINATES SUPPLIED ARE CHECKED PROPOSED STEEL COLUMN (1) PRIOR TO CONSTRUCTION. KEC CAN NOT TAKE RESPONSIBILITY FOR THE ACCURACY PROPOSED TIMBER MEMBER (T1) OF THE SUPPLIED DRAWINGS/SURVEYS. REFERS TO CONCRETE PADSTONE (1)

"FFL" FINISHED FLOOR TO CEILING HEIGHT "SFL" STRUCTURAL FLOOR TO CEILING HEIGHT

DIRECTION OF TIMBER FLOOR JOISTS (1)

DIRECTION OF TIMBER ROOF RAFTERS (1)

INDICATES PERIMETER OF NEW FOUNDATIONS

REFERS TO SECTION "A" FROM SHEET 01

DIRECTION OF CONCRETE SLAB (1)

DIRECTION OF STAIRS GOING UP

REFERS TO DETAIL "YY"

LOFT HATCH

SYMBOL

B1_____

____J1

<u>A</u>

Drawing Notes

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- 8. HAZARDS IDENTIFIED THUS:

THUS:

9. ITEMS OF IMPORTANCE HIGHLIGHTED THUS:

10. CHECK COMPONENTS AS SUPPLIED MATCH DRAWINGS. WHERE SUBSTITUTIONS ARE MADE, THE ENGINEER (KEC) MUST BE INFORMED PRIOR TO LOADING.

Rev.		
D01	12/04/24	FIRST ISSUE - FOR APPROVAL
D02	19/04/24	CHANGES TO THE ROOF PITCH AND LOFT ARRANGEMENT.
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D04	26/04/24	FINAL (2) DRAWINGS APPROVAL FOR PLANNING SUBMISION.
P01	30/04/24	DRAWINGS APPROVED FOR PLANNING.

MR FOROOZ GHASSEMI

Project Title

40 GREAT BUSHEY DRIVE, LONDON, N20 8QL

Drawing Title

PLANNING LOFT CONVERSION
EXISTING AND PROPOSED SIDE (FACING EAST) ELEVATION



Address: 218 Summers Lane, North Finchley, London N12 0JY

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Contact Number: 07722092043 Email: info@kolekaengineering.co.uk Website: www.kolekaengineering.co.uk

PLANNING


Designed By	Date	Checked By	Date
RK	12/04/24	RK	12/04/24
File No.		Scale	NOATED

Drawing No.


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Sheet No. Rev No.


390-01-FOZ-RES-APP-01 7 of 10 P01

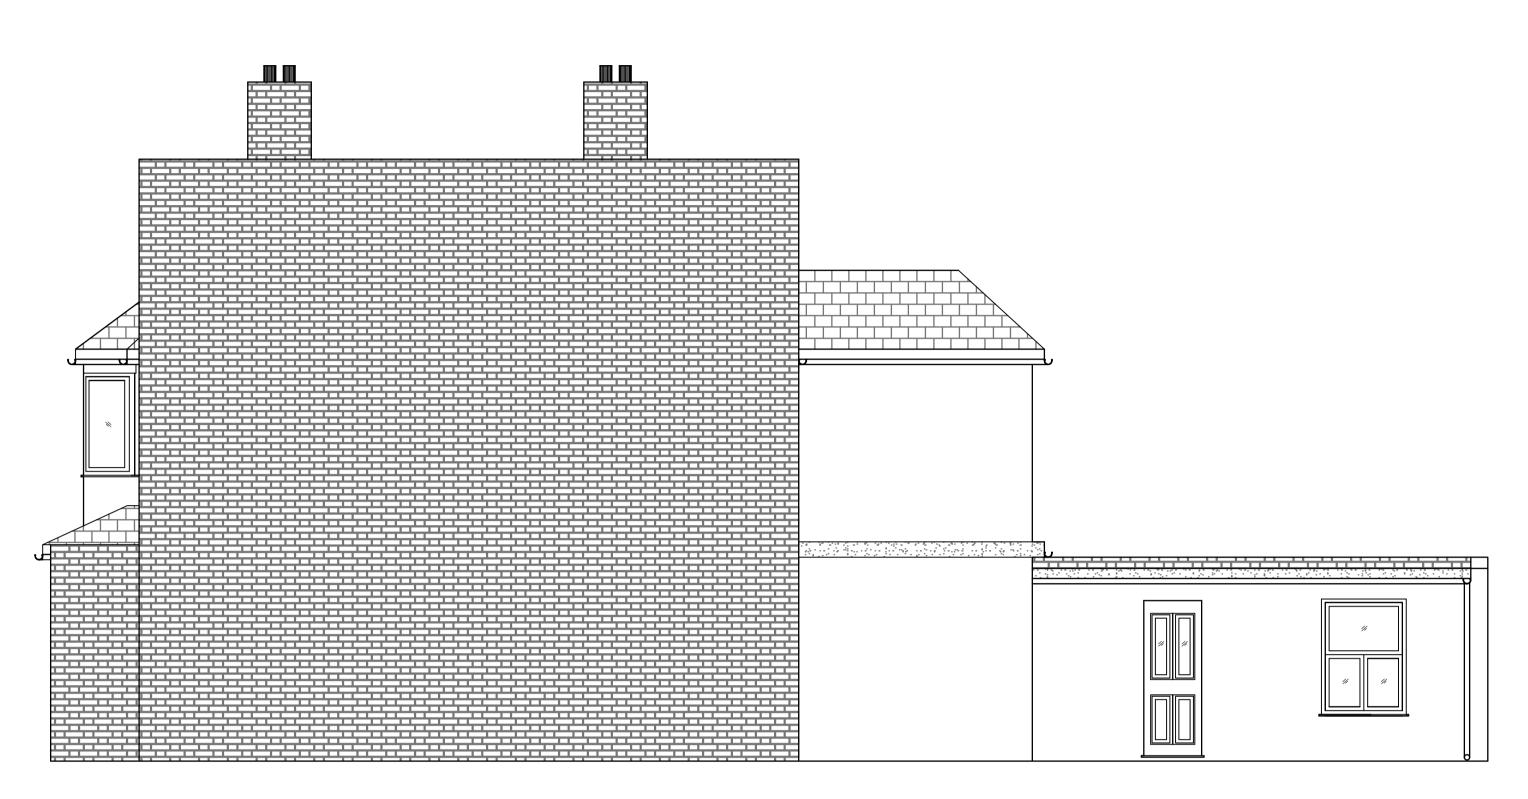

EXISTING WEST SIDE ELEVATION SCALE 1:50

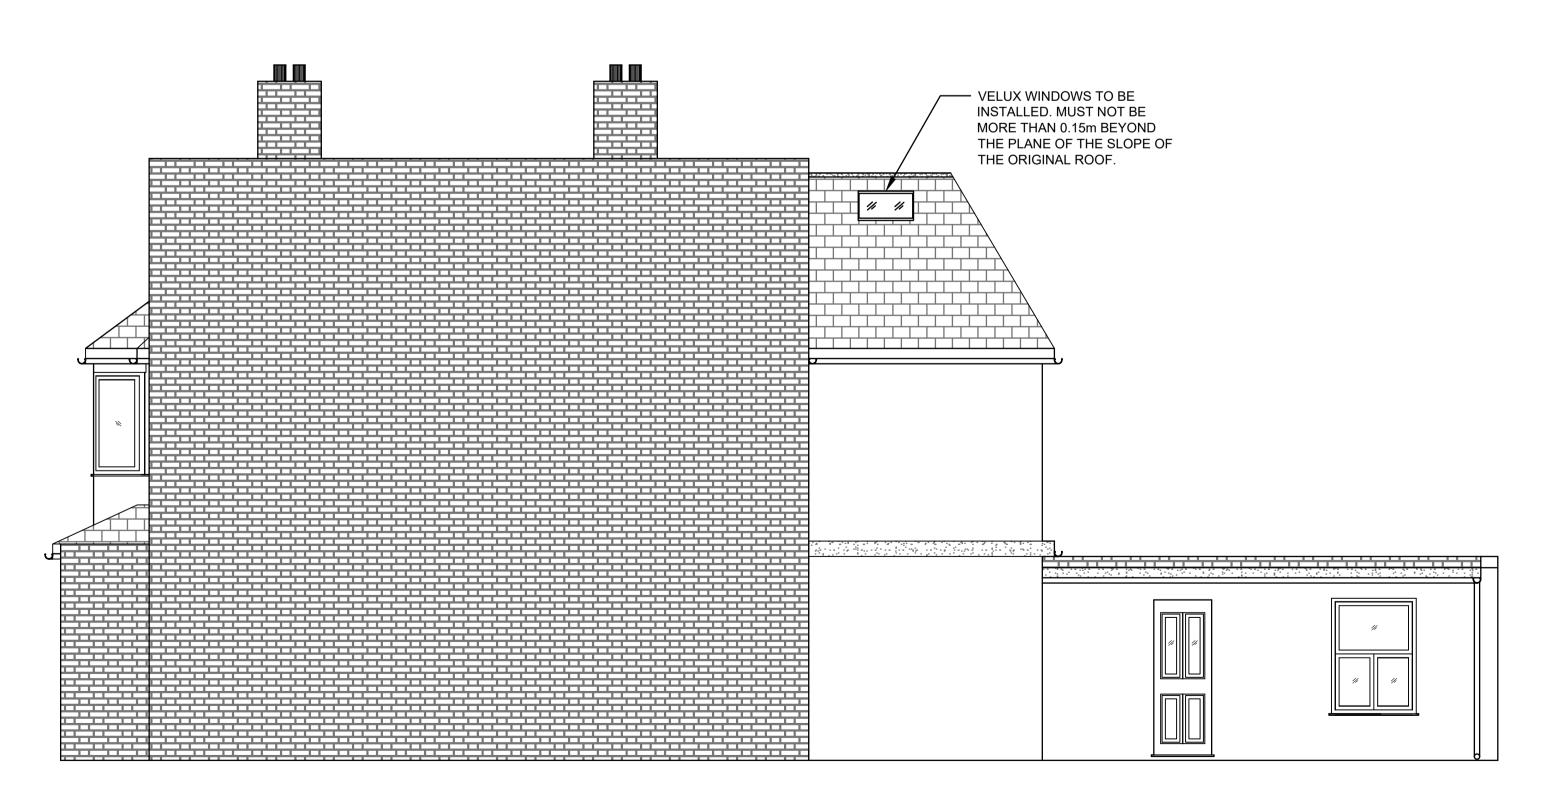

PROPOSED WEST SIDE ELEVATION SCALE 1:50

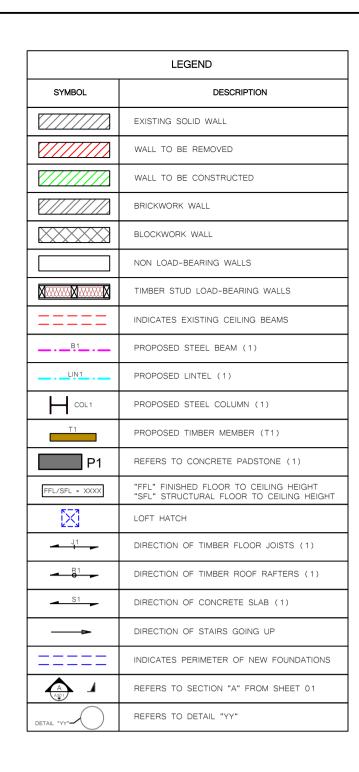

General Notes

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FINAL DRAWINGS APPROVAL FOR

CHANGES TO THE ROOF PITCH

PLANNING SUBMISION.

AND LOFT ARRANGEMENT.

PRIOR TO LOADING. DRAWINGS APPROVED FOR P01 30/04/24 PLANNING. FINAL (2) DRAWINGS APPROVA D04 26/04/24 FOR PLANNING SUBMISION.

SUBSTITUTIONS ARE MADE, THE ENGINEER (KEC) MUST BE INFORMED

D01 12/04/24 | FIRST ISSUE - FOR APPROVAL Rev. Date Details of Revision

MR FOROOZ GHASSEMI

Project Title

Client

D03 25/04/24

D02 19/04/24

40 GREAT BUSHEY DRIVE, LONDON, N20 8QL

Drawing Title

PLANNING LOFT CONVERSION EXISTING AND PROPOSED SIDE (FACING WEST) ELEVATION



LINEAR SCALES

20m 40m 60m

PLANNING


Email: info@kolekaengineering.co.uk


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RK	12/04/24	RK	12/04/24
File No.		Scale	

AS INDICATED 390-01

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PROPOSED SECTION REAR VIEW SCALE 1:50

			LINEAF	R SCALE	ES		
1:1250	20m	0	20m 40m	60m	80m	100m	120m
1:500	10m	0	10m	20m	30m	40m	50m
1:50 -	- 	0	1m	2 m	3 m	4m	

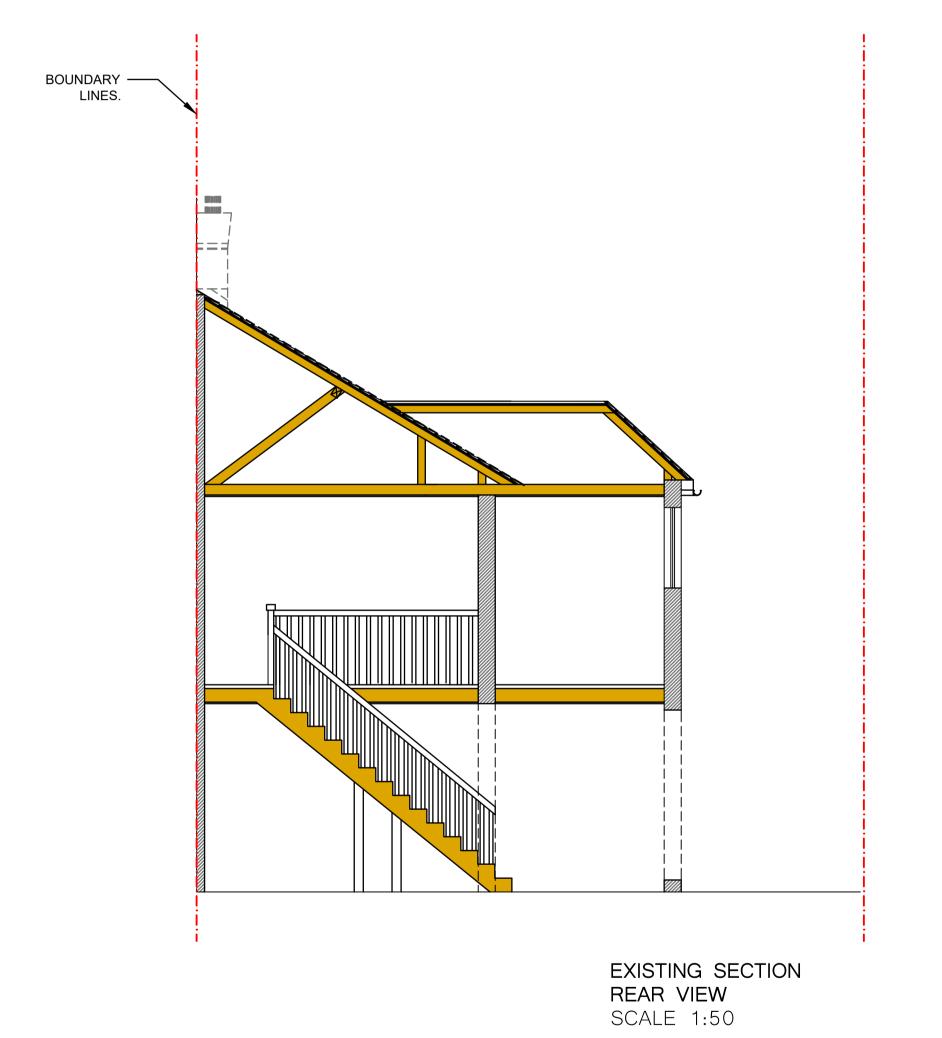LEGEND SYMBOL EXISTING SOLID WALL WALL TO BE REMOVED WALL TO BE CONSTRUCTED BRICKWORK WALL BLOCKWORK WALL NON LOAD-BEARING WALLS TIMBER STUD LOAD-BEARING WALLS INDICATES EXISTING CEILING BEAMS B1 PROPOSED STEEL BEAM (1) PROPOSED LINTEL (1) PROPOSED STEEL COLUMN (1) PROPOSED TIMBER MEMBER (T1) REFERS TO CONCRETE PADSTONE (1) "FFL" FINISHED FLOOR TO CEILING HEIGHT "SFL" STRUCTURAL FLOOR TO CEILING HEIGHT LOFT HATCH DIRECTION OF TIMBER FLOOR JOISTS (1) - J1 -DIRECTION OF TIMBER ROOF RAFTERS (1) DIRECTION OF CONCRETE SLAB (1) DIRECTION OF STAIRS GOING UP

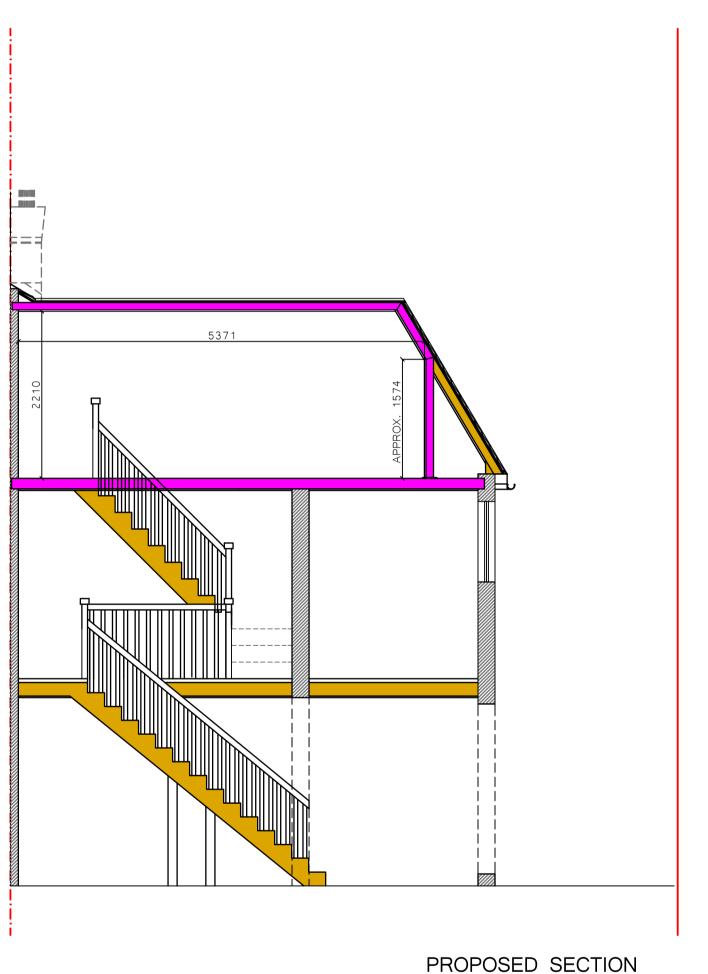INDICATES PERIMETER OF NEW FOUNDATIONS

REFERS TO SECTION "A" FROM SHEET 01

REFERS TO DETAIL "YY"

A 4

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MR FOROOZ GHASSEMI

Project Title

40 GREAT BUSHEY DRIVE, LONDON, N20 8QL

Drawing Title

PLANNING LOFT CONVERSION EXISTING AND PROPOSED SECTION DRAWINGS



Address: 218 Summers Lane, North Finchley, London N12 OJY

9 of 10

Contact Number: 07722092043 Email: info@kolekaengineering.co.uk Website: www.kolekaengineering.co.uk

PLANNING

Designed By		Date	Checked By	Date	
RK		12/04/24	RK	12/04/24	
File No.	390-01		Scale AS INI	DICATED	

390-01-FOZ-RES-APP-01

GENERAL NOTES

- 1) ALL NEW WORK TO BE CARRIED OUT IN ACCORDANCE WITH GOOD BUILDING PRACTICE AND TO COMPLY WITH ALL STATUTORY REQUIREMENTS AND EUROCODE/BRITISH STANDARDS.
- 2) PRIOR TO ANY WORK BEING UNDERTAKEN AND PRIOR TO ANY STEELS BEING ORDERED THE CONTRACTOR MUST EXPOSE AND CHECK THE EXISTING STRUCTURE TO ENSURE THAT ALL PROPOSALS ARE APPROPRIATE TO SUPPORT THE EXISTING STRUCTURE.
- 3) ALL BEAMS TO BE ENCASED WITH 2No. 12.5mm FIRELINE BOARD AND SKIN COAT PLASTER TO GIVE 1 HOUR FIRE PROTECTION.
- 4) ALL ELECTRICAL WORKS TO BE CARRIED OUT BY A COMPETENT PERSON AND AN APPROPRIATE TEST CERTIFICATE TO BE PROVIDED ON COMPLETION OF WORKS. ALL LIGHT FITTINGS TO ACCORD WITH DOMESTIC BUILDING SERVICES COMPLIANCE GUIDE. AT LEAST THREE OUT OF FOUR FITTINGS TO BE LOW ENERGY TYPE I.E. HAVE LUMINOUS EFFICIENTLY OF NOT LESS THAN 45 LUMENS PER CIRCUIT-WATT AND TOTAL OUTPUT GREATER THAN 400 LAMP LUMENS. EXCLUDE LIGHT FITTINGS SUPPLIED BY LESS THAN 5 WATTS FROM OVERALL COUNT.
- 5) REFER TO STRUCTURAL ENGINEERS CALCULATIONS AND DRAWINGS FOR STRUCTURAL CONSTRUCTION NOTES REGARDING ALL MATERIALS AND DETAILING REQUIREMENTS.
- 6) EXTENSION CEILING JOISTS TO BE TIED DOWN TO WALLS SECURELY WITH 30X5X750MM LONG GALVANIZED TWIST STRAPS AND PLUGGED TO BLOCKWORK. STRAPS TO BE FIXED AT EVERY THIRD CEILING JOISTS.
- 7) ALL TIMBERS USED TO BE GRADE C24 UNLESS OTHERWISE STATED. THE SIZES ARE TO BE CONFIRMED BY THE ENGINEER.

STEELWORK

- 1) FOUNDATIONS/WALLS SHALL BE FORMED PRIOR TO INSTALLATION OF BEAMS;
- 2) STEEL GRADES STEEL SHOULD BE GRADE S355 UNLESS AGREED OTHERWISE WITH THE CLIENT/CONTRACTOR/ENGINEER PRIOR. BEAMS SHOULD BE DESIGNED IN ACCORDANCE WITH EUROCODES/ BRITISH STANDARDS;
- 3) BEARING SUPPORTS CONCRETE PADSTONES SHOULD BE PROVIDED AT THE SUPPORTS TO THE ENGINEERS SPECIFICATIONS;
- 4) MINIMUM BEARING LENGTH OF BEAMS SHOULD BE 150mm ON BOTH SIDES; 5) GAPS - BEAM/MASONRY - SHALL BE RAMMED WITH 3:1 SHARP SAND/CEMENT DRY
- PACK OR BUILT UP IN BRICKWORK;

5) GAPS - BEAM/TIMBER - SHALL BE BUILT UP WITH TIMBER BLOCKING.

NEW ROOFS TO BE HIGH PERFORMANCE GRP ROOFING SOLUTION LAID IN ACCORDANCE WITH MANUFACTURERS RECOMMENDATIONS BONDED TO OSB BOARD ON 75MM KINGSPAN KOOLTHERM K107 PITCHED ROOF BOARD INSULATION BEDDED ON VAPOUR CONTROL LAYER ON 12mm MARINE PLYWOOD ON FIRRING PIECES TO PROVIDE A MINIMUM FALL OF 1:40 ON C24 ROOF JOISTS @ 450MM C/CS. INTERNAL FINISH TO BE 12.7MM FOILBACKED PLASTERBOARD AND SKIM COAT PLASTER. U-VALUE - 0.15 W/M2K. ADDITIONAL JOISTS ARE REQUIRED AROUND THE SKYLIGHT PERIMETER (WHERE APPLICABLE).

<u>WALLS</u>

- 1) INTERNAL WALLS TO BE MADE FROM CONCRETE BLOCKS FOR RESIDENTIAL USE OR TIMBER STUDS FOR PARTITION INTERNAL WALLS;
- 2) EXTERNAL WALLS TO COMPRISE OF A SINGLE LAYER OF BLOCKWORK AND A SINGLE LAYER OF BRICKWORK TO FORM PART OF A CAVITY WALL CONSTRUCTION. TYPICAL CAVITY THICKNESS WILL BE ADOPTED:
- 3) EXTERNAL WALLS TO HAVE REQUIRED INSULTATION TO ACHIEVE A MAX. U-VALUE OF 0.18 W/m2.k.

WINDOWS

- 1) TO BE INSTALLED AS PER THE MANUFACTURERS SPECIFICATIONS AND GUIDELINES;
- 2) MUST BE INSTALLED AS PER THE UK BUILDING REGULATIONS AND FROM A HEIGHT FROM FLOOR LEVEL OF NO MORE THAN 1.1m AND;
- 3) WINDOWS MUST ACHIEVE A MAX. U-VALUE OF 1.40 W/m2.k.

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L			

Client

MR FOROOZ GHASSEMI

Project Title

40 GREAT BUSHEY DRIVE, LONDON, N20 8QL

Drawing Title

PLANNING LOFT CONVERSION PLANNING NOTES



Address: 218 Summers Lane, North Finchley, London N12 OJY

Contact Number: 07722092043 Website: www.kolekaengineering.co.uk

PLANNING

Designed By RK 12/04/24 12/04/24

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